

## **REQUEST FOR COMMITTEE ACTION**

### **HENDERSON COUNTY TECHNICAL REVIEW COMMITTEE**

**MEETING DATE:** January 17, 2023

**SUBJECT:** Revised Master & Phase 3 Development Plan for Sprout (formerly Rich) Mountain Major Subdivision (2021-M09)

**STAFF CONTACT:** Matt Champion, Zoning Administrator

**ATTACHMENTS:**

1. Staff Report
2. Original Combined Master & Phase 1 Development Plan
3. Revised Master Plan & Phase 3 Development Plan

#### **SUMMARY OF REQUEST:**

A Revised Master Plan and a Phase 3 Development Plan was received on behalf of Ripple Falls LLC, by John Kinnaird of Brooks Engineering on December 15, 2022. The revised Master Plan shows an additional 23 single-family lots in Phase 3 for a total of 83 single-family lots. The subject area is located north of Locust Grove Baptist Church off Locust Grove Road (SR 1528) in Hoopers Creek Township. The site consists of 377.96 acres and is accessed through New Sprout Ln.

#### **TECHNICAL REVIEW COMMITTEE ACTION REQUESTED:**

Staff has found that the Master and Development Plan meet the standards of the subdivision regulations of Chapter 42, Henderson County Land Development Code (LDC). Staff recommends the Revised Master Plan and Phase Development Plan be subject to the developer addressing any issues raised by the TRC and addressing the comments listed in the Staff Report.

#### **Suggested Motion:**

I move that the TRC forward the Revised Master Plan and Phase 3 Development Plan on to the Planning Board for further review if they meet all technical requirements based on the Henderson County Land Development Code, recommendations of the Henderson County Comprehensive Plan, and any conditions in the staff report or as discussed by the TRC.



# STAFF REPORT

## HENDERSON COUNTY PLANNING DEPARTMENT

100 North King Street | Hendersonville, NC 28792 | (828) 697-4819

**Prepared by:**  
Henderson County Planning & Zoning Departments


CASE	TRC MEETING DATE
2021-M09 Revised Master Plan & Phase III Development Plan	January 17, 2022
PROPERTY OWNER/APPLICANT	PROPERTY LOCATION/ADDRESS
Ripple Falls LLC	North of Locust Grove Road (SR 1528), off New Sprout Lane, Hoopers Creek Township
AGENT/ENGINEER	PIN(s)
John Kinnaird, PE & Zachary Wortman, EIT Brooks Engineering	9672-53-0112, 9672-32-9718, 9672-32-9259, 9672-22-0858, 9672-23-1444, 9672-22-0353, 9672-21-2880

**SUMMARY OF REQUEST** An application for a Revised Master Plan and the Phase III Development Plan, for Sprout Mountain (formerly Rich Mountain) Major Subdivision, consisting of a total of 83 lots located at the above PIN(s), with 32 new lots proposed in Phase III.


<b>Existing Zoning</b>	Residential District Three (R3)
<b>Existing Land Use</b>	Rural Agricultural Area / Conservation
<b>Site Improvements</b>	Paved Roads
<b>Request Acreage</b>	377.96 acres, +/-

ADJACENT ZONING		USE OF LAND
North	Residential District Three (R3)	Vacant Land
East	Residential District Three (R3)	Vacant Land
South	Residential District Three (R3)	Locust Grove Baptist Church
West	Residential District Three (R3)	Vacant Land/Couch Mountain


Map A: Aerial Map

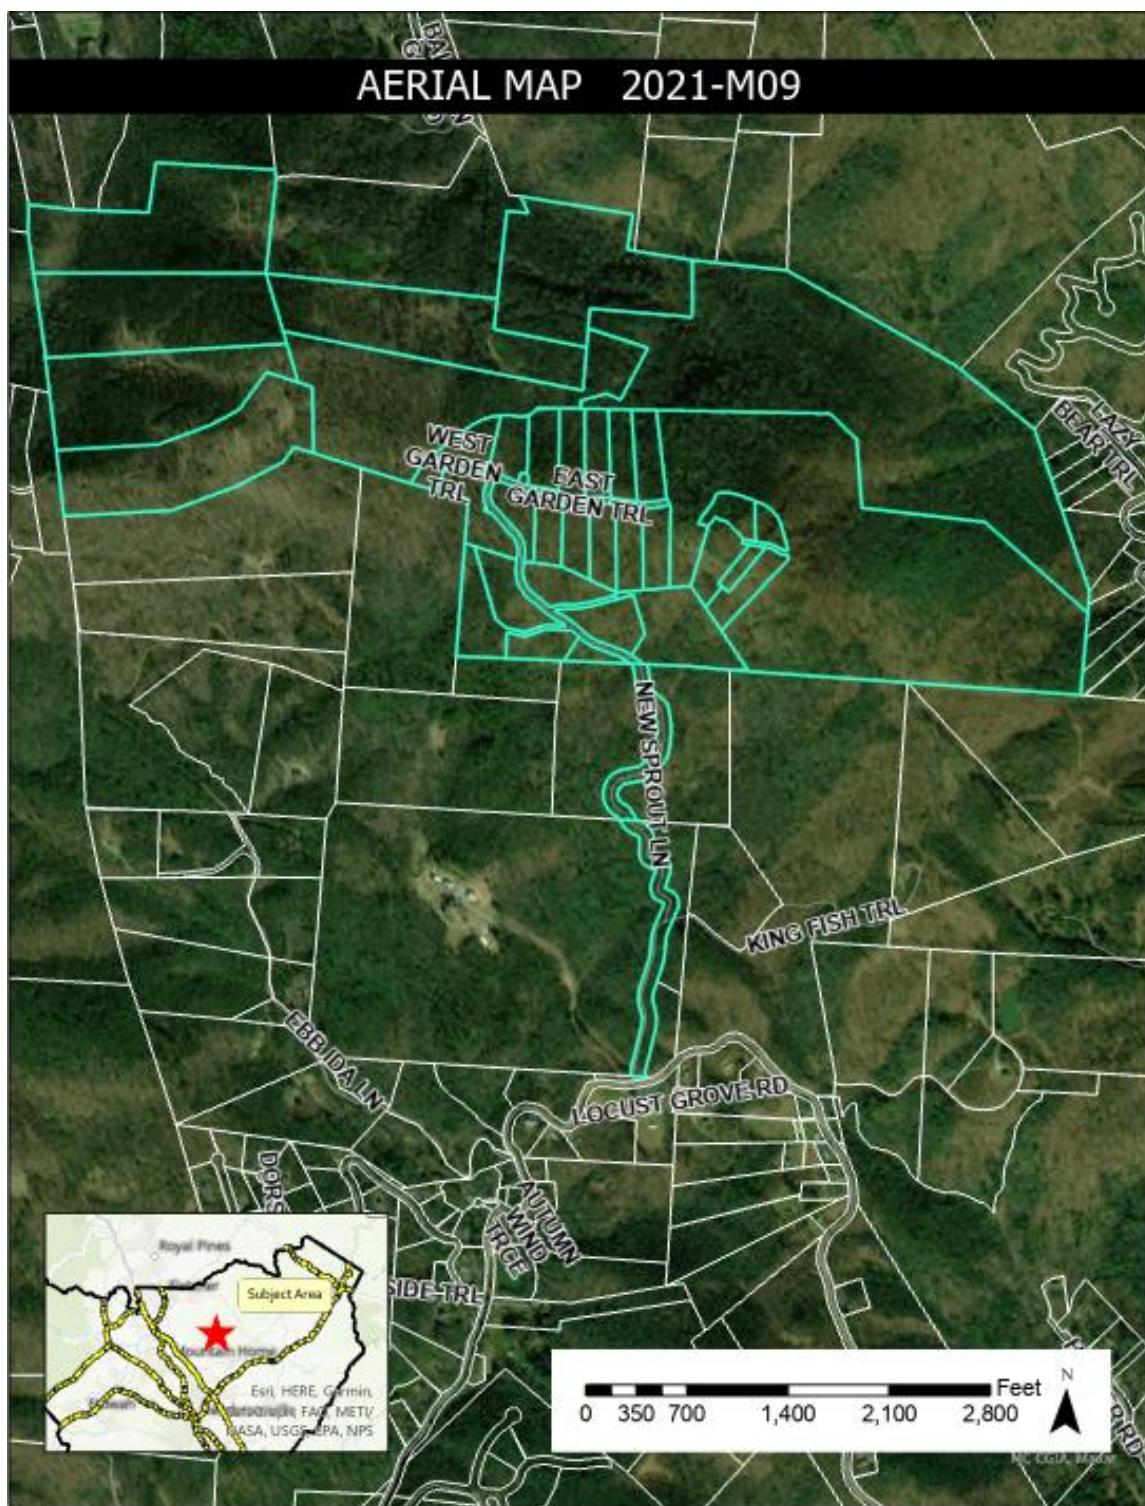


Map B: Future Land Use Map

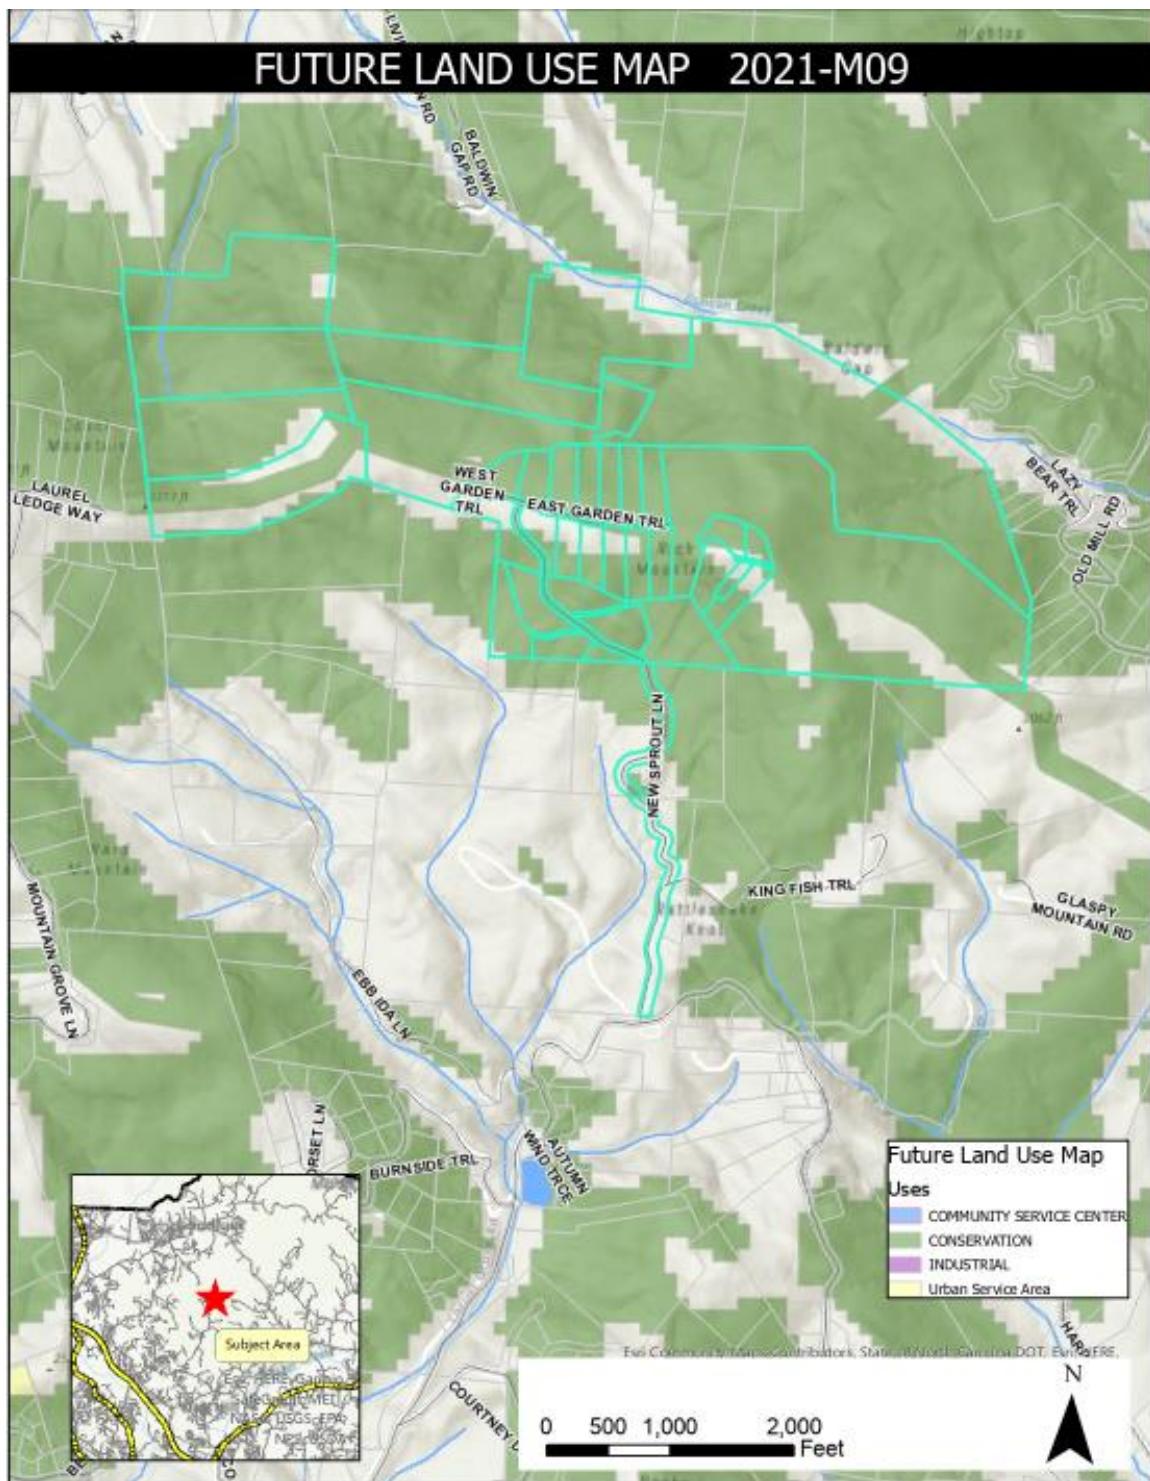


Map C: Growth Management Strategy Map

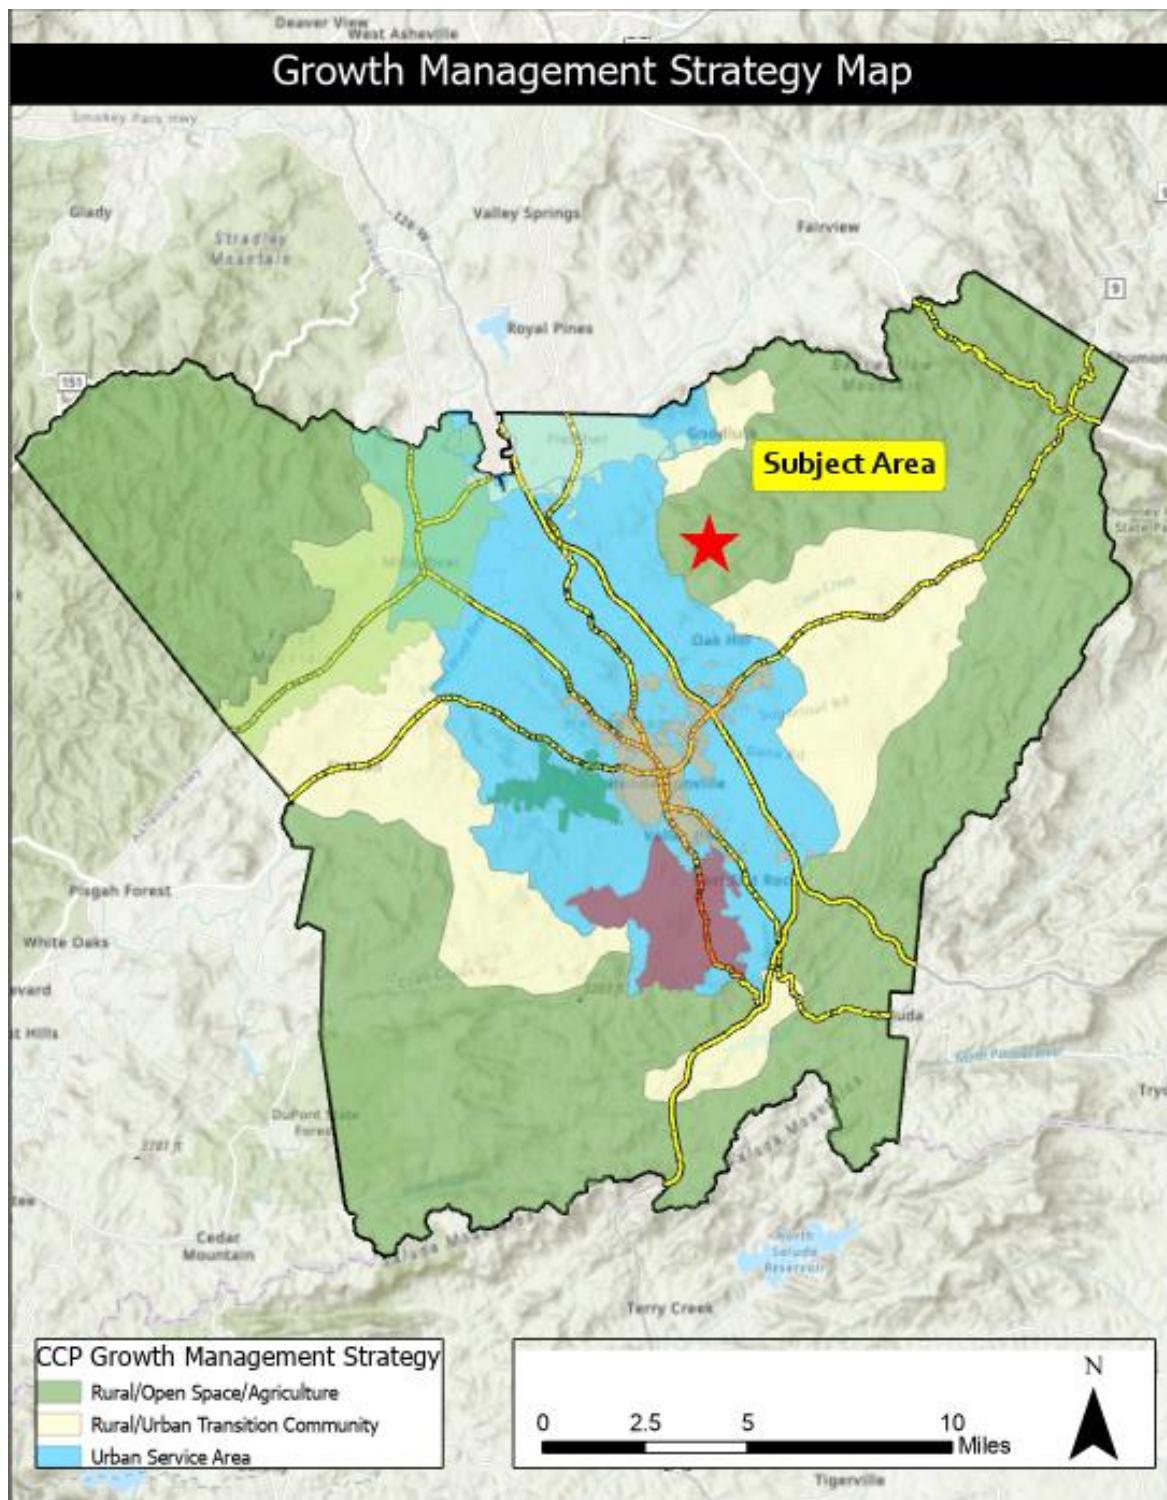

Map D: Zoning Map

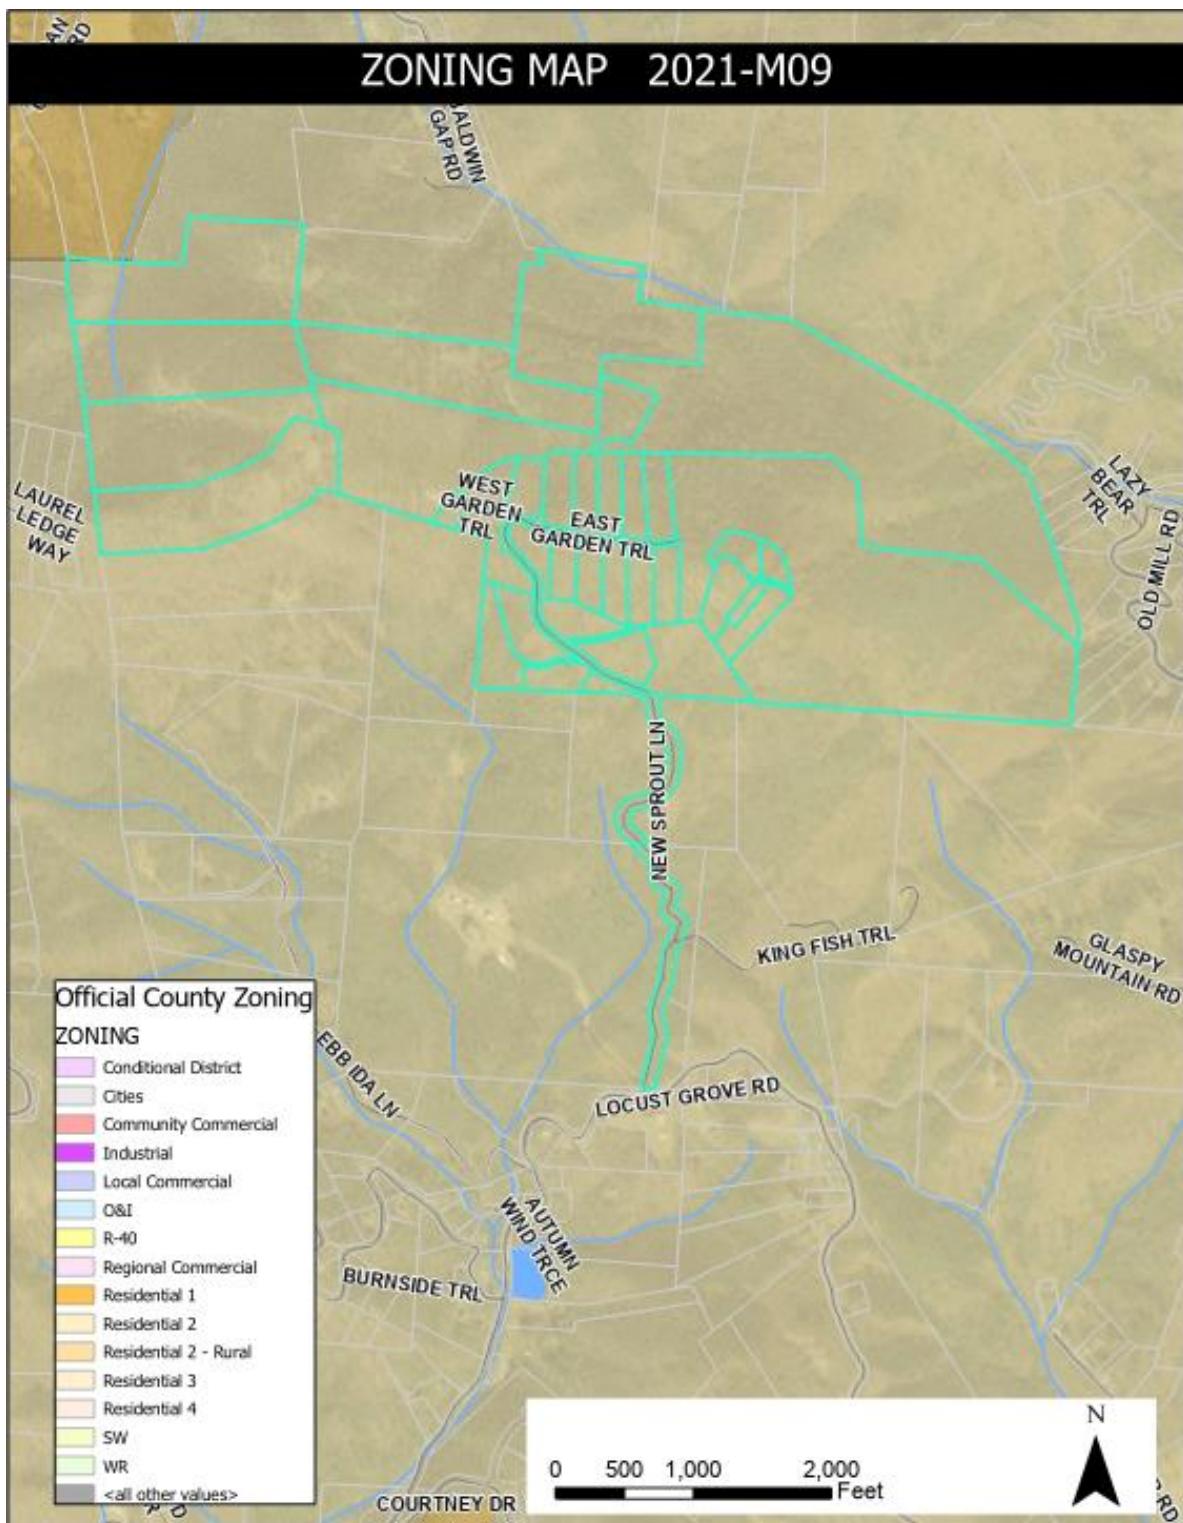

Map E: Protected Ridges Buffer

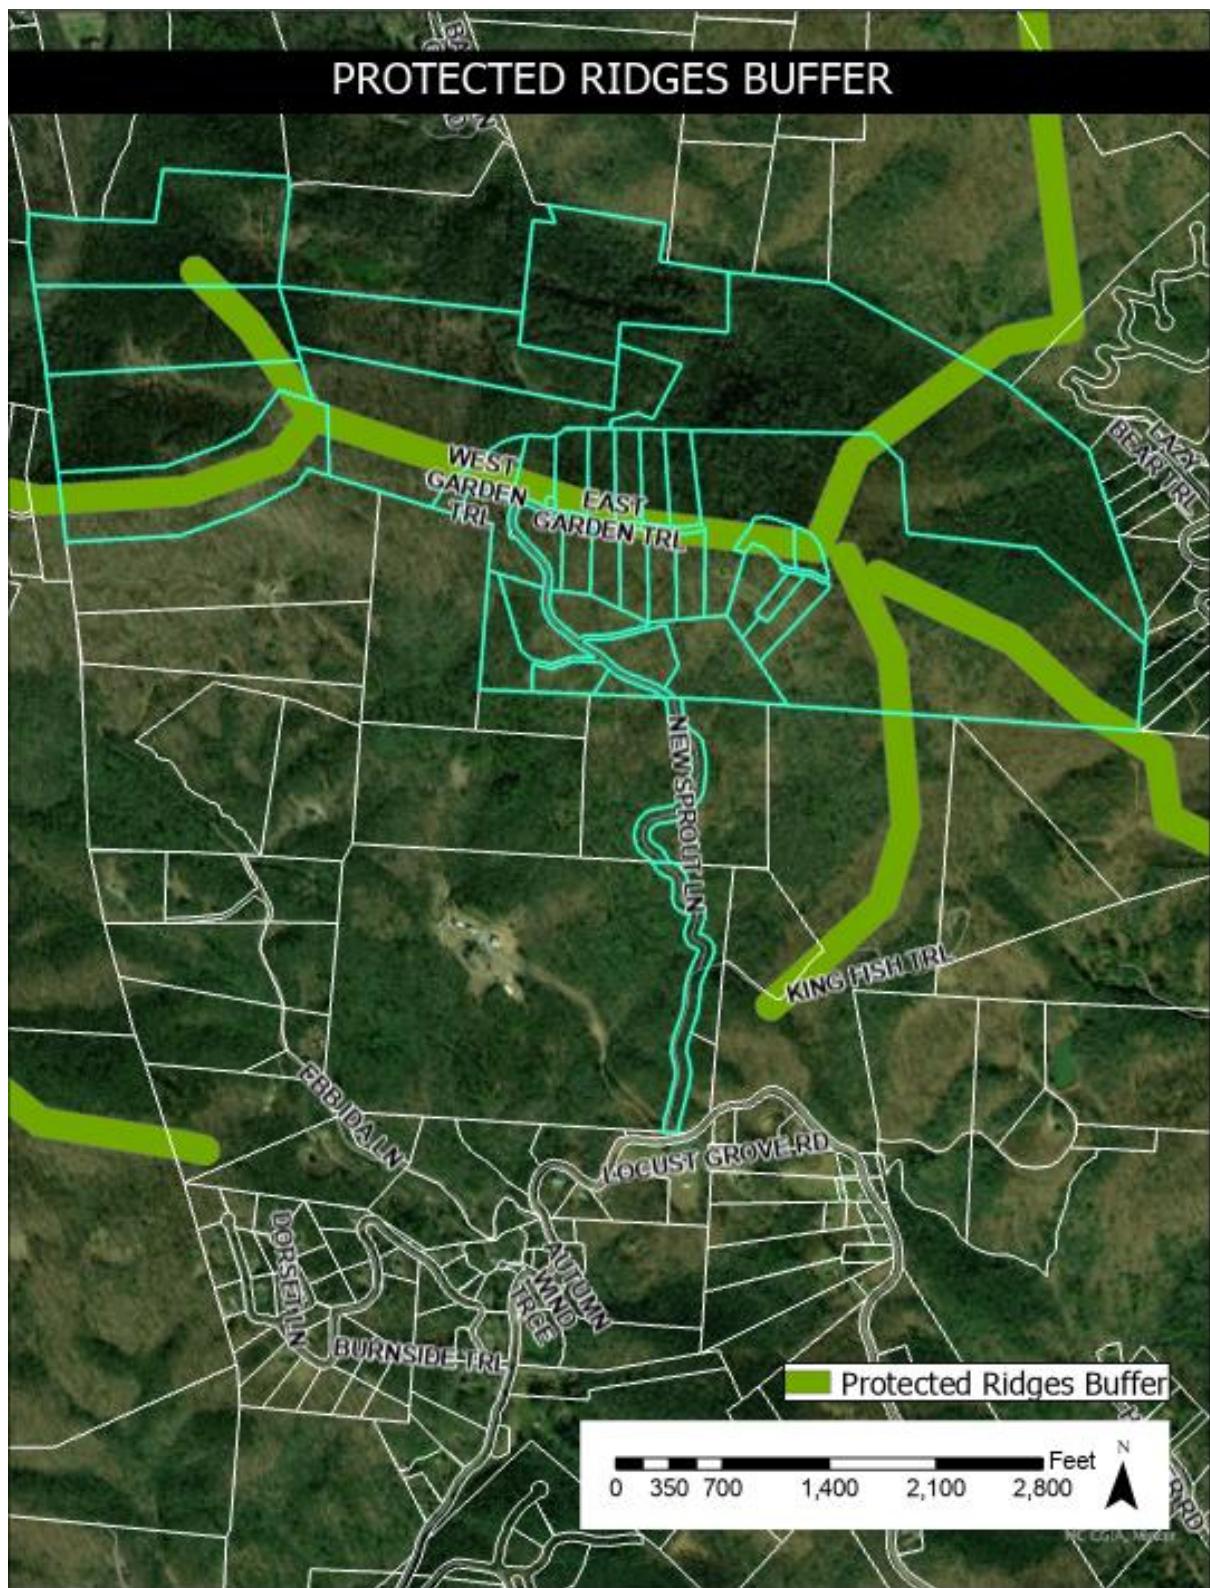

**BACKGROUND:**

The applicant, Ripple Falls LLC, is seeking approval for a Revised Master Plan and a Phase III Development Plan for the Major Subdivision titled Sprout Mountain. The project was formally known and approved under the name Rich Mountain. The applicant is represented by their engineers, John Kinnaird and Zachary Wortman of Brooks Engineering.

Planning Board first approved the Master Plan and Phase 1 Development Plan on at their regularly scheduled meeting on December 16, 2021. The applicant was approved for 60 total lots on the master plan, with development identified in 3 total phases. The total project acreage was 245.86 acres at the time. Phase 1 approved 22 lots on 82.78 acres. The Phase 2 Development Plan was approved administratively on May 26, 2022, with 31 lots on 146 acres.

Now, the applicant has submitted a revised Master and Phase 3 Development Plan, detailing an expanded project with 23 additional lots on a proposed Phase 3. Phase 3 will extend west on West Garden Trail, onto property acquired by the applicant in April of 2022.

**ANALYSIS:**

According to Chapter 42, Henderson County Land Development Code (LDC) §42-340, the purpose of a Master Plan is to provide general information about the proposed development to allow for an assessment of its impact on the orderly growth and development of the County, environmental quality, land values, natural features identified on the site analysis sketch and the County's roads and governmental services. During the review of the Master Plan, the Technical Review Committee should take into consideration: applicable recommendations of the *Henderson County Comprehensive Plan*, the potential use of the land to be subdivided, and the impact of the subdivision and proposed use whether residential, commercial, or industrial.

When reviewing the Master Plan, it is important to consider that due to severe topographic conditions, inadequate road access, distance from services, unique natural areas, soils that do not easily support soil drainage systems and/or the proximity to existing and incompatible land uses/zoning, all land may not be suitable to be subdivided for the purpose of dense development (LDC §42-74).

According to Chapter 42 of the Henderson County LDC, §42-341, the purpose of Development Plans is to provide general and specific information, displayed as a graphic representation or map, indicating all proposed divisions of land, their uses, improvements, and any other information required to fully disclose the applicant's intentions.

When reviewing the Development Plan, it is important to consider that it conforms with the Master Plan, no additional lots are created (other than indicated on the Master Plan), and all technical requirements and development standards have been met.

Staff has reviewed the submitted Combined Revised Master and Phase 3 Development Plan for the Sprout Mountain Major Subdivision, taking into consideration the recommendations of the *Henderson County Comprehensive Plan* and reviewing the plan for conformance with Henderson County Land Development Code. Staff offers the following comments:

### **Comprehensive Plan Compatibility:**

The Comprehensive Plan's Future Land Use Map indicates the subject area as being located primarily with the Rural/Agriculture Area and a small portion within the Conservation Area.

*Rural/Agriculture Area:* "The RAA covers those portions of the county that are predominantly rural and are characterized by low-density residential development with substantial land areas devoted to agriculture and undeveloped lands. Land use policies will seek to retain that character. Land development ordinances in the RAA should strive for a general, average density of 1½ or more acres per residential dwelling unit, but due to topography and land use constraints, some areas in the RAA should have densities of 1 unit per 5 or more acres. Actual densities as defined by zoning requirements should vary across the RAA according to constraints and community characteristics." (CCP, Pg 136.)

*Conservation:* Conservation Areas are "land areas that are intended to remain largely in their natural state, with only limited development." (CCP, Pg. 138)

The Comprehensive Plan's Growth Management Strategy Area also indicates the subject area as within the Rural/Agriculture Area.

### **Henderson County Land Development Code Compatibility:**

Henderson County Zoning Map indicates the subject area as Residential District Three (R3).

**Residential District Three (R3):** The purpose of Residential District Three (R3) is to foster orderly growth where the principal use of land is low density residential. The intent of this district is to allow for residential development consistent with the recommendations of the Comprehensive Plan. This general use district is typically meant to be utilized in areas designated as Rural (RAA) in the Comprehensive Plan.

R3 allows for standard residential density of 1 unit per 1.5 acres. The proposed master and development plan shows 83 single family lots on a total site area of 377.96 acres. This is below the allowed threshold of 1 unit per 1.5 acres at a density of 0.22 lots per

acre. The proposed use and density do not appear to conflict with the zoning district regulations.

### Chapter 42-95 (Major Subdivision) Requirements:

1. **Water Supply and Sewage Disposal:** The site is proposed to be served by private, individual water and septic systems.
2. **Fire Protection:** 42-95(D) requires a minimum of one (1) hydrant per 1000 feet of linear road distance (if served by a public water supply system who may impose more stringent fire protection requirements where necessary), or a dry fire hydrant system and all-weather access road for fire-fighting equipment to a permanent surface water supply.
3. **Stormwater Drainage:** Drainage systems (swales, ditches, pipes, culverts, detention ponds, lakes, or similar devices) shall be designed to minimize adverse effect on the proposed subdivision and on adjacent and downstream properties. Drainage improvements shall be designed and constructed in accordance with applicable State Road Standards and to follow natural drainage where possible, contain points of stormwater discharge onsite (unless offsite discharge is approved by the reviewing agency and adjoining property owners), maintain desirable groundwater conditions, minimize erosion, downstream sedimentation, flooding or standing water conditions, filter pollutants before stormwater reaches surface water, and avoid excessive stormwater discharge.
4. **Farmland Preservation Districts:** As indicated on the plans, Lots 1-51 and 83 are within a Farmland Preservation District, and Lots 52-82 are within a ½ mile or adjacent to the district. There is a 100' setback from structures adjacent to a Farmland Preservation District that must be observed by any lots adjacent to the district.
  - a. The applicant has indicated their intention of removing the subject area from the current Voluntary Agricultural District (VAD). A portion of the property is located within the Lower Hoopers Creek VAD. The applicant will need to work with the Soil & Water Conservation District to be removed from the VAD.
5. **Reasonable Pedestrian Access:** Reasonable pedestrian access must be provided to promote healthy and safe walking environments. As the proposed major subdivision does not contain 100 or more lots or propose a density of greater than 2 units per acre, sidewalks within the subdivision are not required.
6. **Street Tree Requirements:** Article V, Subpart C of the LDC requires Street Trees for Major Subdivisions, at a rate of either 1 large deciduous tree per 40 linear feet of property abutting an internal road, or 1 small deciduous tree per 40 linear feet of property abutting an internal road if overhead utilities are present.

- a. These trees must be within the right-of-way or within 20' of the right-of-way. The applicant may use existing trees in accordance with 42-184 and must also meet the right-of-way standards.
- b. With 4,415 new feet of internal roadway as indicated on the Phase 3 Development Plan, 111 street trees are required, or must be shown as to be preserved ( $4,415/40 = 110.375$ ). The applicant may use existing trees in accordance with LDC §42-184 instead of planting new trees. These existing trees must also be located within the right-of-way or 20 feet off the edge of the right-of-way as required by LDC §42-185.

**Miscellaneous Requirements:**

1. **Protected Mountain Ridges:** The project site is encumbered by the protected mountain ridges buffer. Section §42-251 of the LDC regulates the construction and permitting of "tall buildings" within the protected ridge buffer.

"Tall buildings or structures" include any building, structure or unit within a multiunit building with a vertical height of more than 40 feet measured from the top of the foundation of said building, structure or unit and the uppermost point of said building, structure or unit; provided, however, that where such foundation measured from the natural finished grade of the crest or the natural finished grade of the high side of the slope of a ridge exceeds 3 feet, then such measurement in excess of 3 feet shall be included in the 40-foot limitation described herein; provided, further, that no such building, structure or unit shall protrude at its uppermost point above the crest of the ridge by more than 35 feet.

2. **Open Space Requirements:** As a subdivision of greater than 35 lots, the application must meet the requirements of 42-88 as a Conservation Subdivision. The Master Plan indicates 158.73 acres (42%) as open space, exceeding the 25% requirement.
3. **Road System:** The applicant is proposing a total of 4.415 feet of new private roadway, with West Garden Trail extending westward. There are three (3) private driveway easements proposed off West Garden Trail, as shown on the roadway plans. All roads are indicated as to be paved, apart from gravel logging road. The driveway easement extending northward to access lots 81,82, and 83 will need a new road name that must be approved by the Henderson County Property Addresser prior to plat approval. The road name regulatory signs must be installed and inspected prior to plat approval. Private roads shall be constructed in accordance with the Private Subdivision Local Road Standards in Chapter 42 (LDC §42-109).
  - a. Subdivisions of 35 or more lots shall provide a minimum of two entrance roads. The second entrance road may be specifically waived by the approving authority where unique circumstances exist (LDC §42-95(I)).

4. **Dead Ends, Culs-de-sac, Turnarounds:** The Applicant proposes one new T-turnaround on West Garden Trail. All turnarounds must meet the requirements of the LDC §42-110(D).
5. **Perennial and Intermittent Surface Water Buffers:** The project site is encumbered by several perennial streams. Section §42-250 of the LDC regulates construction and permitting within the surface water buffer, requiring all built-upon area 30 feet landward of all perennial and intermittent surface waters.
6. **Soil Erosion and Sedimentation Control Plan:** The Applicant must submit a revised Soil Erosion and Sedimentation Control Plan to Henderson County and receive approval or waived by Henderson County Site Development (LDC §42-255).
7. **Stormwater/Water Quality:** The Applicant must apply for a revised Stormwater Management Permit to Henderson County, which must be issued or waived by Henderson County Site Development (LDC §42-239).
8. **Drainage, Culverts, Shoulder Stabilization:** Road or drainage structures shall be constructed in accordance with state roads standards. Road drainage side ditches shall be constructed with sufficient depth and width to carry the expected volume of storm water runoff (LDC §42-105). All areas disturbed by the construction of a public road, including cut and fill slopes, shoulders, and ditch banks, shall be seeded to stabilize the soil and prevent erosion. Seeding should be done as soon as feasible after road construction (LDC §42-102).
9. **Miscellaneous Advisory Provisions:** The Applicant should become familiar with the Miscellaneous Advisory Provisions of Chapter 42 (LDC §42-87).
10. **Final Plat Requirements:** The Final Plat(s) must meet the requirements provided by the Planning Department whenever a subdivision of land occurs (LDC §42-342).
  - a. The proposed roadways and road name and regulatory signs will be inspected prior to Final Plat approval.
11. **NCDOT Driveway Permit.** A NCDOT Driveway permit was issued for New Sprout Lane's access to Locust Grove Road (SR for each driveway access onto Howard Gap Road (SR 1528). No further NCDOT driveway permits are required.


Other County Departments or agencies may have additional comments or requirements that may be discussed at the scheduled Technical Review Committee meeting.

Any comments made by the Technical Review Committee will be passed along to the Planning Board at the regularly scheduled January 19<sup>th</sup> meeting.

#### **STAFF CONCLUSION**

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Per Chapter 42 of the Henderson County Land Development Code LDC §42-338, the Planning Board is the final approval authority for this proposed Major Subdivision. Should the Technical Review Committee find no deficiencies with the current application, they may recommend forwarding the application to the Planning Board. The Planning Board may approve, approve with conditions, or deny the proposed Master and Development plan if it exhibits deficiencies or is not in compliance with any statute, ordinance, or regulation of the Henderson County Code of Ordinances.

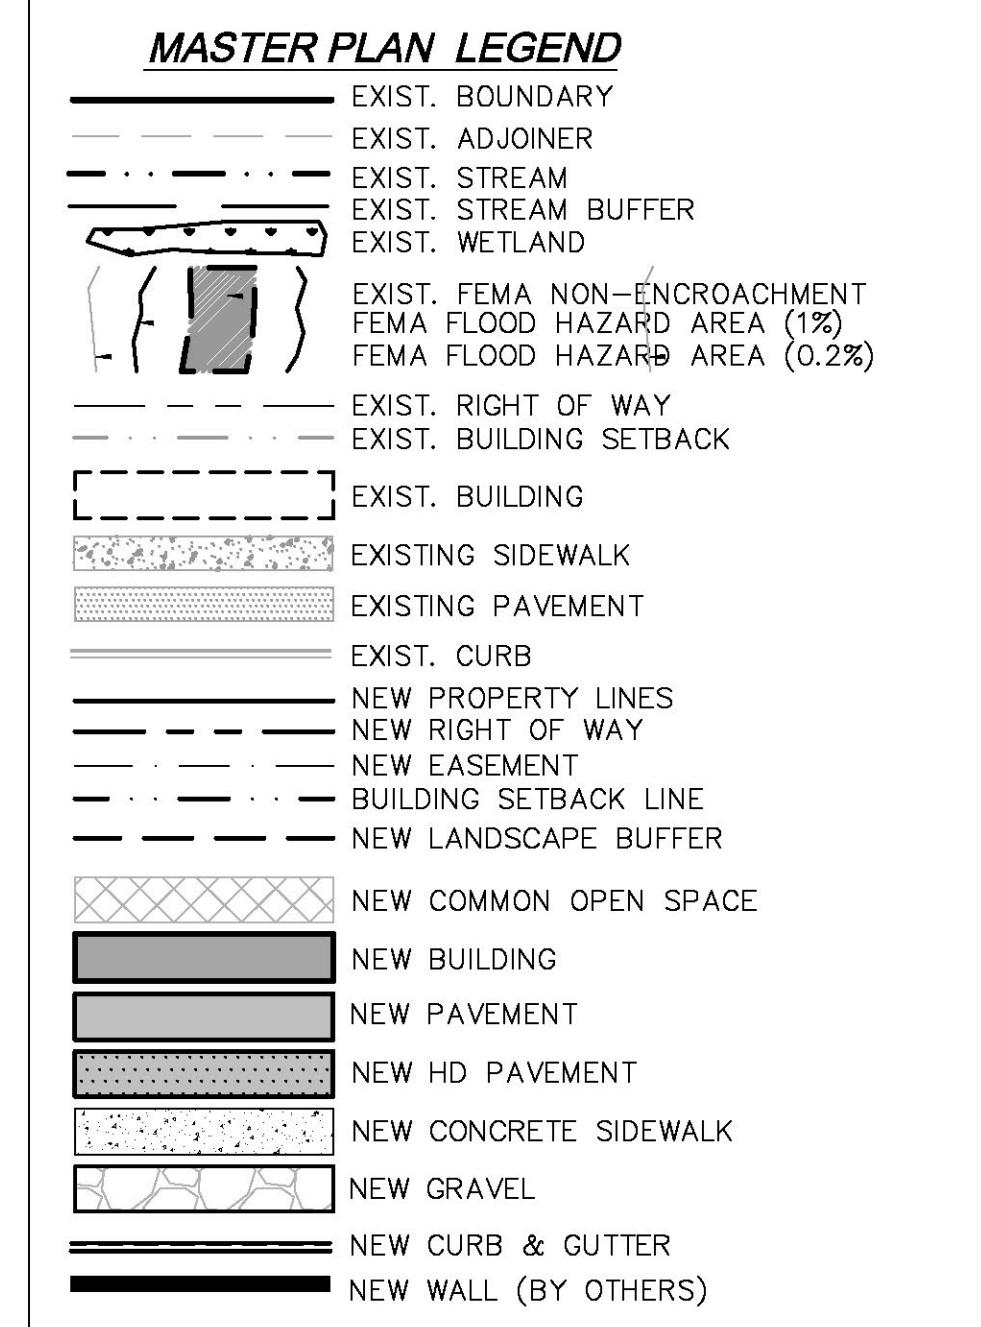

#### SITE AND ZONING NOTES

PROPERTY ZONING: R3  
PROPERTY SIZE: PH1: 88.89 - TOTAL: 256.28 AC.  
PROPERTY STEEPER THAN 60%: 16.76 AC (6.82%)

MINIMUM LOT SIZE: .150 AC / 35,640 SQ FT  
SMALLEST PROPOSED LOT: .166 ACRES / 80,936 SQ FT.  
MINIMUM LOT WIDTH: 30' @ R.O.W.

MAXIMUM BUILDING HEIGHT: 40'

#### SETBACKS:

FRONT: 15' (LOCAL)

REAR: 15'

SIDE: 15'

#### PROPOSED LINEAR FEET OF ROAD:

PHASE 1: 7,139 LF

TOTAL ON PROPERTY: 11,717 LF

\*ALL DIMENSIONS ARE FROM EDGE OF ASPHALT, FACE OF CURB, FACE OF WALL, OR FACE OF BUILDING UNLESS OTHERWISE NOTED.

\*ALL CONSTRUCTION SHALL BE IN ACCORDANCE WITH THE LATEST EDITION OF DETAILS, SPECIFICATIONS, AND OTHER DEVELOPMENT ORDINANCES OF HENDERSON CO.

#### DEVELOPMENT DATA

PROPERTY ADDRESS: LOCUST GROVE ROAD  
HENDERSONVILLE NC  
PIN NUMBER: 9672712573, 9672423071, 9672410864

PROPERTY SIZE: PH1: 88.89 AC - TOTAL: 256.28 AC  
ZONING REVIEW: HENDERSON COUNTY  
EROSION CONTROL REVIEW: HENDERSON COUNTY  
STORMWATER REVIEW: HENDERSON COUNTY

ZONING CLASSIFICATION: R3  
PROPOSED NUMBER OF UNITS: PH1: 22 - TOTAL: 60

PROPOSED DENSITY: PH1: 0.247 LOTS/AC - TOTAL: 0.234 LOTS / AC

PROPOSED LINEAR FEET OF ROAD: PHASE 1: 7,139 LF  
TOTAL ON PROPERTY: 11,717 LF

LOTS 1-51 ARE LOCATED IN A FARMLAND PRESERVATION DISTRICT. LOTS 52-60 ARE WITHIN 1/2 MILE OF THE FARMLAND PRESERVATION DISTRICT.

WATER AND SEWER WILL BE PROVIDED BY INDIVIDUAL WELLS AND SEPTIC SYSTEMS



PUBLIC WATER AND SEWER ARE APPROXIMATELY 3.0 MILES FROM THE SITE  
DRY HYDRANT IS LOCATED APPROXIMATELY 0.90 ROAD MILES FROM THE ENTRANCE TO THE SITE



PROPERTY OWNER: MULTIPLE OWNERS:  
SEE SHEET C-0  
FOR CONTACT INFORMATION

DEVELOPER: RIPPLE FALLS, LLC  
CONTACT: ANDY BAKER  
ADDRESS: 69 CLARK GAP ROAD

FLETCHER NC  
EMAIL: ANDY@TFMCAROLINA.COM  
PHONE: (616) 402-0367

ENGINEER: BROOKS ENGINEERING  
CONTACT: WYATT EDSLEE PE  
ADDRESS: 15 ARINGTON ST  
ASHEVILLE, NC 28801  
EMAIL: WEDSEL@BROOKSEA.COM  
PHONE: 828-232-4700

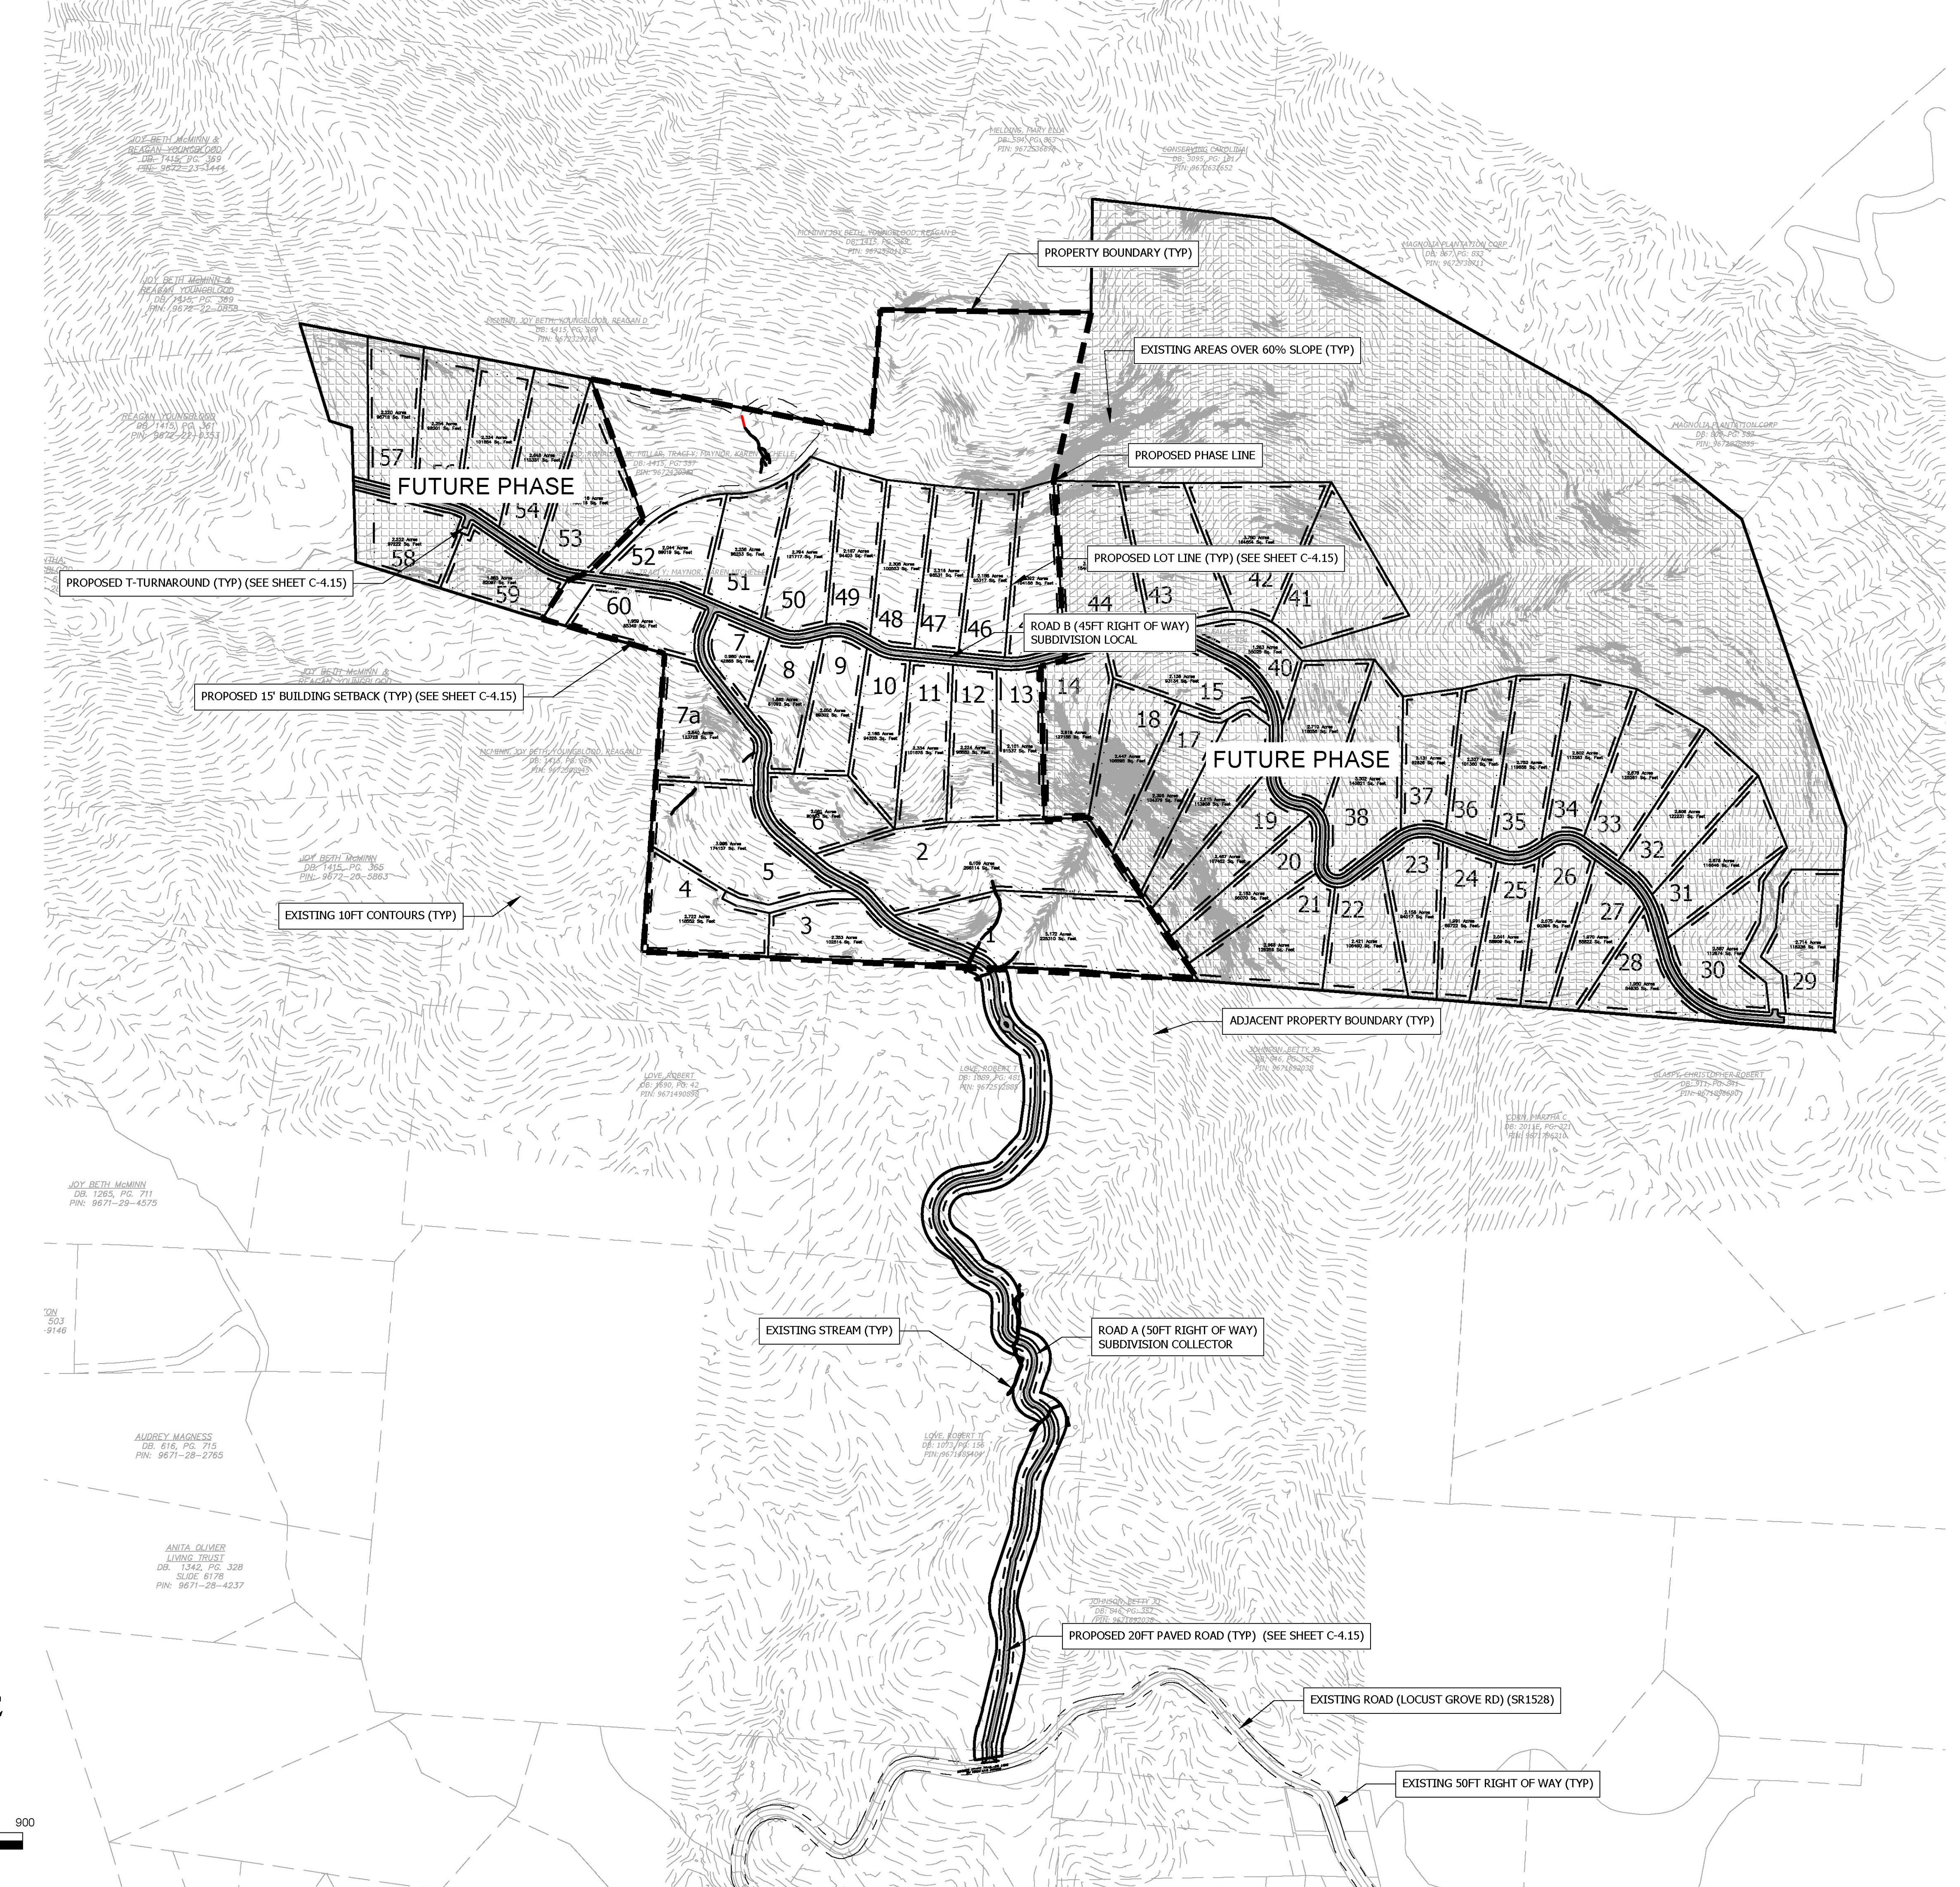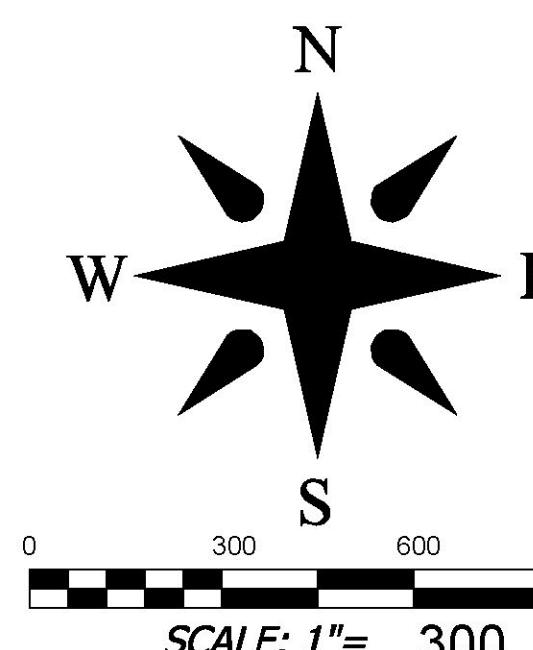

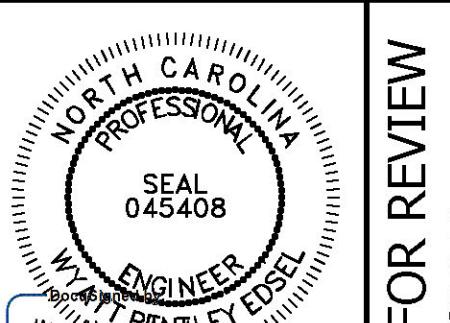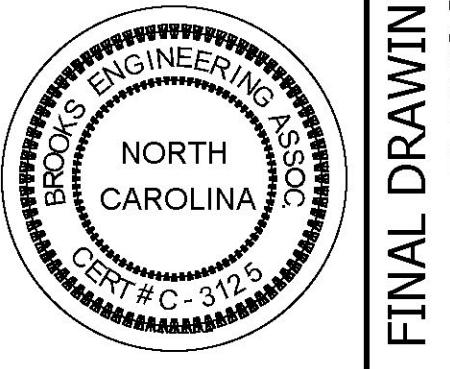Project No.	RICH MOUNTAIN SUBDIVISION PHASE 1		
C-1.0	RESIDENTIAL SUBDIVISION		
HENDERSON COUNTY	NORTH CAROLINA		
MASTER PLAN			
Drawing Title:	MASTER PLAN		
Date:	11-02-2021		
No.	1	HENDERSON COUNTY TRC	11-09-2021
REVISIONS/SUBMISSIONS			
Revision/Submission number with a triangle indicates changes made on this sheet			
 <b>WYATT BENTLEY EDSLEE</b> CB1841X0054543			
 <b>BROOKS</b> ENGINEERING ASSOCIATES Planning • Engineering • Surveying • Environmental Services •			
<b>FINAL DRAWING - FOR REVIEW PURPOSES ONLY</b>			
Designed:	WBE	Reviewed:	WBE
Drawn:	WBE	Scale:	AS NOTED
Checked:	WBE	Date:	2021-12-09
15 Arlington Street Asheville, NC 28801 Phone: 1-828-232-4700 Fax: 1-828-232-1331 www.brooksea.com			

**HENDERSON COUNTY**  
**SUBDIVISION APPLICATION FORM**  
(Please fill out all applicable items)

**SUBDIVISION INFORMATION**

Subdivision Name: Rich Mountain Subdivision

Subdivision Type (Circle One): Major  Minor  Non-Standard  Special Proposed Use of Property (Circle One): Residential  Commercial  Industrial Conservation Subdivision: Yes  No  Gated entrance to property: Yes  No 

Existing Number of Lots: 14 Total Number of Proposed Lots: 83

Total Number Proposed Units: 83 Proposed Density (units per acre): 0.22

Road System: ( ) Public  Private  Combination Public and Private Water System: (X) Individual  Community  Municipal Sewer System: (X) Individual  Community  Municipal **PARCEL INFORMATION**

PIN: SEE PLANS Total Acreage: 377.96 Deed Book/Page: SEE PLANS Township: \_\_\_\_\_

Location of property to be divided: The subject parcel is located North of Locust Grove Rd

Zoning District: R3 Fire District: HOPPERS CREEK

Water Supply Watershed: N/A School District: NORTH HIGH

Any portion of property within or containing the following:

Floodplain or floodway: Yes  No Perennial streams: Yes  NoProtected mountain ridges: Yes  No Cemetery: Yes  NoWithin ½ mile of a Farmland Preservation District: Yes  NoAdjacent to a Farmland Preservation District: Yes  No**CONTACT INFORMATION****Property Owner:**

Name: Ripple Falls LLC

Address: 69 Clark Gap Road

Phone: 616-402-0367

City, State, Zip: Fletcher, NC 28732

**Applicant:**

Name: Ripple Falls LLC

Address: 69 Clark Gap Road

Phone: 616-402-0367

City, State, Zip: Fletcher, NC 28732

**Agent:** Agent Form (Circle One): Yes  No 

Name: \_\_\_\_\_

Address: \_\_\_\_\_

Phone: \_\_\_\_\_

City, State, Zip: \_\_\_\_\_

**Plan Preparer:**

Name: John Kinnaird

Address: 15 Arlington Street


Phone: 828-232-4700

City, State, Zip: Asheville, NC 28801

I certify that the information shown above is true and accurate and is in conformance with the Subdivision regulations of Henderson County.

Andy Baker

Print Applicant (Owner or Agent) \_\_\_\_\_

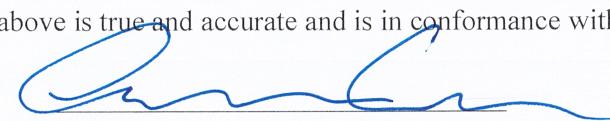

Signature Applicant (Owner or Agent)

12/13/2022

Date

**County Use Only**

Fee: \$ \_\_\_\_\_ Paid: \_\_\_\_\_ Method: \_\_\_\_\_ Final Plat Approved On: \_\_\_\_\_

# RICH MOUNTAIN PHASE 3

MAJOR SUBDIVISION

HENDERSON COUNTY

## NOTES

### SITE NOTES:

1. PROJECT ADDRESS: LOCUST GROVE ROAD, HENDERSONVILLE NC
2. TOTAL ACREAGE: 377.96 AC.
3. ZONING: R3
4. PROJECT PIN NUMBER(S): 9672530112, 9672329718, 9672329259, 9672220858, 9672231444, 9672220353, 9672212880
5. EXISTING TOPO INFO SHOWN WAS PROVIDED BY: BROOKS ENGINEERING ASSOCIATES
6. EXISTING BOUNDARY INFO PROVIDED BY: BROOKS ENGINEERING ASSOCIATES
7. FEMA FLOOD PANEL: 3700967200J, EFF. 10/02/2008
8. RECEIVING STREAM: DUNCAN CREEK (6-57-19-2), CLASS C, TR); FLYNN BRANCH (6-57-19-3, CLASS C, TR); FEATHER STONE CREEK (6-55-12, CLASS C)
9. SOIL TYPE(S): Ahf, AhG, Ede, Edf, PoE, PoF, PoG, TuE, TuF
10. DEED BOOK / PAGE: 3897/292, 3822/592
11. LATITUDE / LONGITUDE: 35.409521/-82.438765
12. DISTURBED ACREAGE: 6.45 AC.
13. EROSION CONTROL REVIEW: HENDERSON COUNTY
14. STORMWATER MANAGEMENT REVIEW: HENDERSON COUNTY

### GENERAL NOTES:

1. CONTRACTOR SHALL PROTECT ADJACENT PROPERTIES, THE GENERAL PUBLIC AND ALL OF THE OWNER'S FACILITIES AND SHALL BE RESPONSIBLE FOR THE REPAIR OF ALL DAMAGES WHICH OCCUR DURING CONSTRUCTION.
2. LOCATION OF ALL EXISTING UTILITIES, AS SHOWN HEREON, ARE APPROXIMATE ONLY. NO GUARANTEE IS MADE OR IMPLIED BY THE LOCATION REFLECTED IN THE PLANS. IT IS THE CONTRACTOR'S RESPONSIBILITY TO VERIFY THE TYPE, SIZE AND LOCATION OF ALL UTILITIES AND OTHER FEATURES WHICH MAY AFFECT CONSTRUCTION OR THE INTENDED FUNCTION OF THE DESIGN. CONTRACTOR SHALL NOTIFY DESIGNER PRIOR TO CONSTRUCTION IF EXISTING CONDITIONS DIFFER FROM THAT INDICATED IN THE PLANS.
3. NO STREAM OR WETLAND DISTURBANCE SHALL OCCUR WITHOUT A ARMY CORPS OF ENGINEERS PERMIT.
4. THE ESCAPE OF SEDIMENT FROM THE SITE SHALL BE PREVENTED BY THE INSTALLATION OF EROSION CONTROL MEASURES AND PRACTICES PRIOR TO, OR CONCURRENT WITH, LAND DISTURBING ACTIVITIES.
5. ANY EXCESS CUT MATERIAL DEVELOPED IN THE CONSTRUCTION OF THIS SITE SHALL BE DISPOSED OF IN AN APPROPRIATELY PERMITTED SPOIL SITE. CONTRACTOR TO PROVIDE PROOF OF PERMITS PRIOR TO CONSTRUCTION.
6. ANY ALTERATION TO THE PLANS MUST BE APPROVED BY THE PROJECT ENGINEER, OR APPROPRIATE AGENCY PRIOR TO THE COMMENCEMENT OF WORK.
7. THE CONTRACTOR SHALL OBTAIN, AND PAY FOR, PRIOR TO BEGINNING ANY WORK, ALL PERMITS AND LICENSES NECESSARY TO ACCOMPLISH THE WORK.
8. CONTRACTOR(S) SHALL BE RESPONSIBLE FOR ADEQUATE SUPERVISION TO PREVENT DAMAGE AND MOVEMENT FROM EQUIPMENT WORKING AROUND CONSTRUCTION STAKES. THESE CONSTRUCTION STAKES SHALL REMAIN IN PLACE AND BE PROTECTED UNTIL OWNER APPROVES THEIR REMOVAL. ANY STAKES THAT HAVE BEEN DISPLACED AS A RESULT OF CONSTRUCTION ACTIVITY ARE TO BE REPLACED BY A LICENSED LAND SURVEYOR ENGAGED BY THE CONTRACTOR AT NO COST TO THE OWNER.
9. THE ENGINEER WILL NOT BE CONTINUOUSLY PRESENT IN THE FIELD, IT IS SPECIFICALLY UNDERSTOOD THAT HE DOES NOT UNDERTAKE NOR ASSUME ANY OBLIGATION FOR SUPERVISION OF CONSTRUCTION, SAFETY MEASURES TAKEN DURING THE COURSE OF CONSTRUCTION, RESPONSIBILITY FOR SCHEDULING THE WORK FOR INSURING COMPLETE COMPLIANCE WITH THE CONTRACT DOCUMENTS AND/OR ALL CODE REQUIREMENTS, RULES AND REGULATION OF ANY PUBLIC OR PRIVATE AUTHORITY HAVING JURISDICTION OVER THE WHOLE OR ANY PART OF THE WORK. IN ADDITION, THE ENGINEER NEITHER UNDERTAKES, ASSUMES, NOR GUARANTEES THE WORK AND/OR PERFORMANCE OF THE CONTRACTOR.


### INSPECTION SCHEDULE:

1. NO CONSTRUCTION SHALL COMMENCE PRIOR TO A PRECONSTRUCTION MEETING WITH THE OWNER, THE CONTRACTOR, THE ENGINEER, AND A REPRESENTATIVE OF THE APPROVING JURISDICTION.
2. ALL SHOP DRAWINGS SHALL BE SUBMITTED AT OR PRIOR TO THE PRECONSTRUCTION MEETING.
3. ENGINEER TO BE CALLED FOR PERIODIC INSPECTIONS.
4. CALL ENGINEERING PRIOR TO COVERING UNDERGROUND STRUCTURES FOR FINAL INSPECTIONS.
5. REFER TO MANUFACTURER'S SPECIFICATION MANUAL AND STATE AND LOCAL STANDARDS FOR ADDITIONAL REQUIREMENTS AND STANDARDS.




BEFORE YOU DIG !  
CALL 811  
N.C. ONE-CALL CENTER  
IT'S THE LAW !

## PROJECT MAP

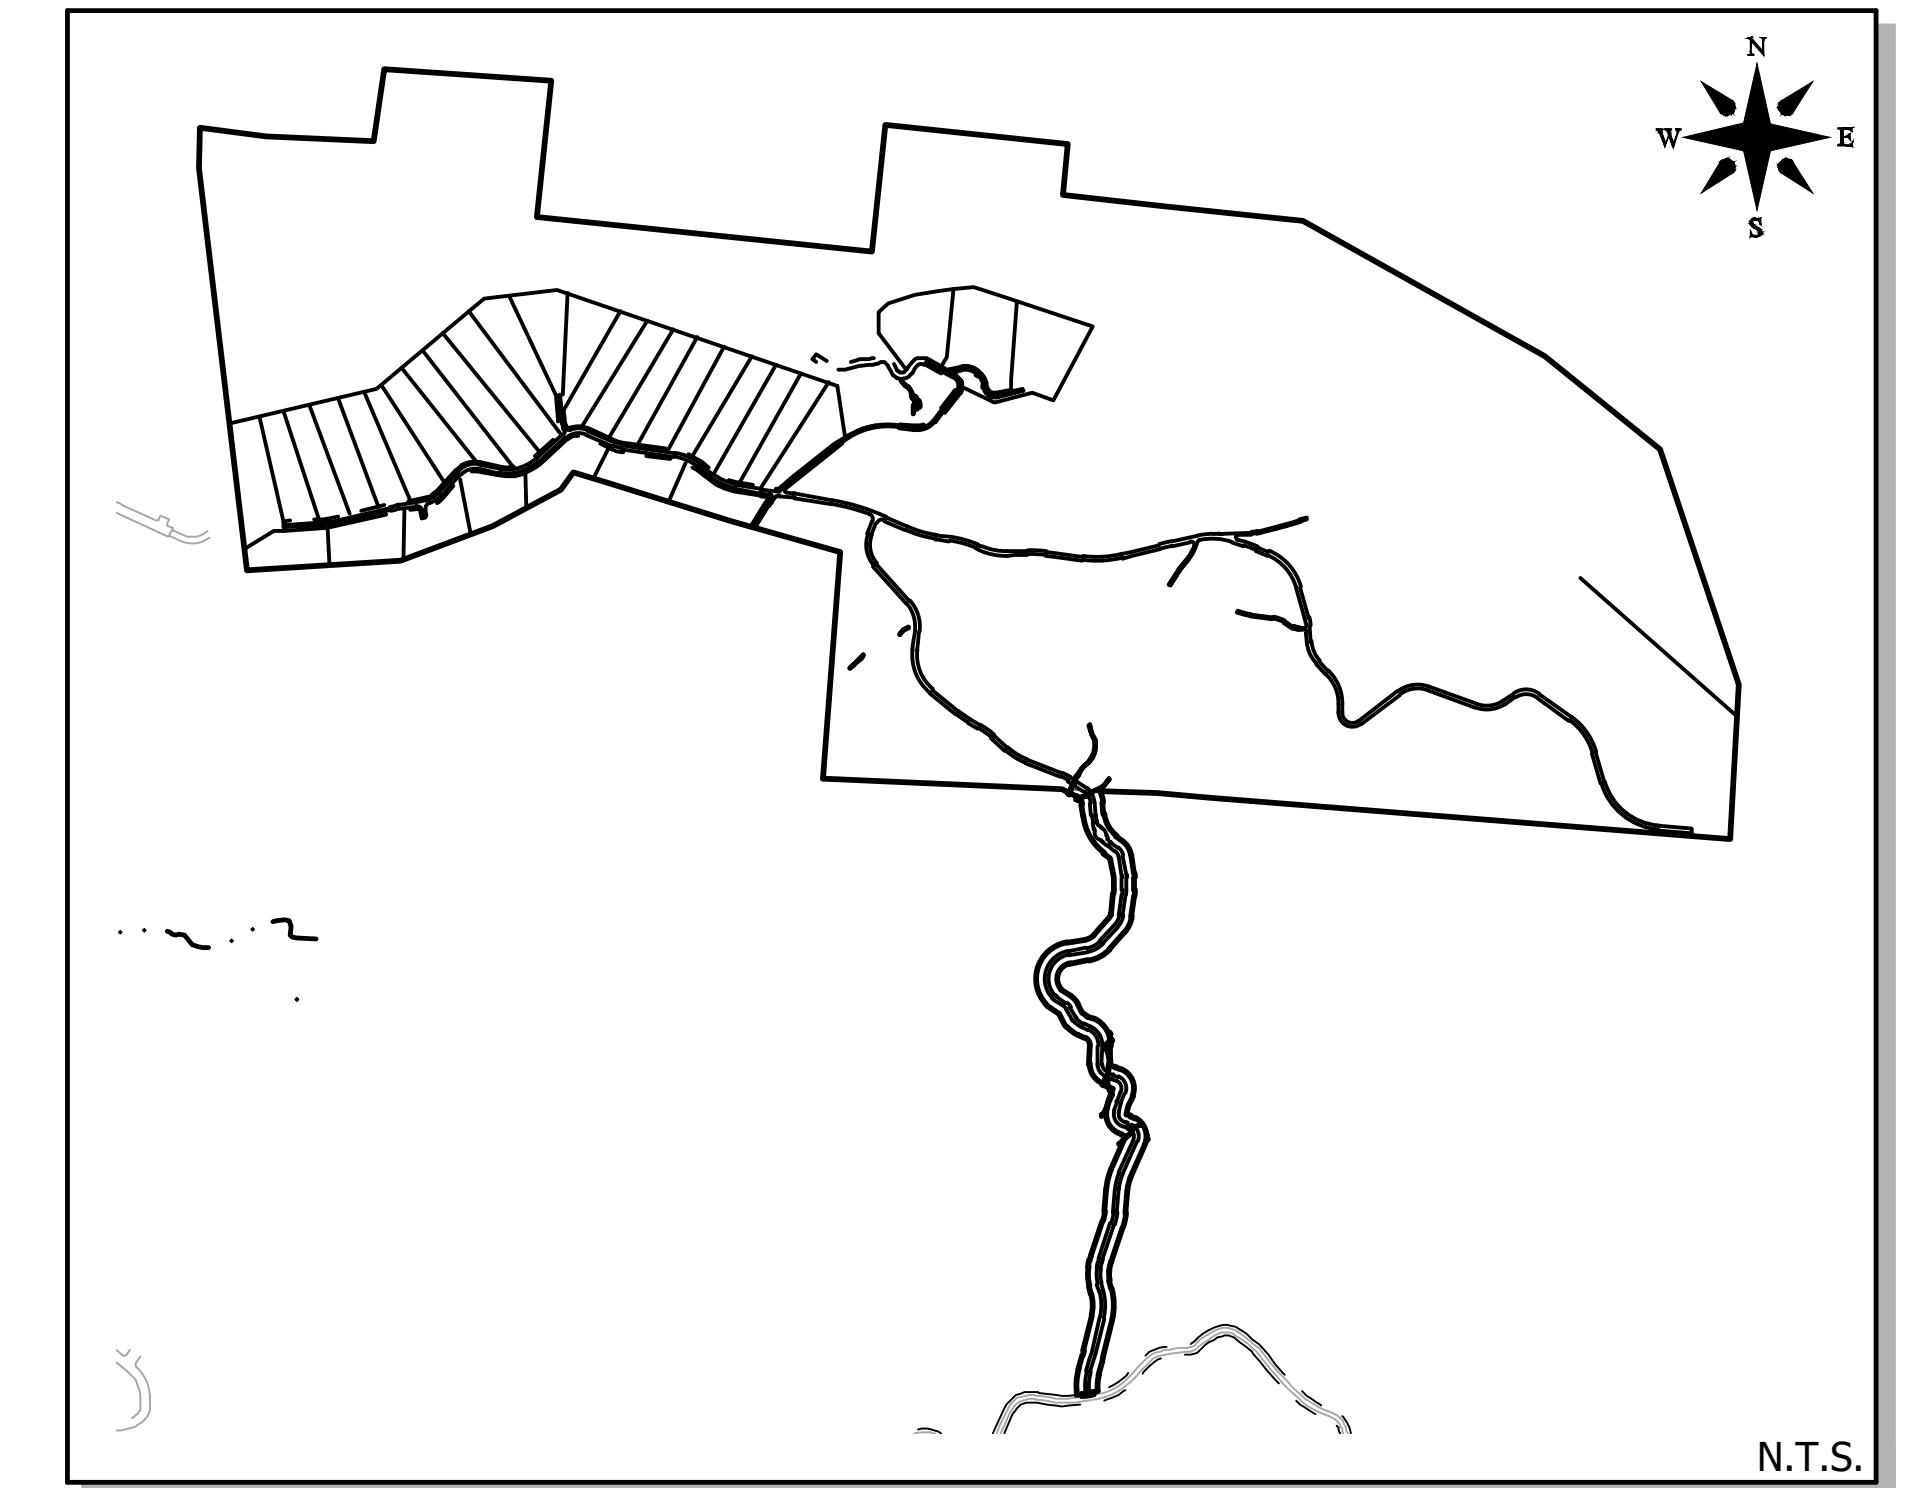

## VICINITY MAP

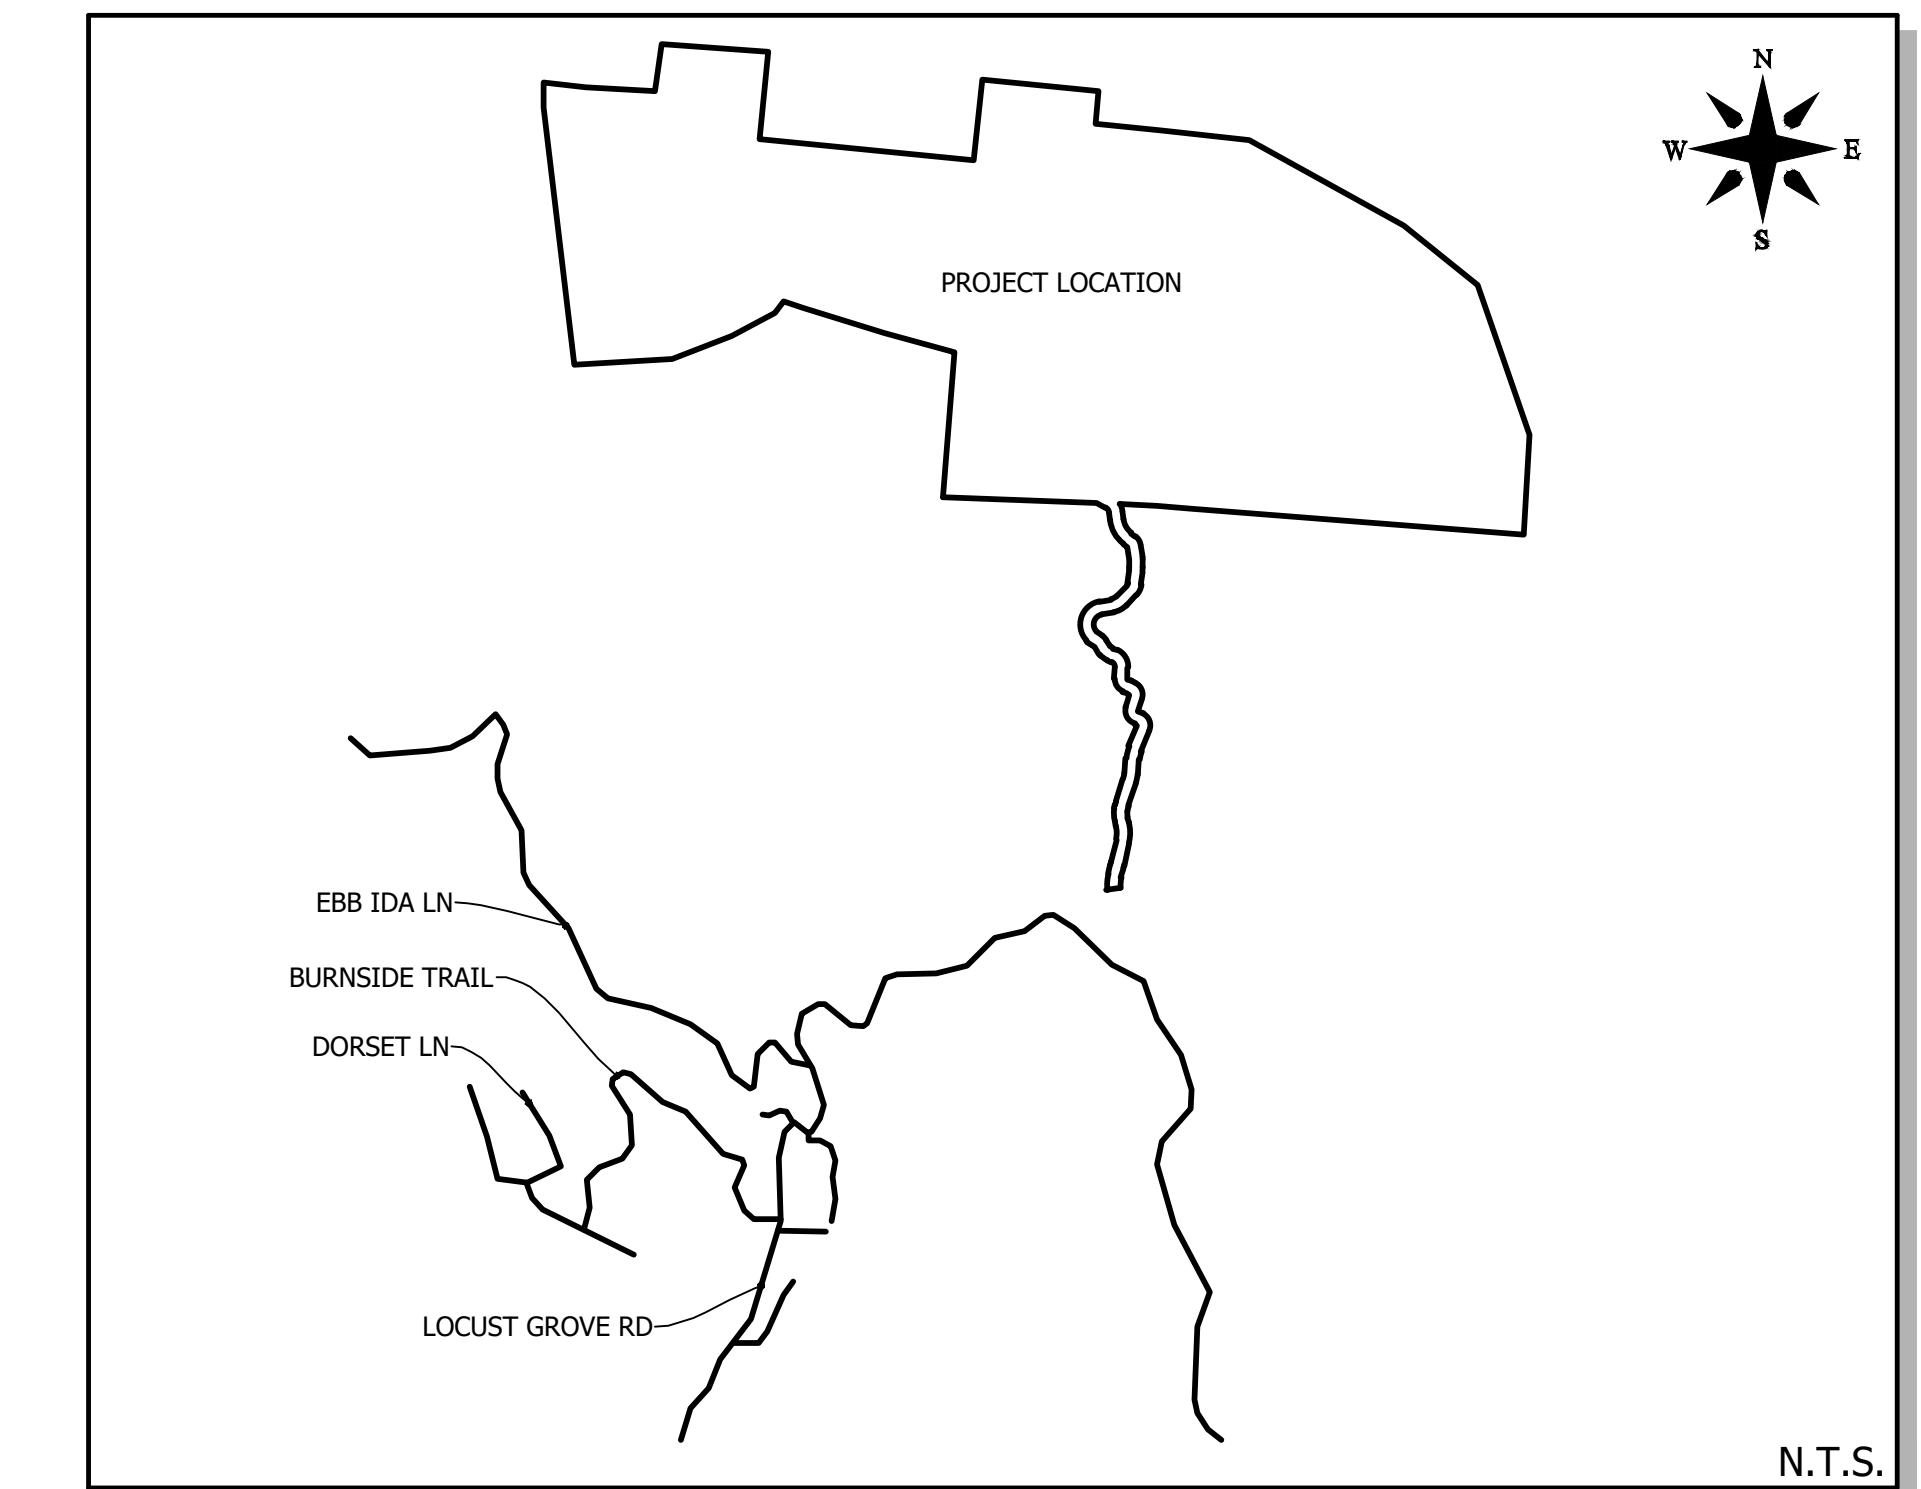

## CONTACTS

### DEVELOPER:

RIPLE FALLS LLC

### CONTACT INFO:

ANDY BAKER  
ANDY@TFMCAROLINA.COM  
(616) 402-0367  
69 CLARK GAP ROAD  
FLETCHER NC

### OWNER:

RIPLE FALLS LLC

### CONTACT INFO:

ANDY BAKER  
ANDY@TFMCAROLINA.COM  
(616) 402-0367  
69 CLARK GAP ROAD  
FLETCHER NC

### ENGINEER:

BROOKS ENGINEERING ASSOCIATES, PA

### CONTACT INFO:

JOHN KINNAIRD, PE  
JKINNAIRD@BROOKSEA.COM  
828-232-4700  
17 ARLINGTON STREET  
ASHEVILLE, NC 28801

### SURVEYOR:


BROOKS ENGINEERING ASSOCIATES

### CONTACT INFO:

TROY SHRIVER, PLS  
TSHRIVER@BROOKSEA.COM  
15 ARLINGTON STREET  
ASHEVILLE, NC 28801


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	MAJOR SUBDIVISION		
	HENDERSON COUNTY		
C-0	NORTH CAROLINA		
	COVER SHEET		
Drawing Title: COVER SHEET			
Date: 12-15-2022	REVISIONS/SUBMISSIONS	No. 1	HENDERSON COUNTY PLANNING
Revision Submission number within a triangle indicates changes made on this sheet			
File Location: L:\2021\Projects\R-3521\Ripple Falls_Rich Mtn. Due Diligence\Draw (Phase 3)\Cpl-Base-543521\Ph3.dwg			



MASTER PLAN LEGEND	
—	EXIST. BOUNDARY
— — —	EXIST. ADJOINER
— — —	EXIST. STREAM
— — —	EXIST. STREAM BUFFER
— — —	EXIST. WETLAND
■	EXIST. FEMA NON-ENCROACHMENT
■	FEMA FLOOD HAZARD AREA (1%)
■	FEMA FLOOD HAZARD AREA (0.2%)
—	EXIST. RIGHT OF WAY
—	EXIST. BUILDING SETBACK
— — —	EXIST. BUILDING
■ ■ ■	EXISTING SIDEWALK
■ ■ ■	EXISTING PAVEMENT
—	EXIST. CURB
— — —	NEW RIGHT OF WAY
— — —	NEW EASEMENT
— — —	BUILDING SETBACK LINE
— — —	NEW LANDSCAPE BUFFER
■ ■ ■	NEW COMMON OPEN SPACE
■ ■ ■	NEW BUILDING
■ ■ ■	NEW PAVEMENT

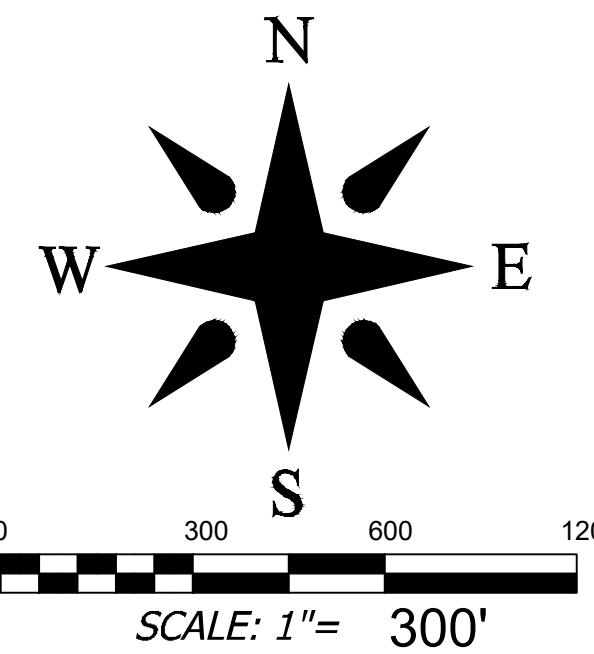

**SITE AND ZONING NOTES**  
 PROPERTY ZONING: R3  
 PROPERTY SIZE: PH3: 150.06 AC | TOTAL: 377.96 AC  
 PROPERTY STEEPER THAN 60%: 16.76 AC (6.82%)  
 MINIMUM LOT SIZE: 1.50 AC / 35,640 SQ.FT.  
 SMALLEST PROPOSED LOT: 1.52 ACRES / 66,136 SQ.FT.  
 COMMON OPEN SPACE: 158.73 AC. (42.0%)  
 MINIMUM LOT WIDTH: 30' @ R.O.W.  
 MAXIMUM BUILDING HEIGHT: 40'  
 SETBACKS:  
 FRONT: 15' (LOCAL)  
 REAR: 15'  
 SIDE: 15'  
 PROPOSED LINEAR FEET OF ROAD:  
 PHASE 1: 7,139 LF  
 PHASE 2: 3,681 LF  
 PHASE 3: 4,415 LF  
 TOTAL ON PROPERTY: 15,235 LF  
 \*ALL DIMENSIONS ARE FROM EDGE OF  
 ASPHALT, FACE OF CURB, FACE OF WALL,  
 OR FACE OF BUILDING UNLESS OTHERWISE  
 NOTED.  
 \*ALL CONSTRUCTION SHALL BE IN  
 ACCORDANCE WITH THE LATEST EDITION OF  
 DETAILS, SPECIFICATIONS, AND OTHER  
 DEVELOPMENT ORDINANCES OF HENDERSON CO.


**DEVELOPMENT DATA**  
 PROPERTY ADDRESS: LOCUST GROVE ROAD  
 HENDERSONVILLE NC  
 PIN NUMBER: SEE COVER SHEET  
 PROPERTY SIZE: PH3: 150.06 AC - TOTAL: 377.96 AC.  
 ZONING REVIEW: HENDERSON COUNTY  
 EROSION CONTROL REVIEW: HENDERSON COUNTY  
 STORMWATER REVIEW: HENDERSON COUNTY  
 ZONING CLASSIFICATION: R3  
 PROPOSED NUMBER OF UNITS: PH3: 32 - TOTAL: 83  
 PROPOSED DENSITY: PH3: 0.21 LOTS/AC - TOTAL: 0.22 LOTS/AC  
 LOTS 1-51 AND 83 ARE LOCATED WITHIN A FARMLAND PRESERVATION DISTRICT. LOTS 52-82 ARE WITHIN 1/2 MILE OF A FARMLAND DISTRICT.  
 WATER AND SEWER WILL BE PROVIDED BY INDIVIDUAL WELLS AND SEPTIC SYSTEMS.  
 PUBLIC WATER AND SEWER ARE APPROXIMATELY 3.0 MILES FROM THE SITE.  
 DRY HYDRANT IS LOCATED APPROXIMATELY 0.90 ROAD MILES FROM THE ENTRANCE TO THE SITE.  
 PROPERTY OWNER: RIPPLE FALLS LLC  
 CONTACT: ANDY BAKER  
 ADDRESS: 69 CLARK GAP ROAD  
 FLETCHER NC  
 EMAIL: ANDY@FMCAROLINA.COM  
 PHONE: (616) 402-0367  
 DEVELOPER: RIPPLE FALLS LLC  
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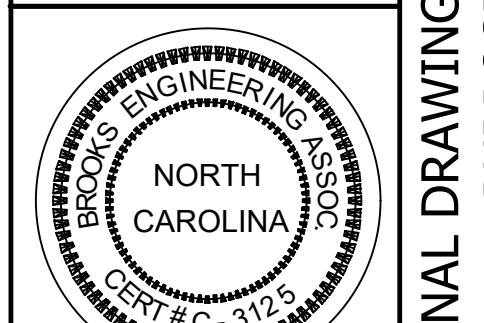


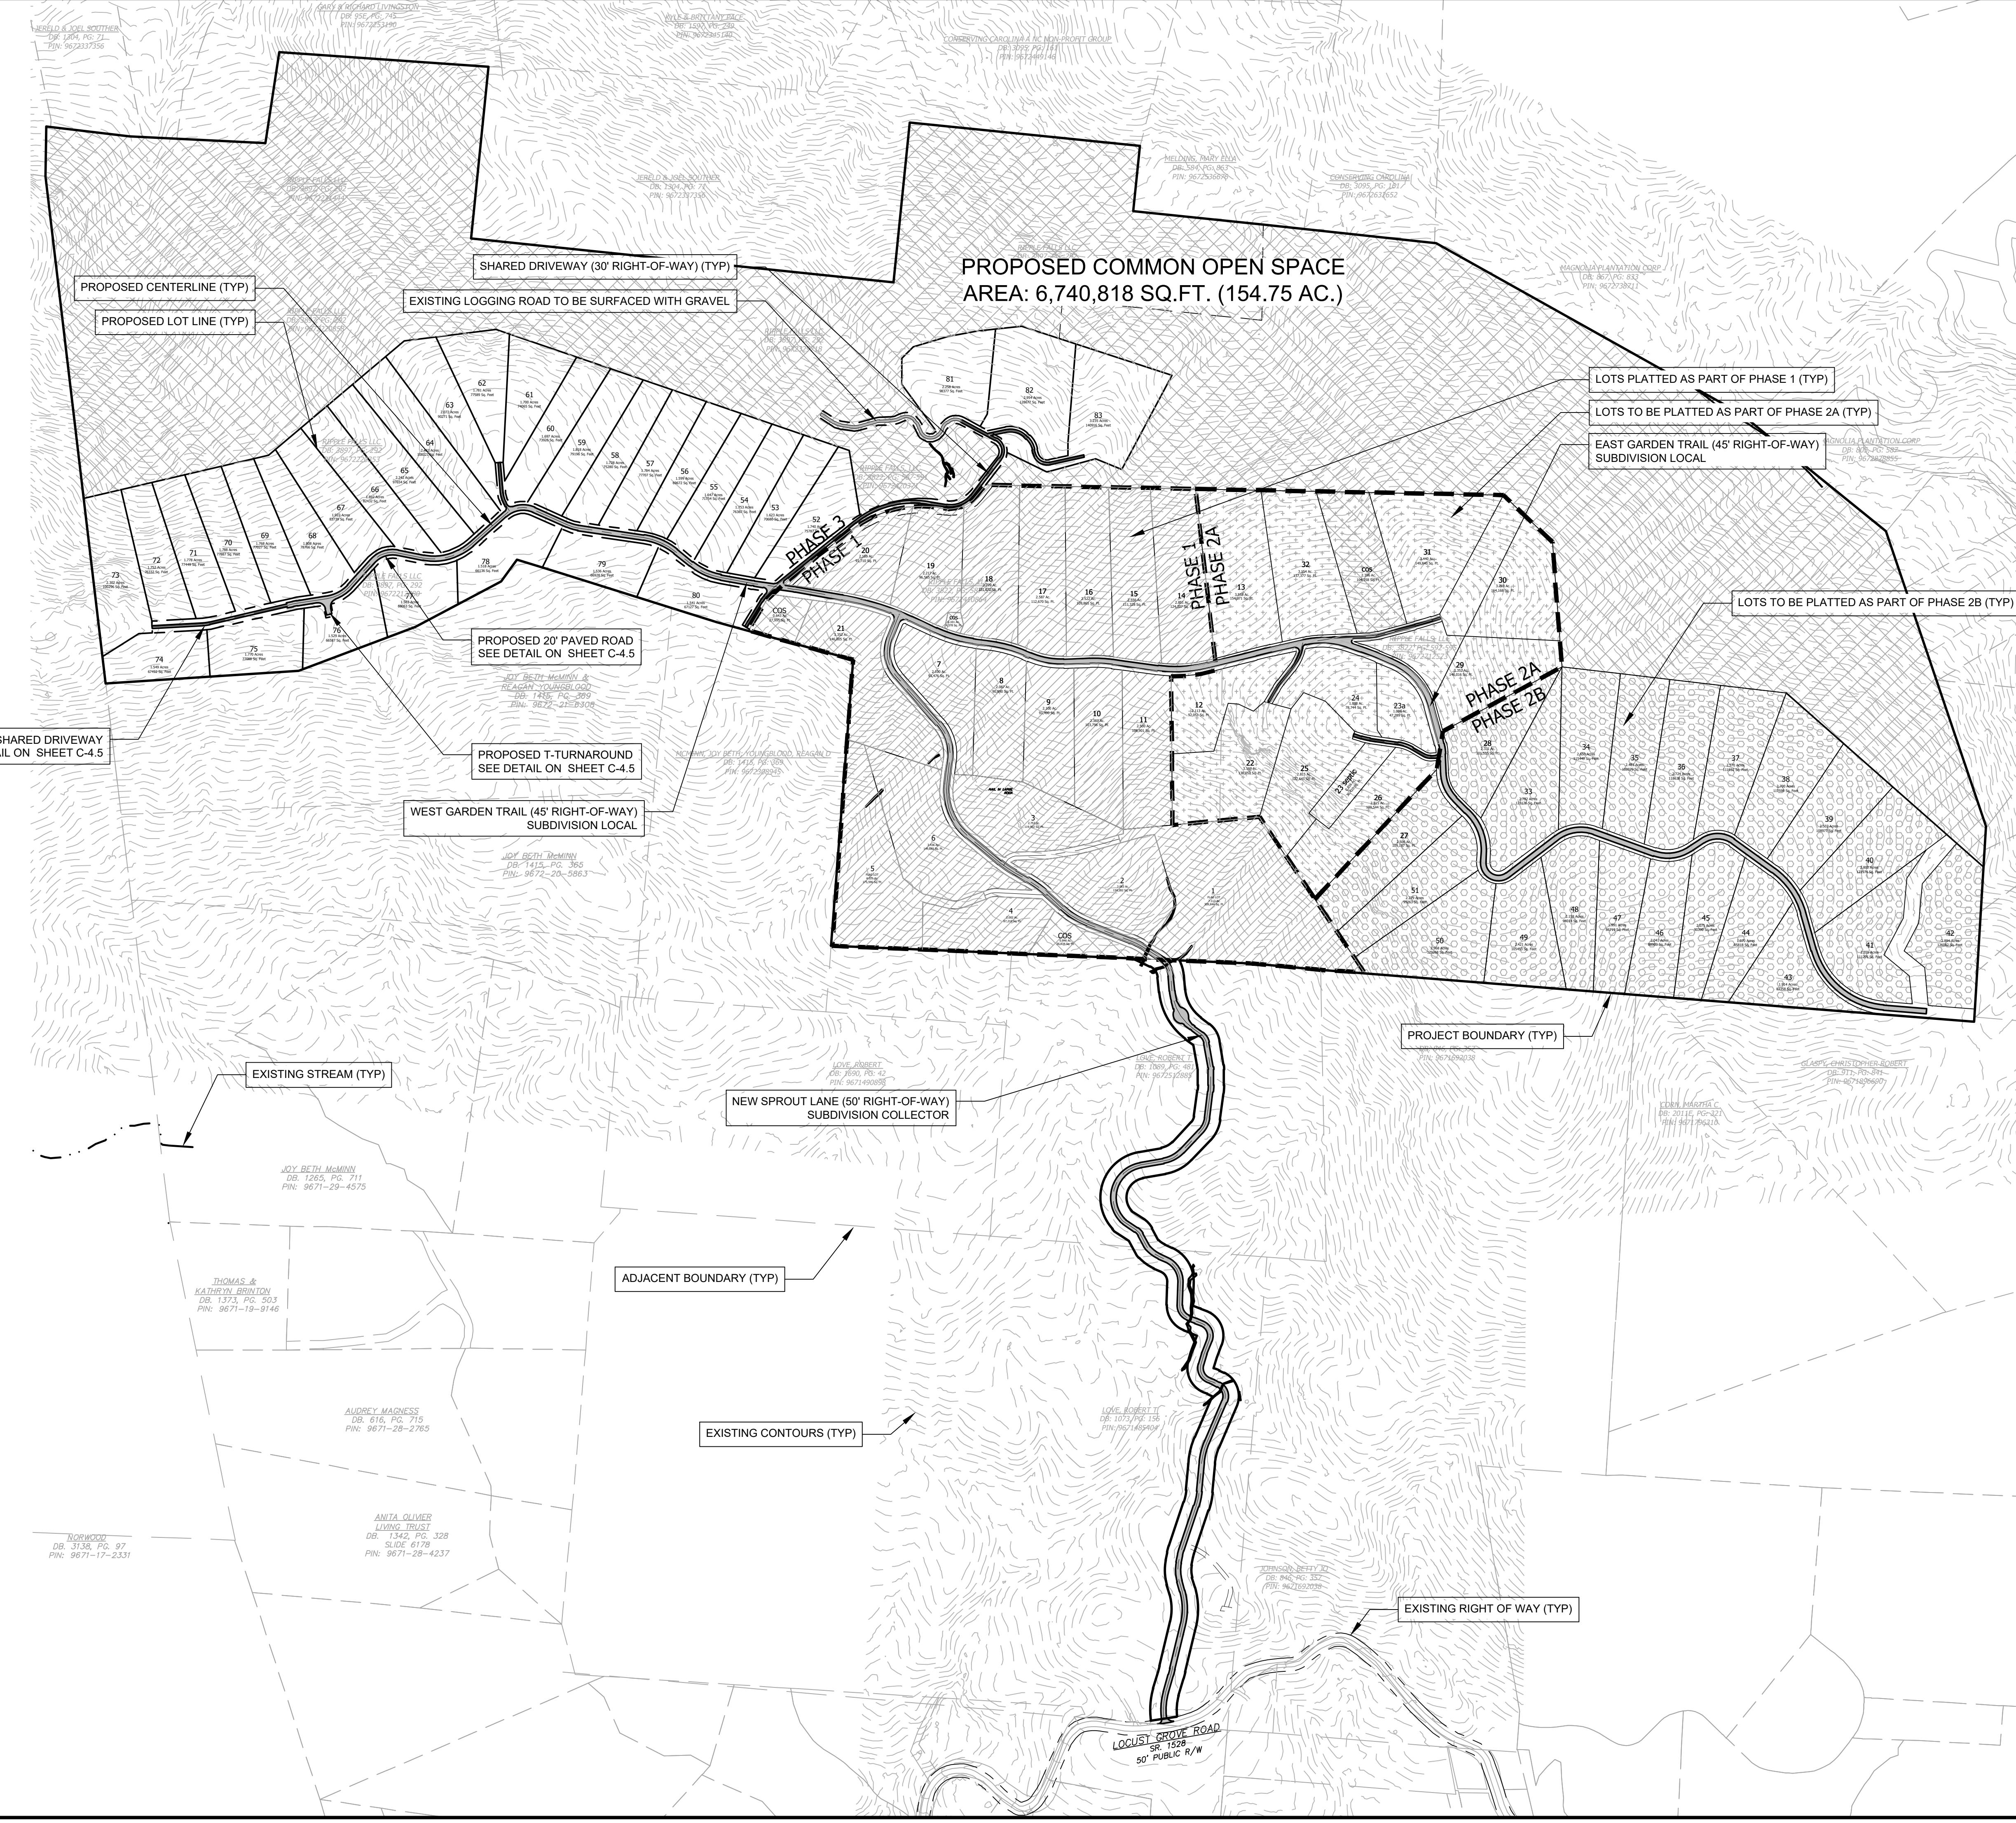

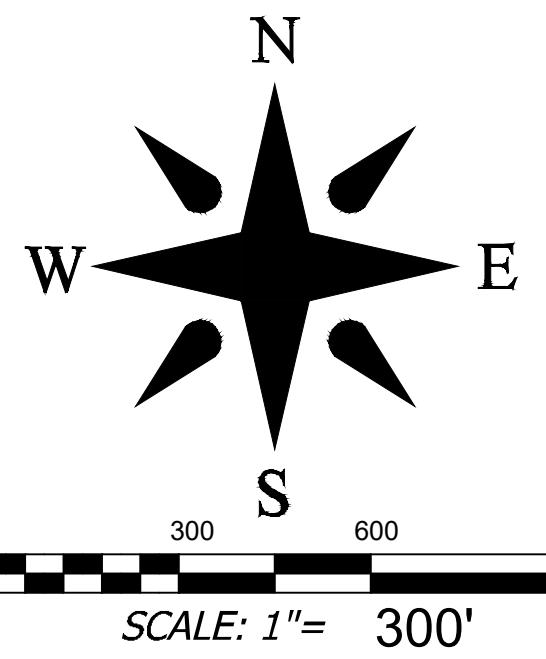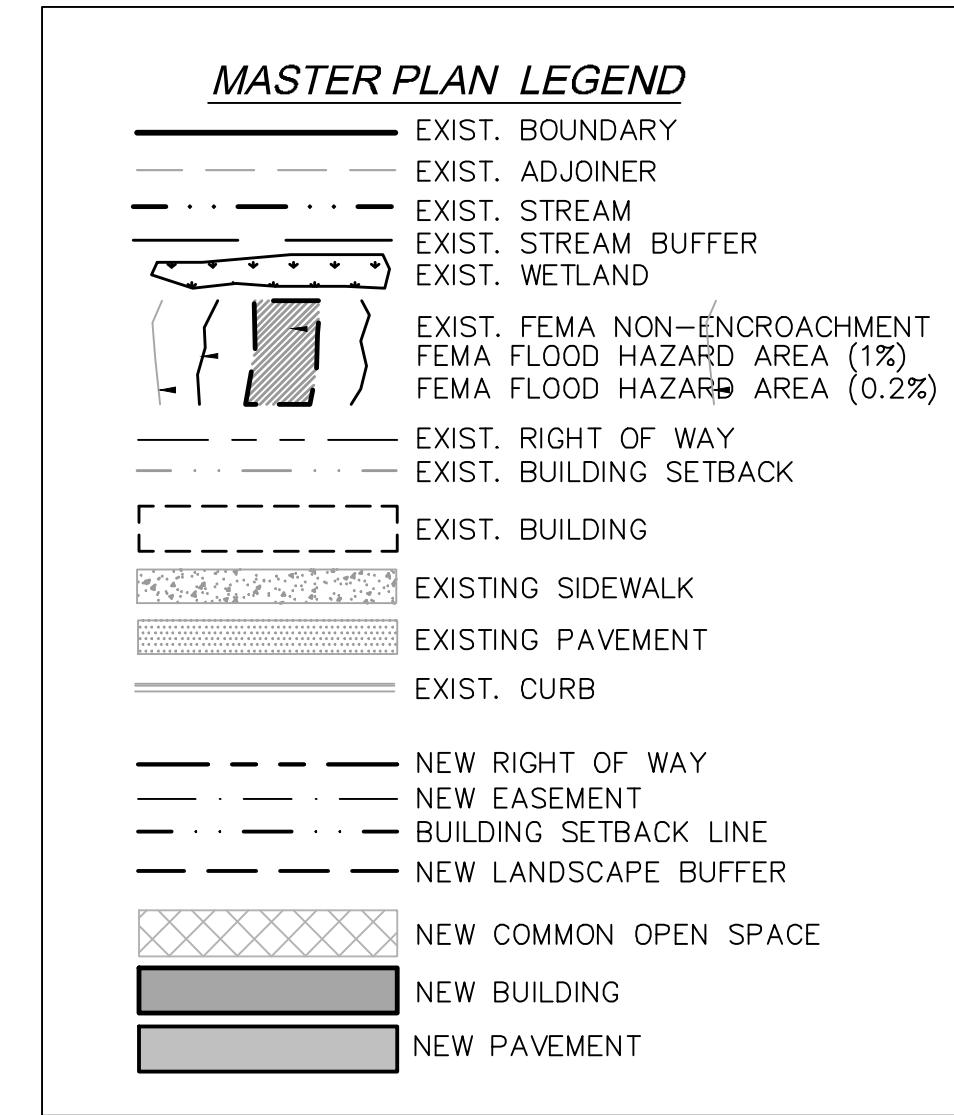
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PROPERTY OWNER:	RIPLEY FALLS LLC
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PHONE:	828-232-4700



Project No: 543521	RICH MOUNTAIN PHASE 3 MAJOR SUBDIVISION		
Drawing Title: C-1.1	HENDERSON COUNTY NORTH CAROLINA		
<b>PHASING PLAN</b>			
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Revision number within a triangle indicates changes made on this sheet			
 <b>FINAL DRAWING - FOR REVIEW PURPOSES ONLY</b>			
			
Reviewed: JHK Drawn: ZAW Scale: 1:2000 Checked: JHK Date: 12-15-2022 Phone: 1-828-232-1331 Fax: 1-828-232-4700 <a href="http://www.brooksea.com">www.brooksea.com</a>			

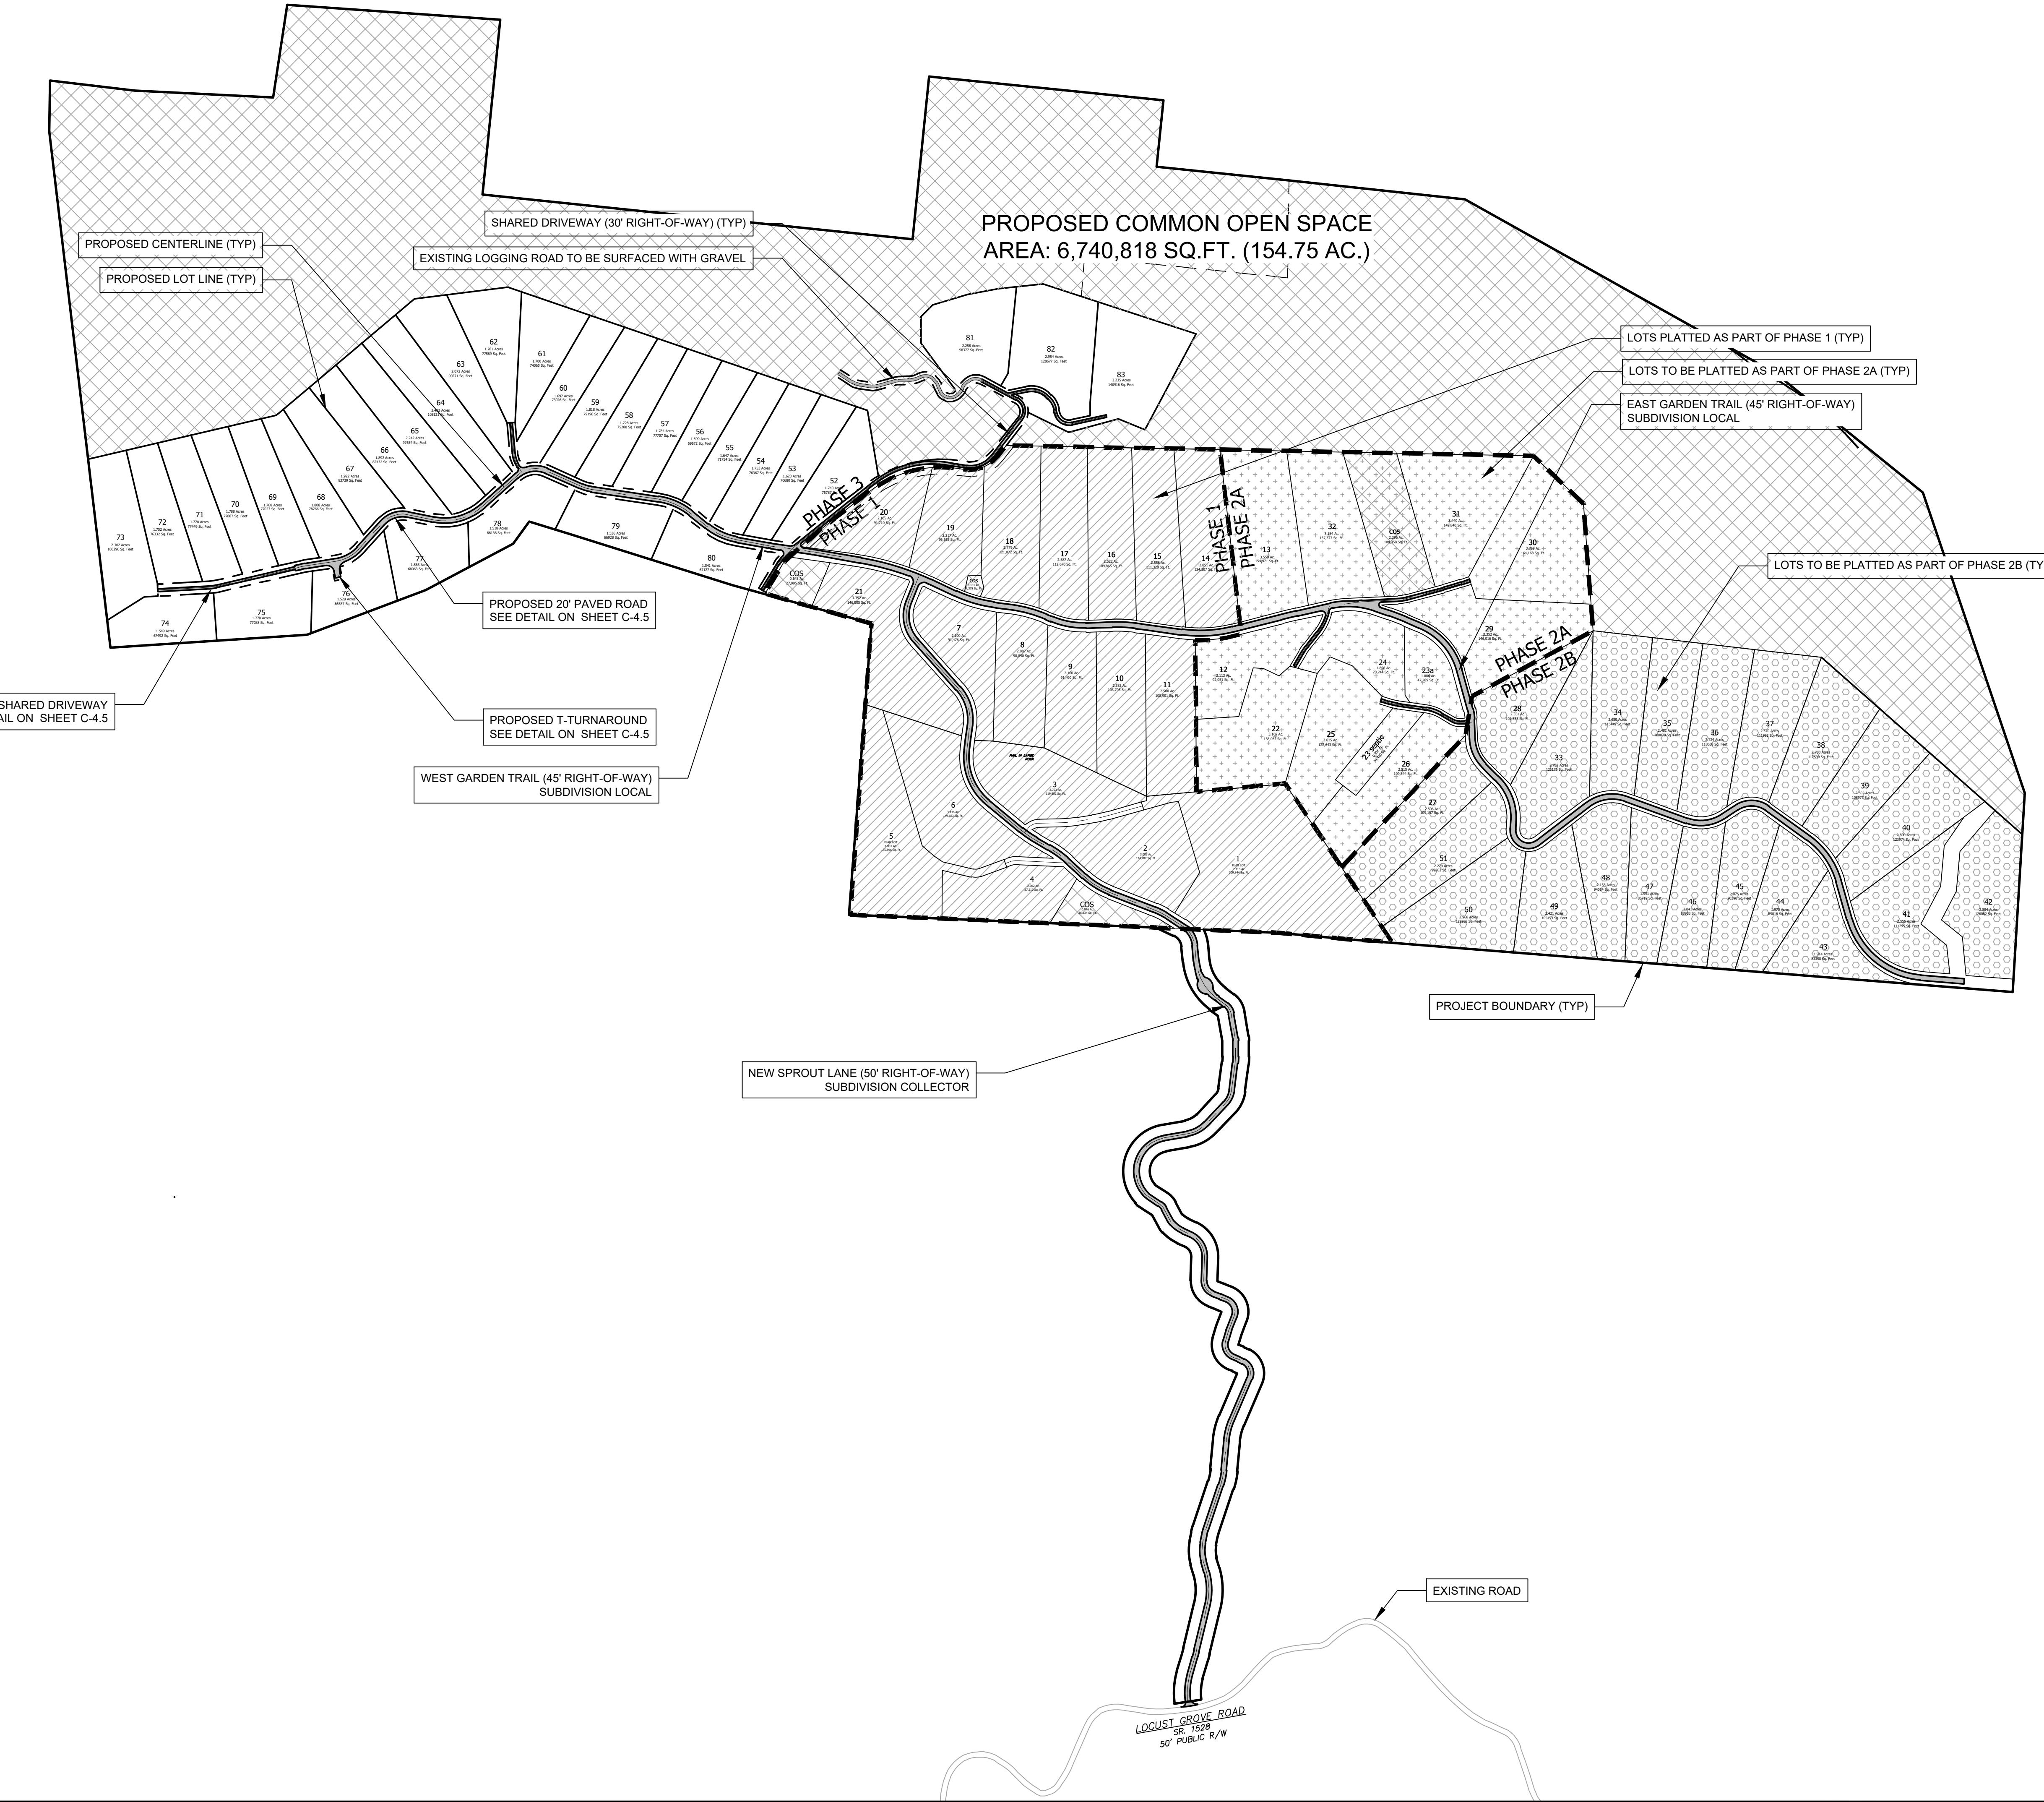

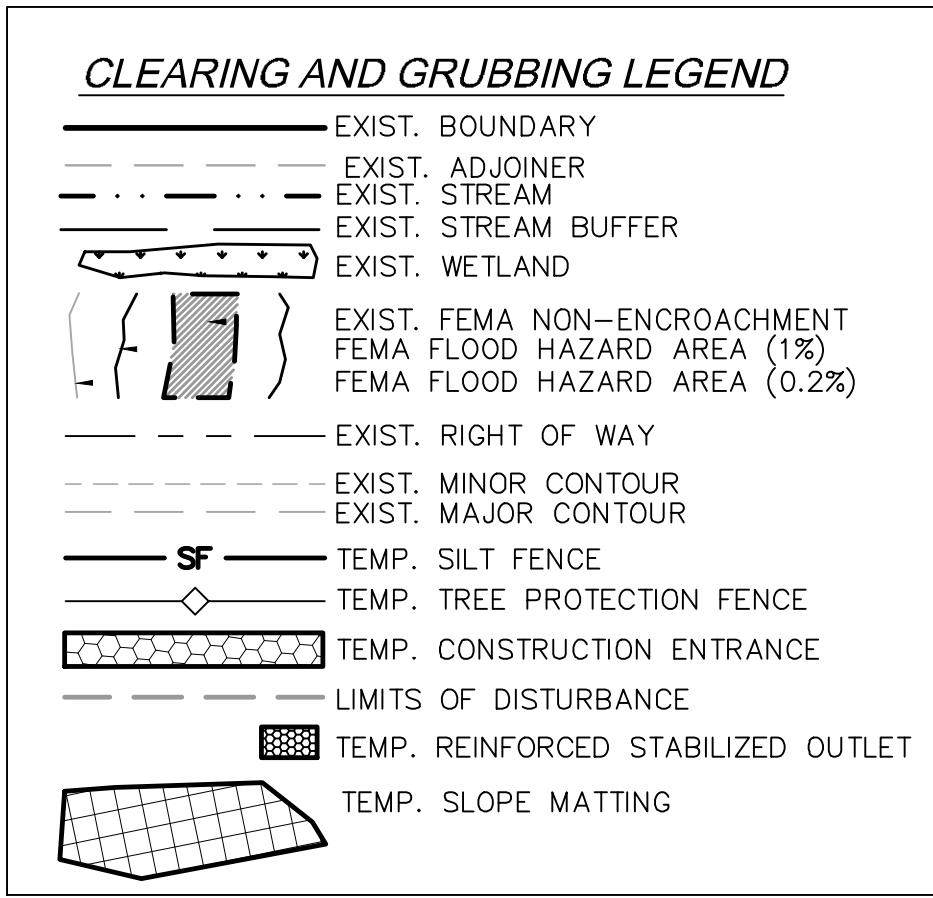




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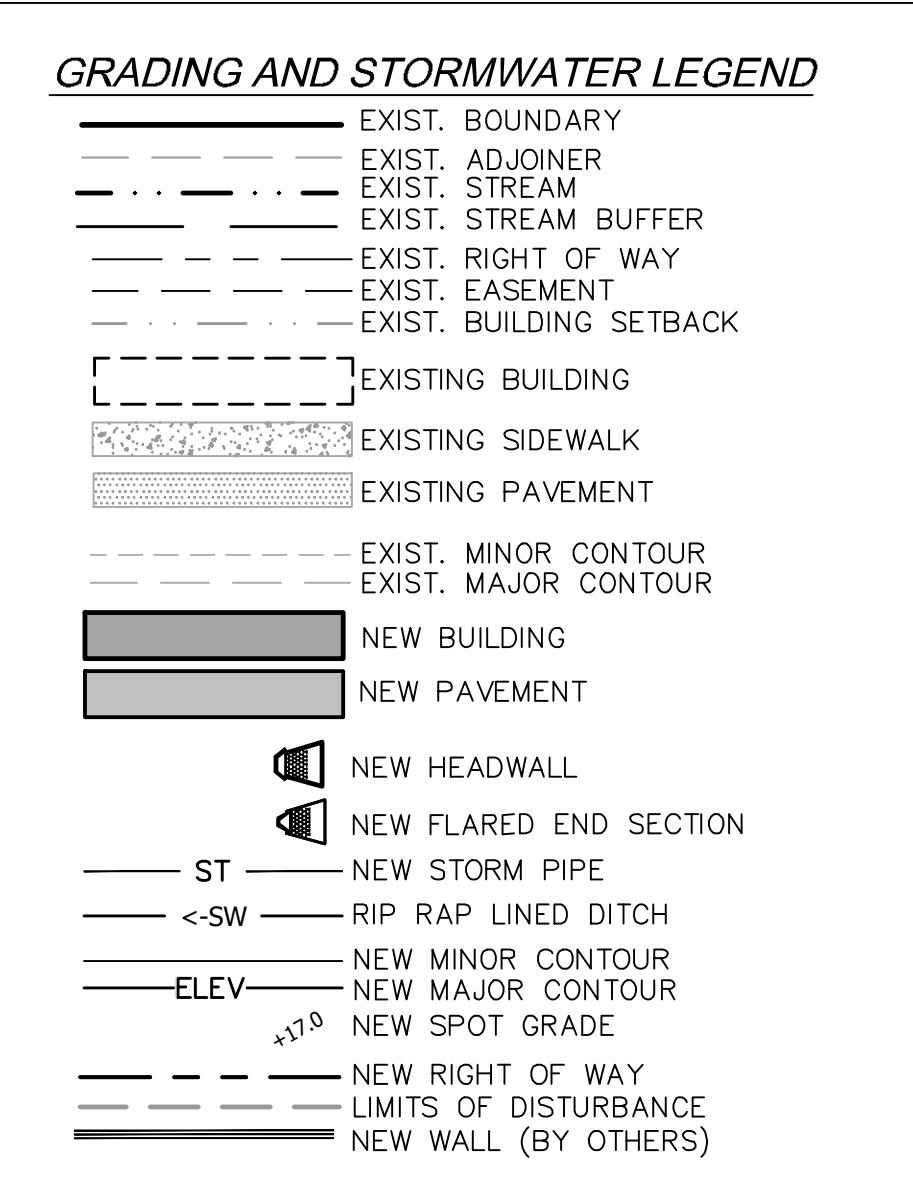
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#### EROSION CONTROL NOTES

- ALL EROSION MEASURES AND PRACTICES SHALL BE IN ACCORDANCE WITH THE APPROPRIATE JURISDICTION'S DETAILS AND SPECIFICATIONS.
- IN ACCORDANCE WITH THE NPDES GENERAL STORMWATER PERMIT, THE FOLLOWING REQUIREMENTS MUST BE MET:
  - THE EROSION CONTROL PLAN MUST BE IMPLEMENTED - DEVIATIONS ARE A VIOLATION OF THE PERMIT.
  - A COPY OF ALL PLANS MUST BE RETAINED BY THE PERMIT DEPOSITION OF SEDIMENT OFFSITE OR IN A STREAM OR WETLAND ARE CONSIDERED A VIOLATION OF THE PERMIT.
  - VISIBLE DEPOSITION OF SEDIMENT SHALL BE REPORTED TO NCDEQ WITHIN 24 HOURS OF INSPECTION.
  - A RAIN GAUGE SHALL BE MAINTAINED ON SITE.
  - A WRITTEN RECORD OF THE DAILY RAINFALL AMOUNTS SHALL BE RETAINED.
  - AT LEAST ONCE PER WEEK, EACH EROSION CONTROL MEASURE SHALL BE INSPECTED TO ENSURE THAT IT IS OPERATING CORRECTLY AND RECORDS MAINTAINED.
  - INSPECTIONS SHALL ALSO BE MADE WITHIN 24 HOURS OF RAIN EVENTS OVER 1/2 INCH.
  - THE QUALITY OF ALL STORMWATER DISCHARGES SHALL BE OBSERVED AND RECORDED.
  - IF ANY VISIBLE SEDIMENTATION IS LEAVING THE SITE OR ENTERING WATERS OF THE STATE, CORRECTIVE ACTION SHALL BE TAKEN IMMEDIATELY TO CONTROL THE DISCHARGE OF SEDIMENTS.
  - AN APPROVED COPY OF THE E&S PLAN WITH PLACARD AND APPROVAL LETTER AND A COPY OF THE NPDES PERMIT, WITH A MINIMUM OF 30 DAYS OF SELF-INSPECTION REPORTS, ARE BE KEPT ON SITE UNTIL PROJECT CLOSURE BY NCDEQ. THEY MUST BE MADE AVAILABLE TO THE EROSION CONTROL INSPECTOR AS REQUIRED.
  - THE SELF-INSPECTION PROGRAM IS SEPARATE FROM THE WEEKLY SELF-MONITORING PROGRAM OF THE NPDES STORMWATER PERMIT FOR CONSTRUCTION ACTIVITIES. CONTRACTOR SHALL USE THE INSPECTION AND MONITORING RECORDS FOR ACTIVITIES UNDER STORMWATER GENERAL PERMIT NCG010000 AND SELF-INSPECTION RECORDS FOR LAND DISTURBING ACTIVITIES PER G.S. 113A-54.1. THE INSPECTIONS SHOULD BE CONDUCTED AFTER EACH PHASE OF THE PROJECT, AND CONTINUED UNTIL PERMANENT GROUND COVER IS ESTABLISHED.
  - ALL DRAINAGE EASEMENTS MUST BE GRASSED AND/OR RIP-RAPPED PER THE PLANS TO CONTROL EROSION.
  - THE ESCAPE OF SEDIMENT FROM THE SITE SHALL BE PREVENTED BY THE INSTALLATION OF EROSION AND SEDIMENT CONTROL MEASURES AND PRACTICES PRIOR TO, OR CONCURRENT WITH, LAND-DISTURBING ACTIVITIES.
  - EROSION CONTROL MEASURES WILL BE MAINTAINED AT ALL TIMES. IF FULL IMPLEMENTATION OF THE APPROVED PLAN DOES NOT PROVIDE FOR EFFECTIVE EROSION CONTROL, ADDITIONAL EROSION AND SEDIMENT CONTROL MEASURES SHALL BE IMPLEMENTED TO CONTROL OR TREAT THE SEDIMENT SOURCE AND AN AMENDED PLAN BE SUBMITTED AND APPROVED SHOWING MODIFIED EROSION CONTROL DEVICES.
  - A RAIN GAUGE WILL BE INSTALLED ON THE SITE.
  - THE SITE SHALL RECEIVE TEMPORARY/PERMANENT SEEDING WHEN CONSTRUCTION IS COMPLETE OR DELAYED FOR ANY REASON. SEE SHEET C-3.9 FOR A DETAILED TIME FRAME.
  - CONTRACTOR TO PROVIDE SHEET PROTECTION AT EACH STRUCTURE AS STORMWATER IS DRAINED.
  - STOCKPILE STAGING, AND LAYDOWN AREAS ARE TO BE WITHIN THE LIMITS OF DISTURBANCE AND SHOULD BE LOCATED AT LEAST 50 FEET AWAY FROM STORM DRAIN OUTLETS AND SURFACE WATERS.
  - CONTACT HENDERSON COUNTY SITE DEVELOPMENT 48 HOURS PRIOR TO COMMENCEMENT OF LAND DISTURBING ACTIVITIES.




Project No: 543521	RICH MOUNTAIN PHASE 3 MAJOR SUBDIVISION HENDERSON COUNTY NORTH CAROLINA	Reviewed: JHK Scale: ZAW Checked: JHK Date: 12-15-2022	No. 1 REVISIONS/SUBMISSIONS 1 HENDERSON COUNTY PLANNING 12-15-2022
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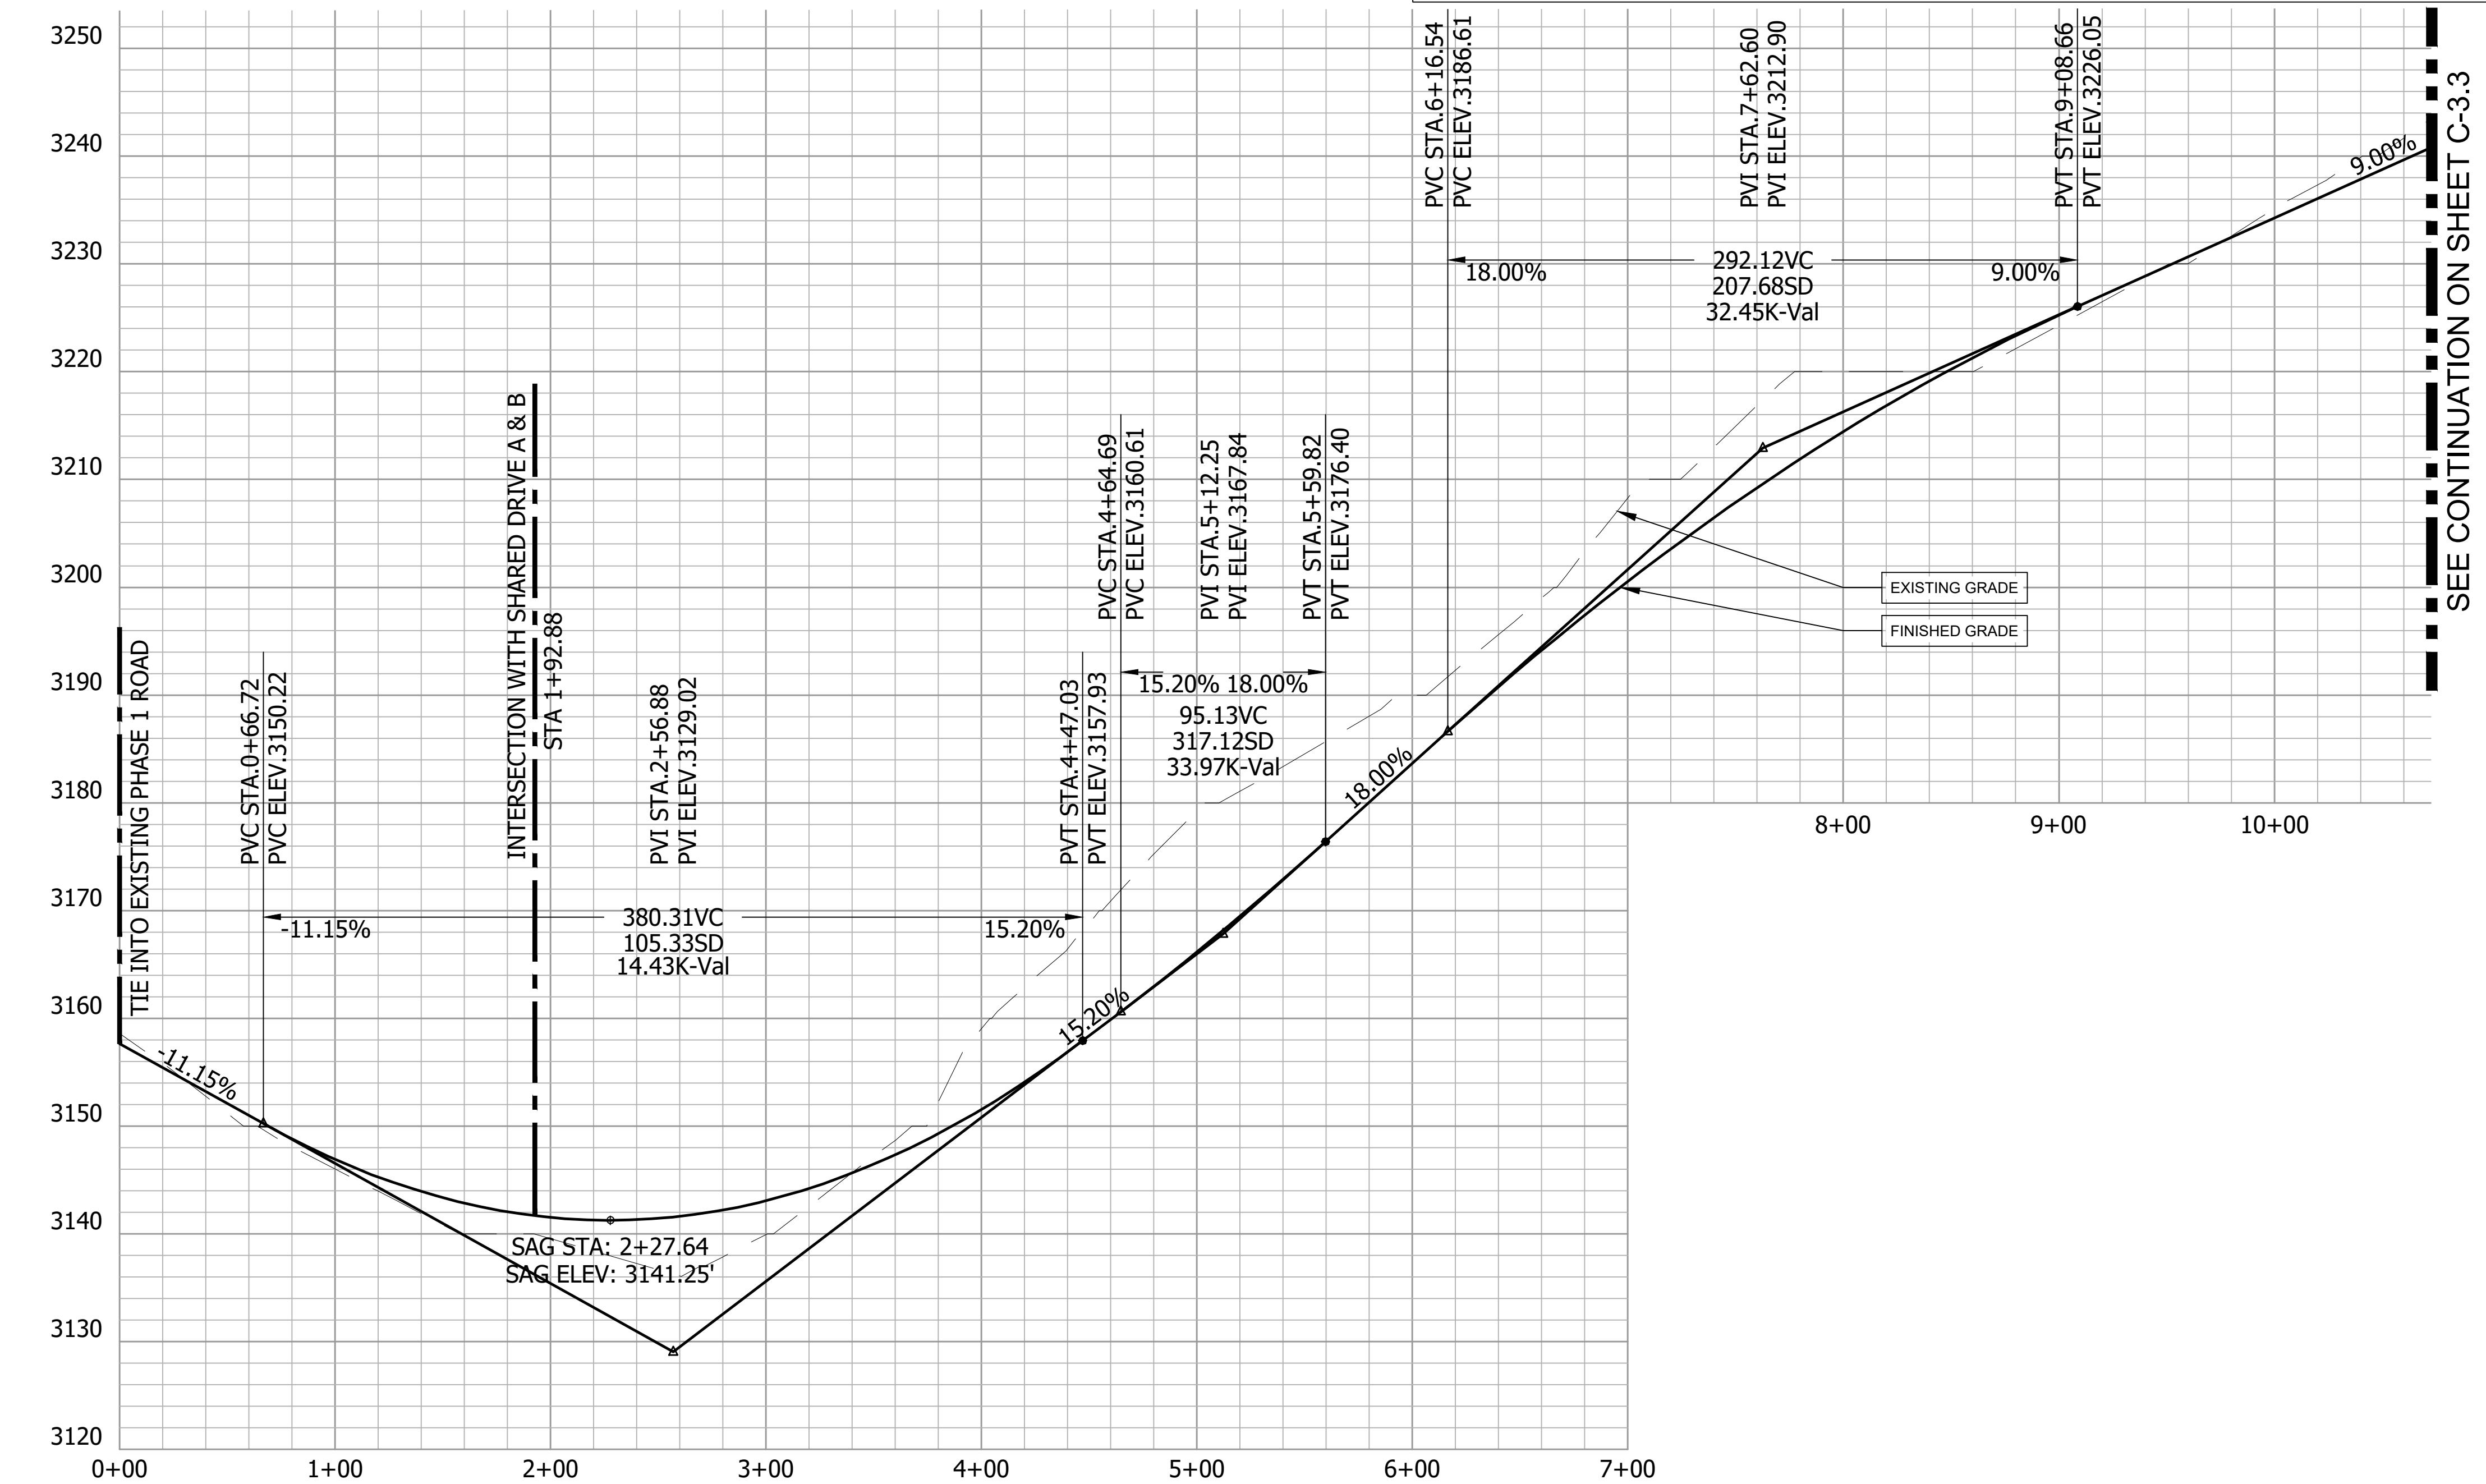
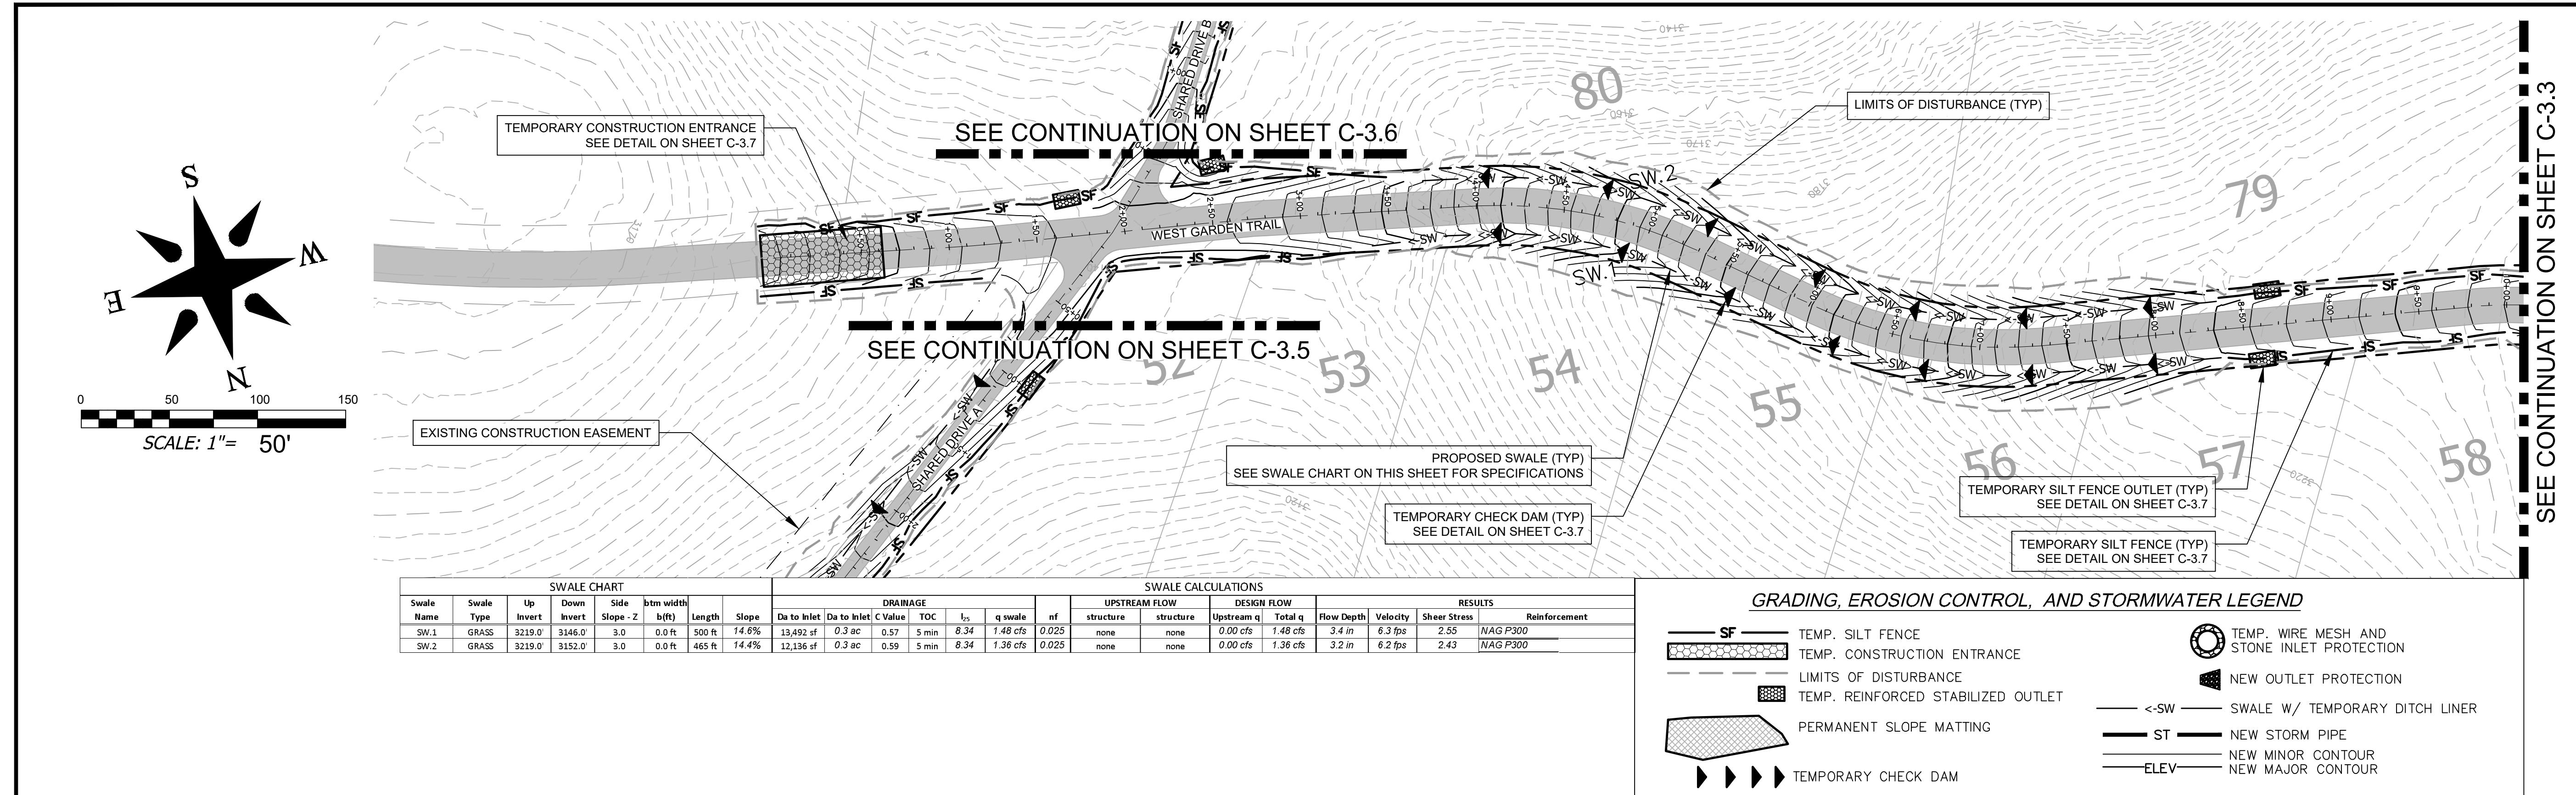

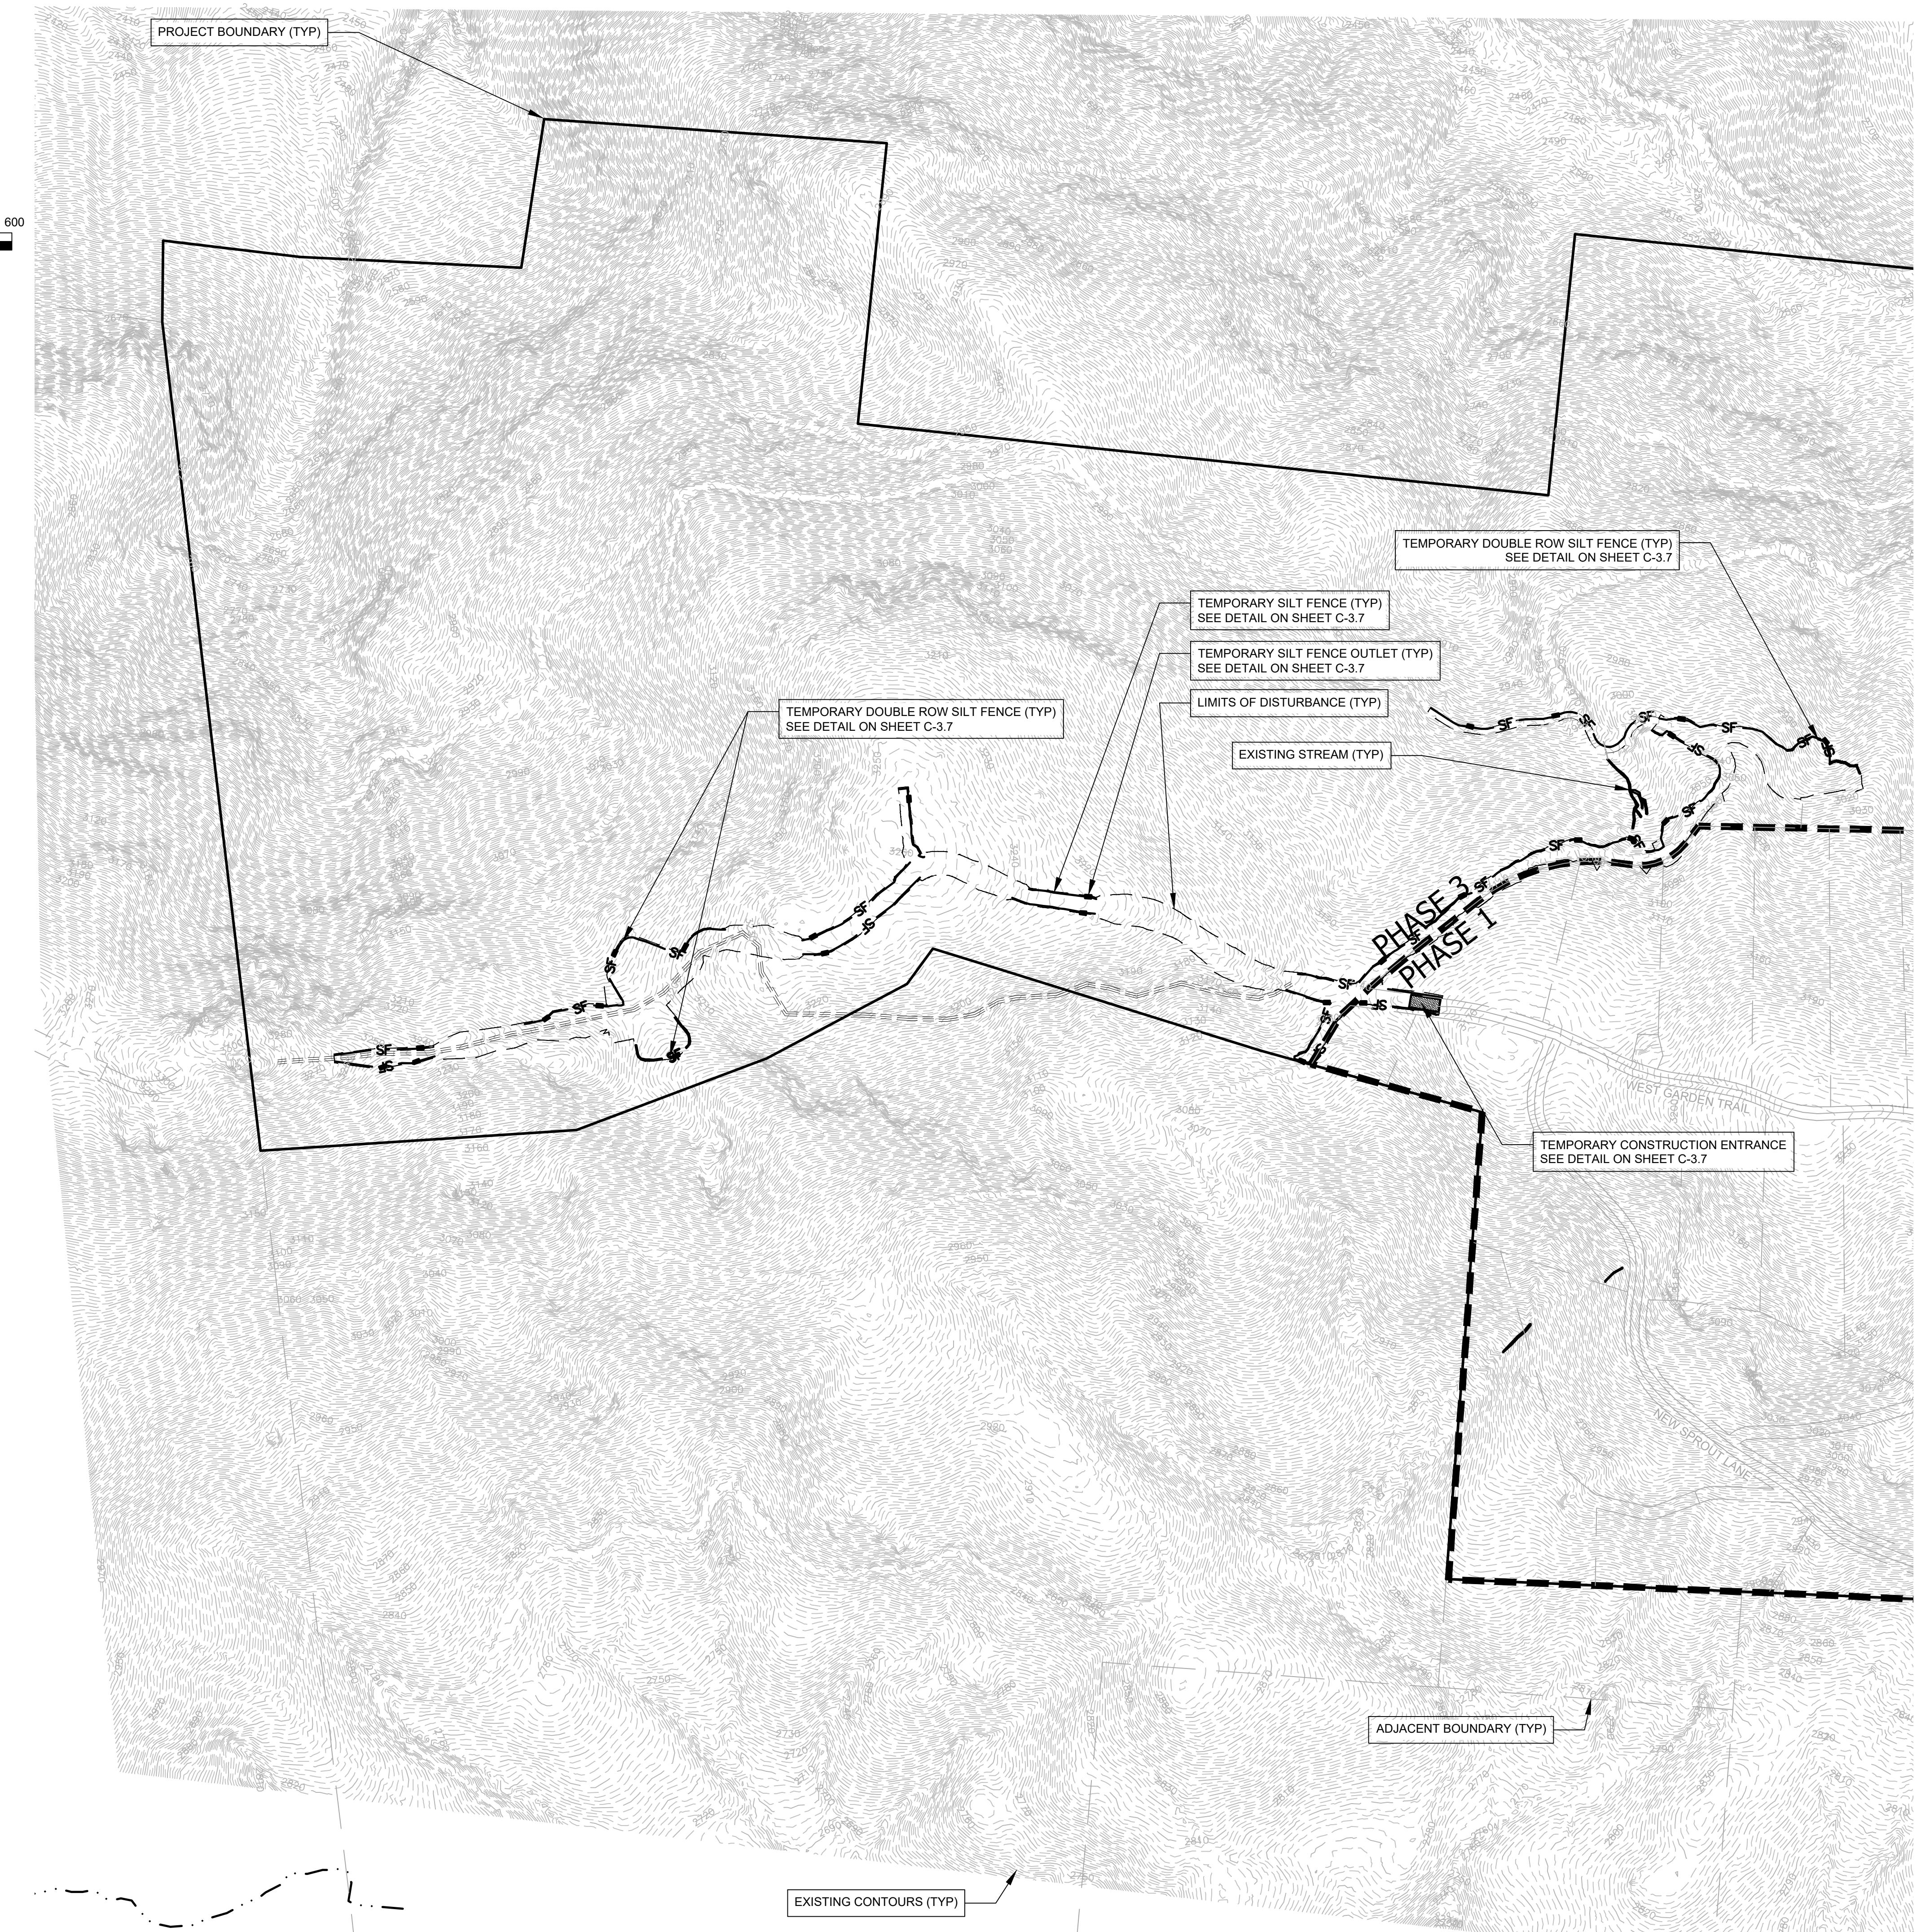
<b>DEVELOPMENT DATA</b>	
PROPERTY ADDRESS:	LOCUST GROVE ROAD HENDERSONVILLE NC
PIN NUMBER:	SEE COVER SHEET
PROPERTY SIZE:	PH3: 150.06 AC. - TOTAL: 377.96 AC.
ZONING REVIEW:	HENDERSON COUNTY
EROSION CONTROL REVIEW:	HENDERSON COUNTY
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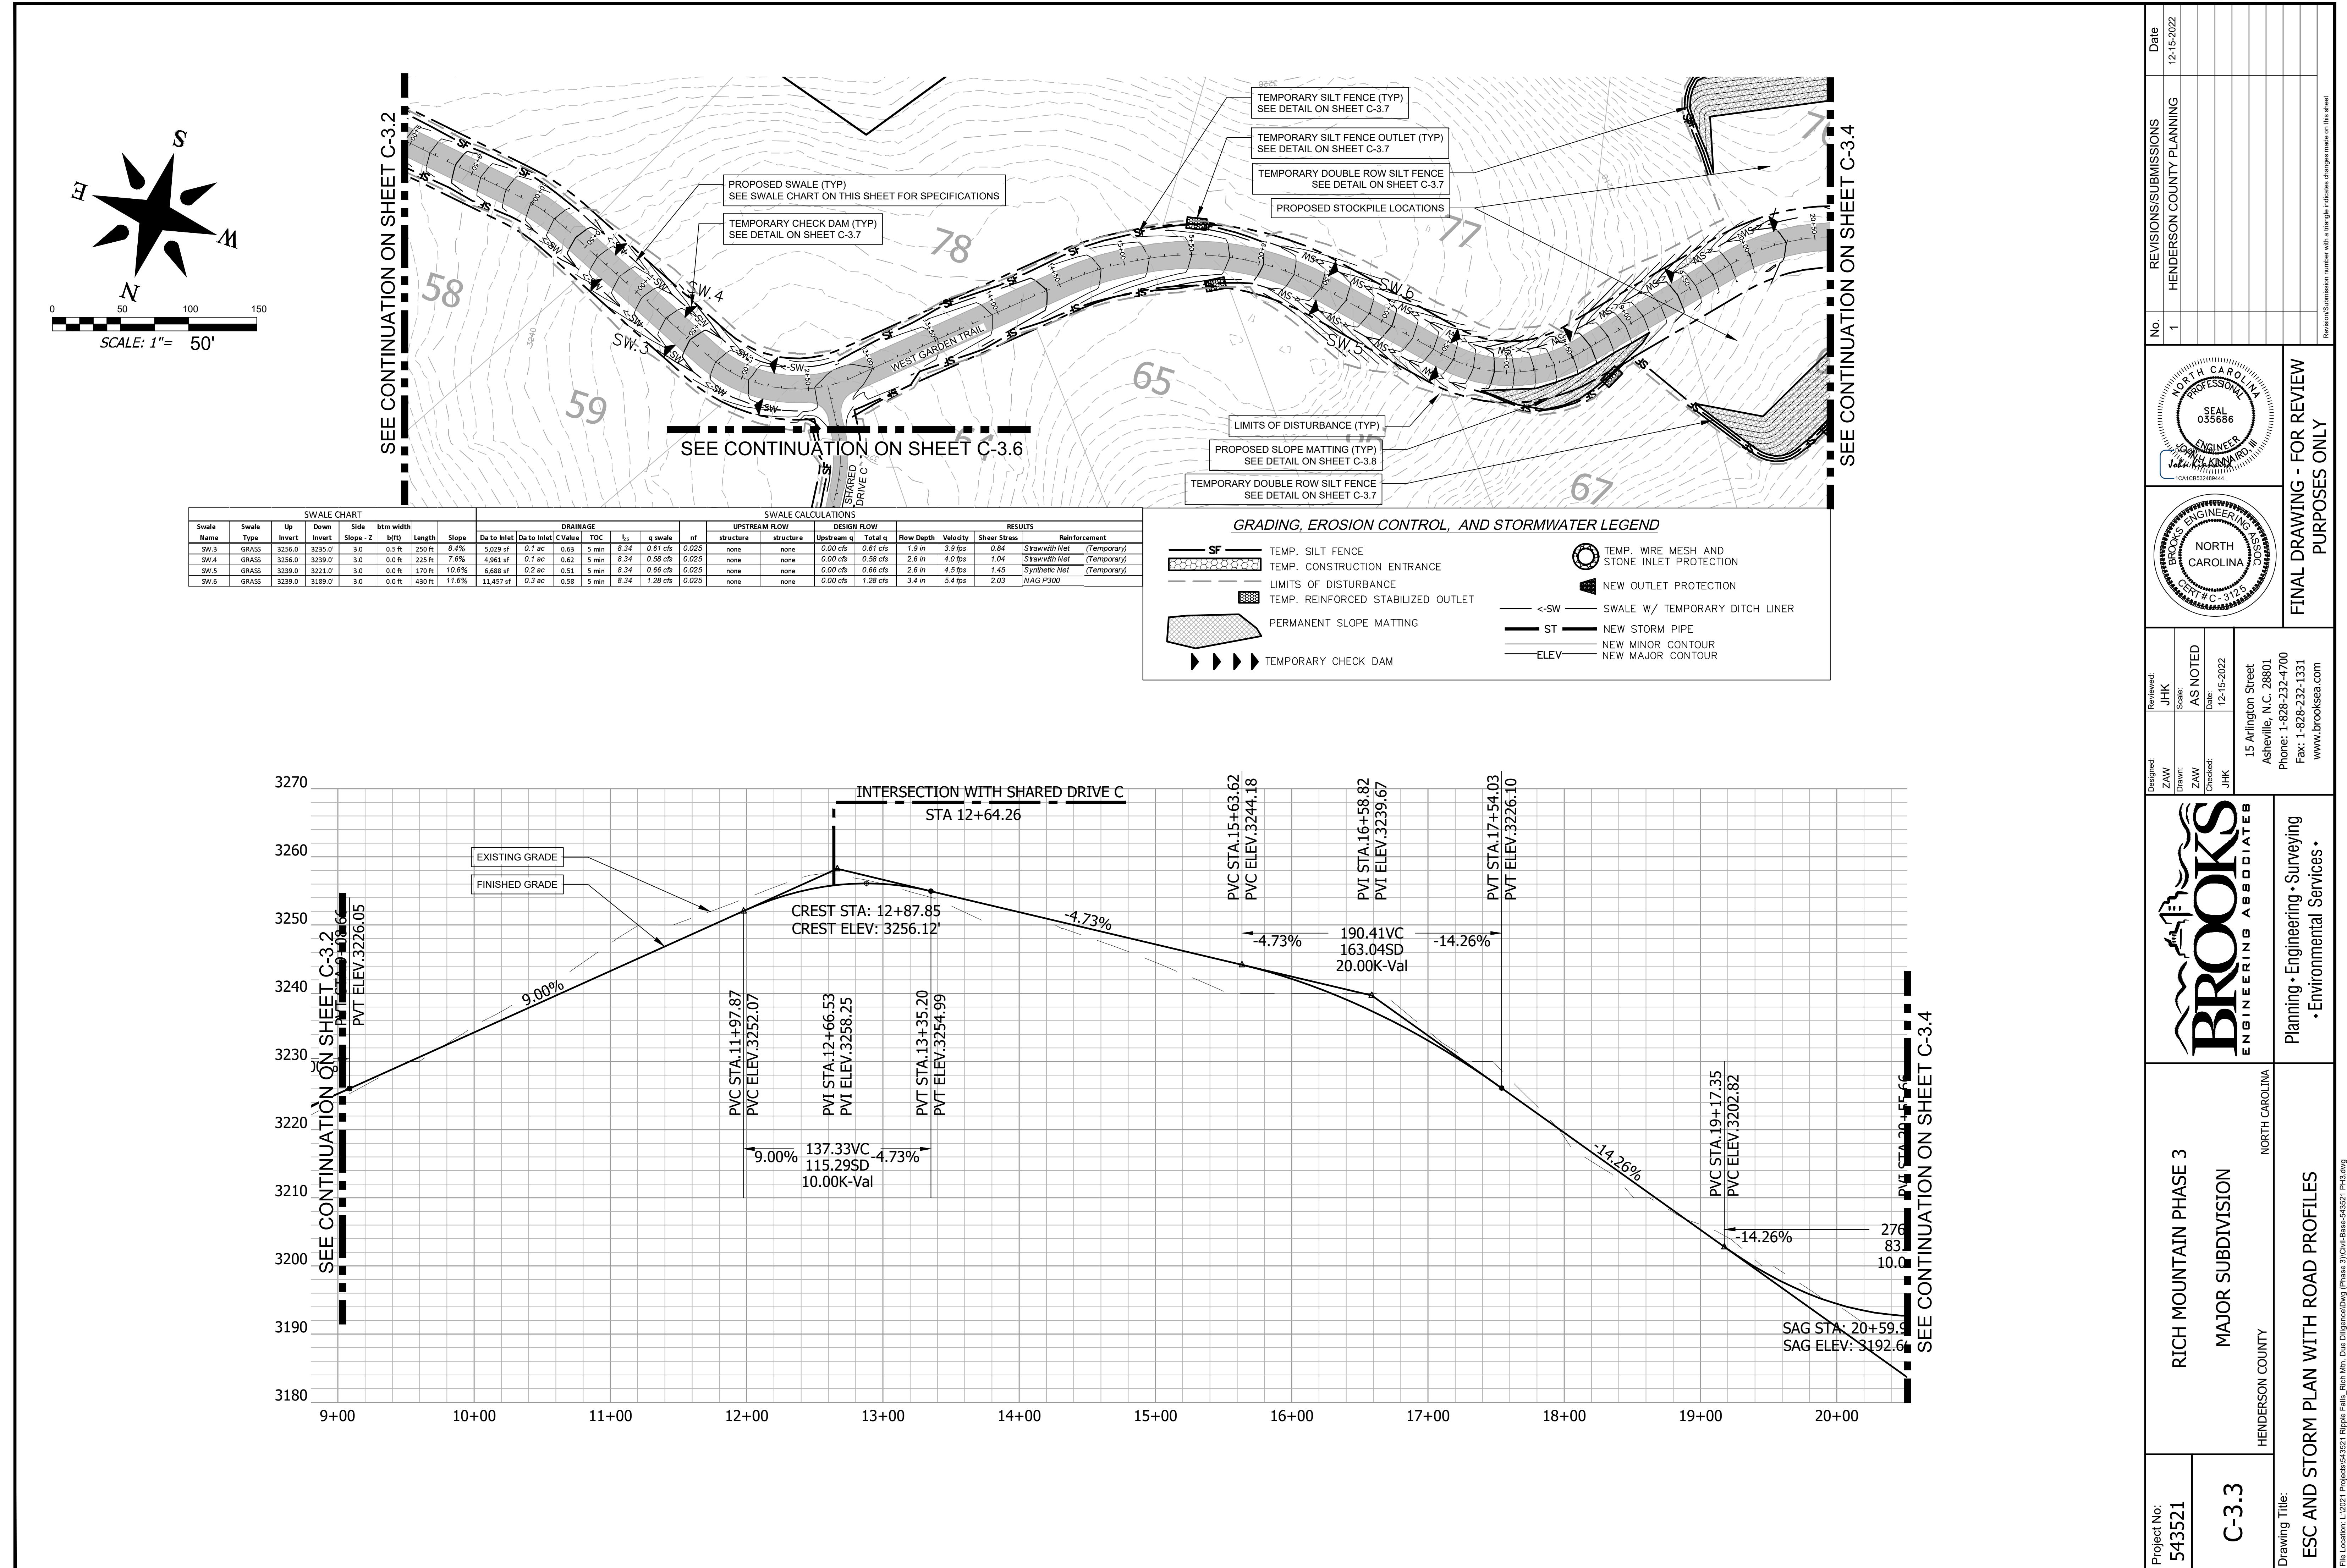
<b>STORM AND EROSION NOTES</b>	
PROPERTY SIZE:	PH3: 150.06 AC. - TOTAL: 377.96 AC.
PROPERTY STEEPER THAN 60%:	16.76 AC. (6.82%)
PROJECT DENSITY:	PH3: 0.21 LOTS/AC. - TOTAL 0.22 LOTS/AC.
IMPERVIOUS SUMMARY:	
ROADS:	PH3: 1.48 AC. - TOTAL: 6.68 AC.
HOUSES & DRIVES (15,000 SF / LOT):	11.02 AC. - TOTAL: 28.58 AC.
TOTAL:	12.50 AC. (8.3%) - 35.26 AC. (9.3%)
EROSION CONTROL NOTES:	
1. SEE SHEET C-3.9 FOR STABILIZATION TIME FRAMES.	
2. EROSION CONTROL MEASURES WILL BE MAINTAINED AT ALL TIMES, IF FULL IMPLEMENTATION OF THE APPROVED PLAN DOES NOT PROVIDE FOR EFFECTIVE EROSION CONTROL, ADDITIONAL EROSION AND SEDIMENT CONTROL MEASURES SHALL BE IMPLEMENTED TO CONTROL OR TREAT THE SEDIMENT SOURCE AND AN AMENDED PLAN BE SUBMITTED AND APPROVED SHOWING MODIFIED EROSION CONTROL DEVICES.	
STORMWATER NOTES:	
1. ALL STREAMS SHALL HAVE A 30' SETBACK FOR NEW BUILT-UPON AREAS.	
2. ALL PIPE SHALL BE DOUBLE-WALL HDPE WITH PROPER STONE BEDDING AND SHALL HAVE A MINIMUM COVER OF 30'.	
3. ALL FILL SLOPES SHALL BE COMPACTED FULL DEPTH TO NOT LESS THAN 95 PERCENT MAXIMUM DENSITY (STANDARD PROCTOR), SHALL BE PLACED ON A SURFACE CLEAR OF GROWTH AND DEBRIS AND BE PROPERLY BENCHED AND DRAINED.	
4. ALL SLOPES GREATER THAN 3:1 AND TALLER THAN 10 FEET SHALL BE SEDED AND COVERED WITH MATTING AS SHOWN IN THE PLANS.	
5. AN APPROVED GRADING PERMIT IS REQUIRED FOR ANY BORROW OR WASTE SITE PRIOR TO INITIATION OF ANY LAND DISTURBING ACTIVITY.	
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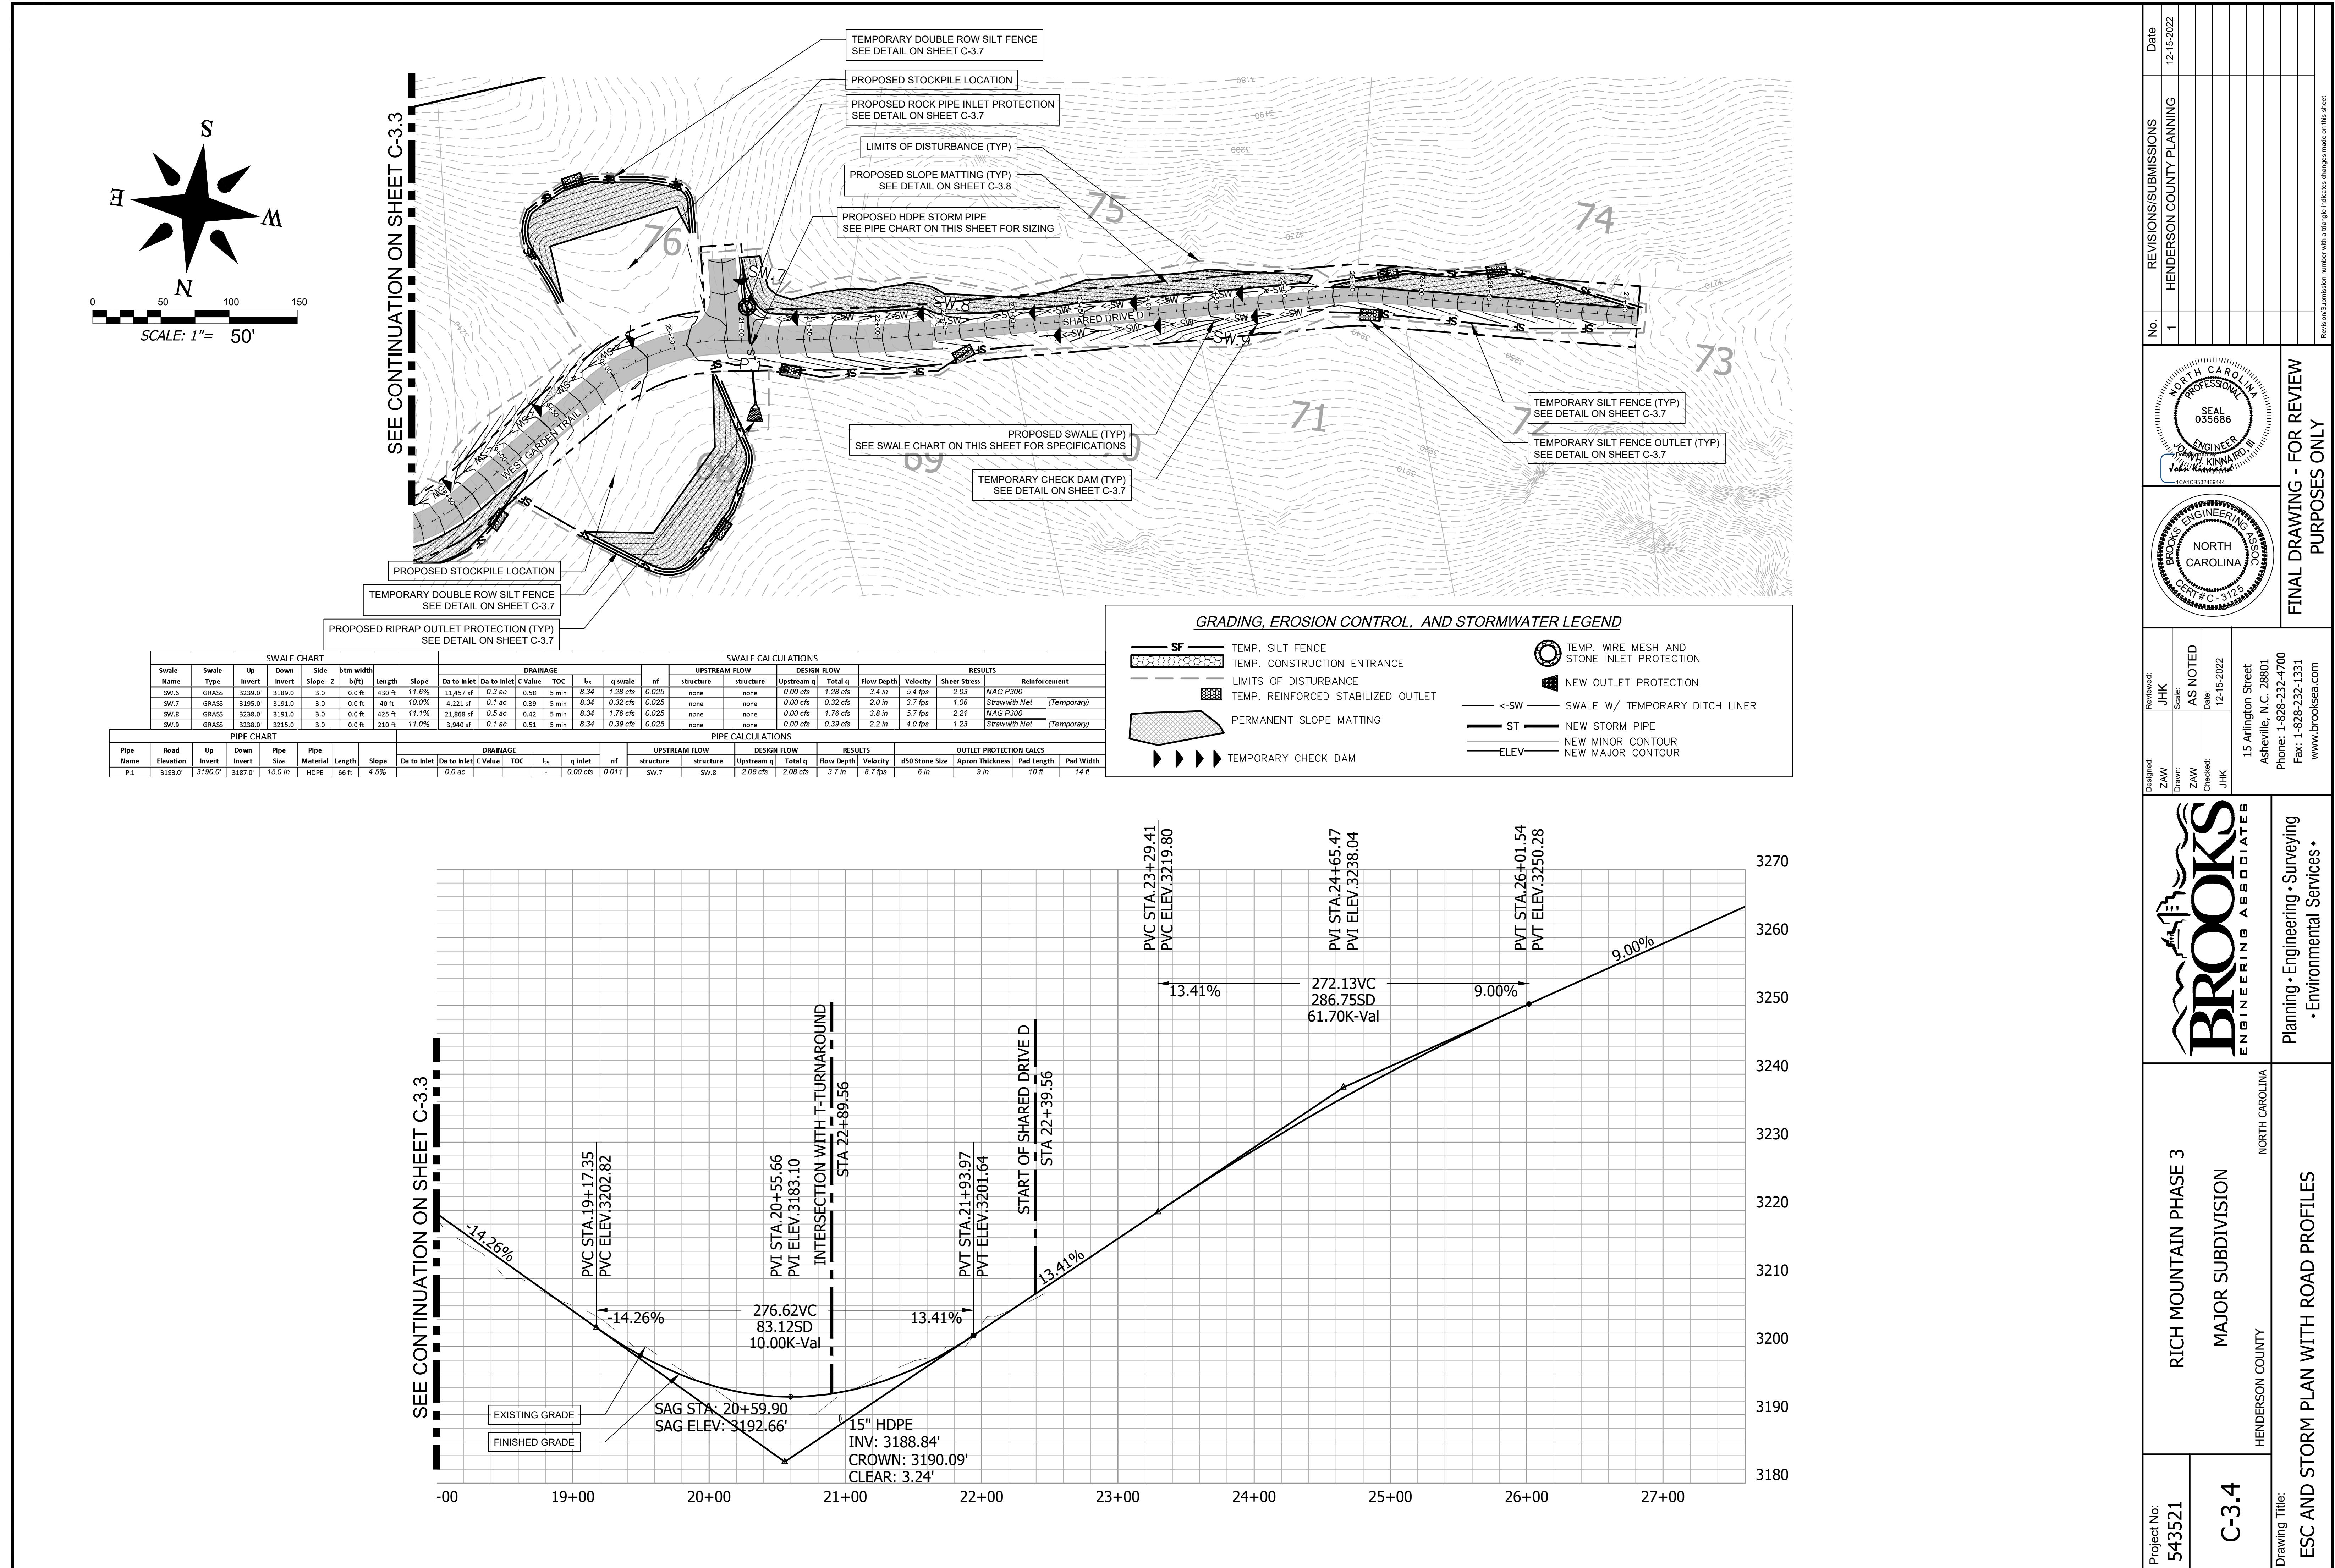


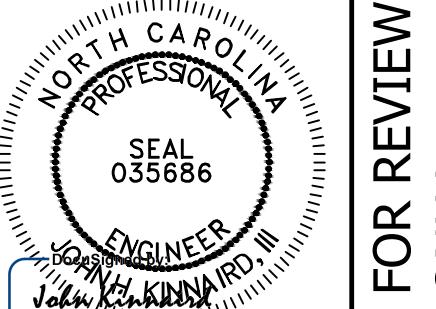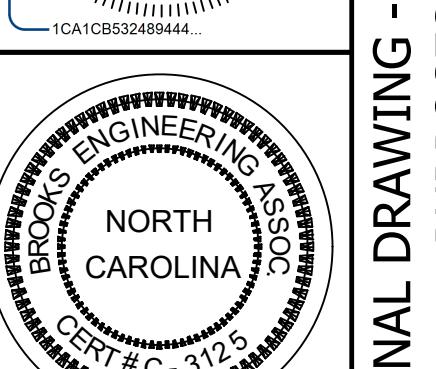
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MAJOR SUBDIVISION		HENDERSON COUNTY, NORTH CAROLINA		
Drawing Title: C-3.1				
Date: 12-15-2022	No. 1	REVISION/SUBMISSIONS		REVISION number within a triangle indicates changes made on this sheet
1 HENDERSON COUNTY PLANNING				
No. 1 JAH Kinnaird III, PE, SCS, CEM-C, 3125				
 				
FINAL DRAWING - FOR REVIEW PURPOSES ONLY				
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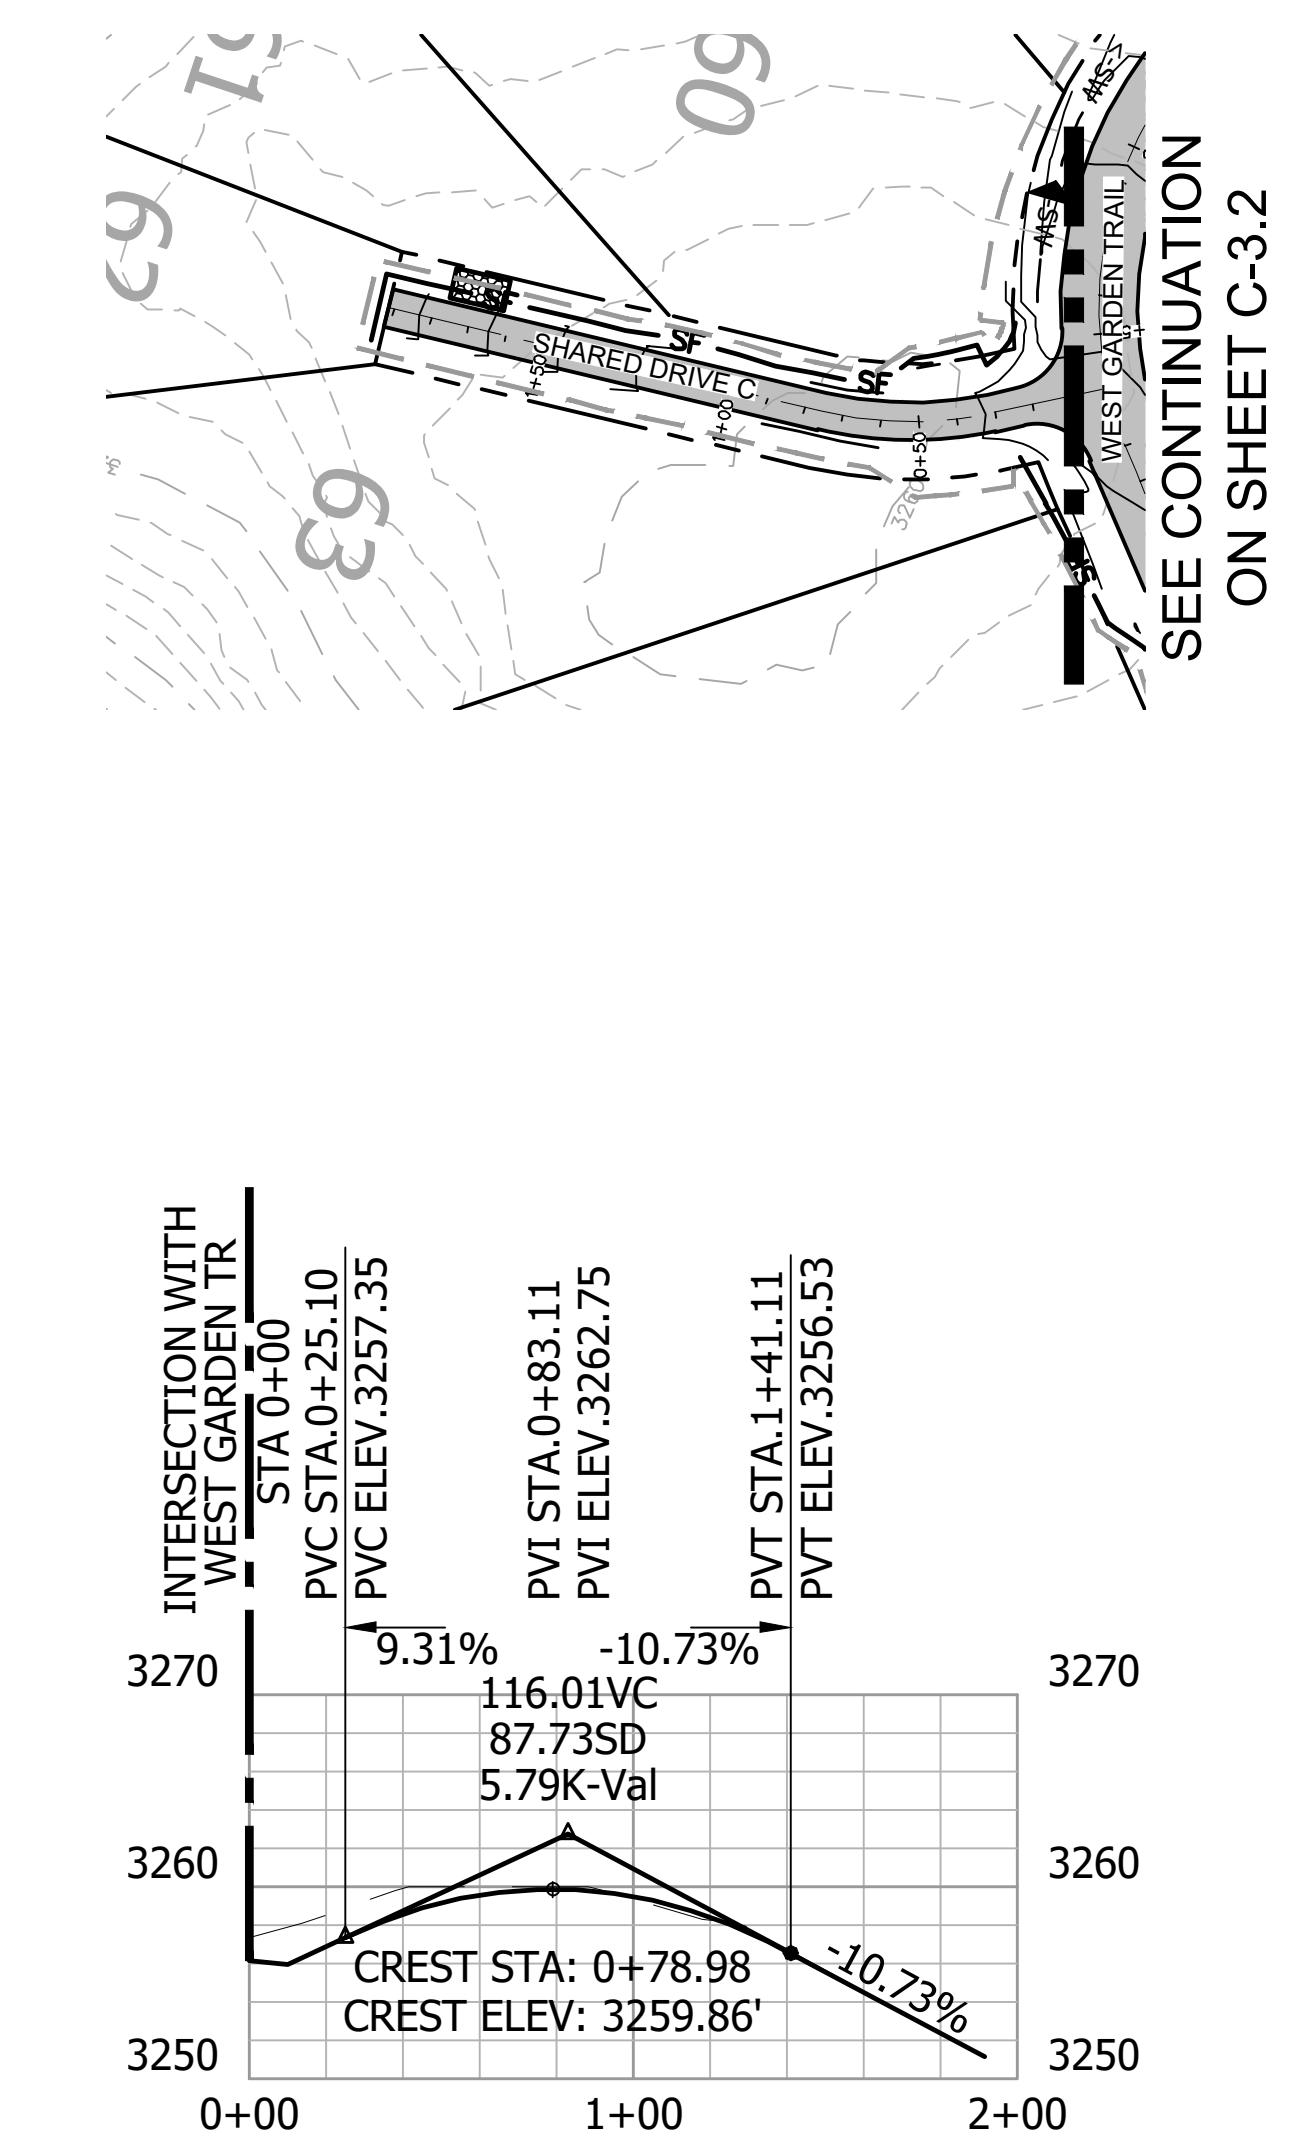
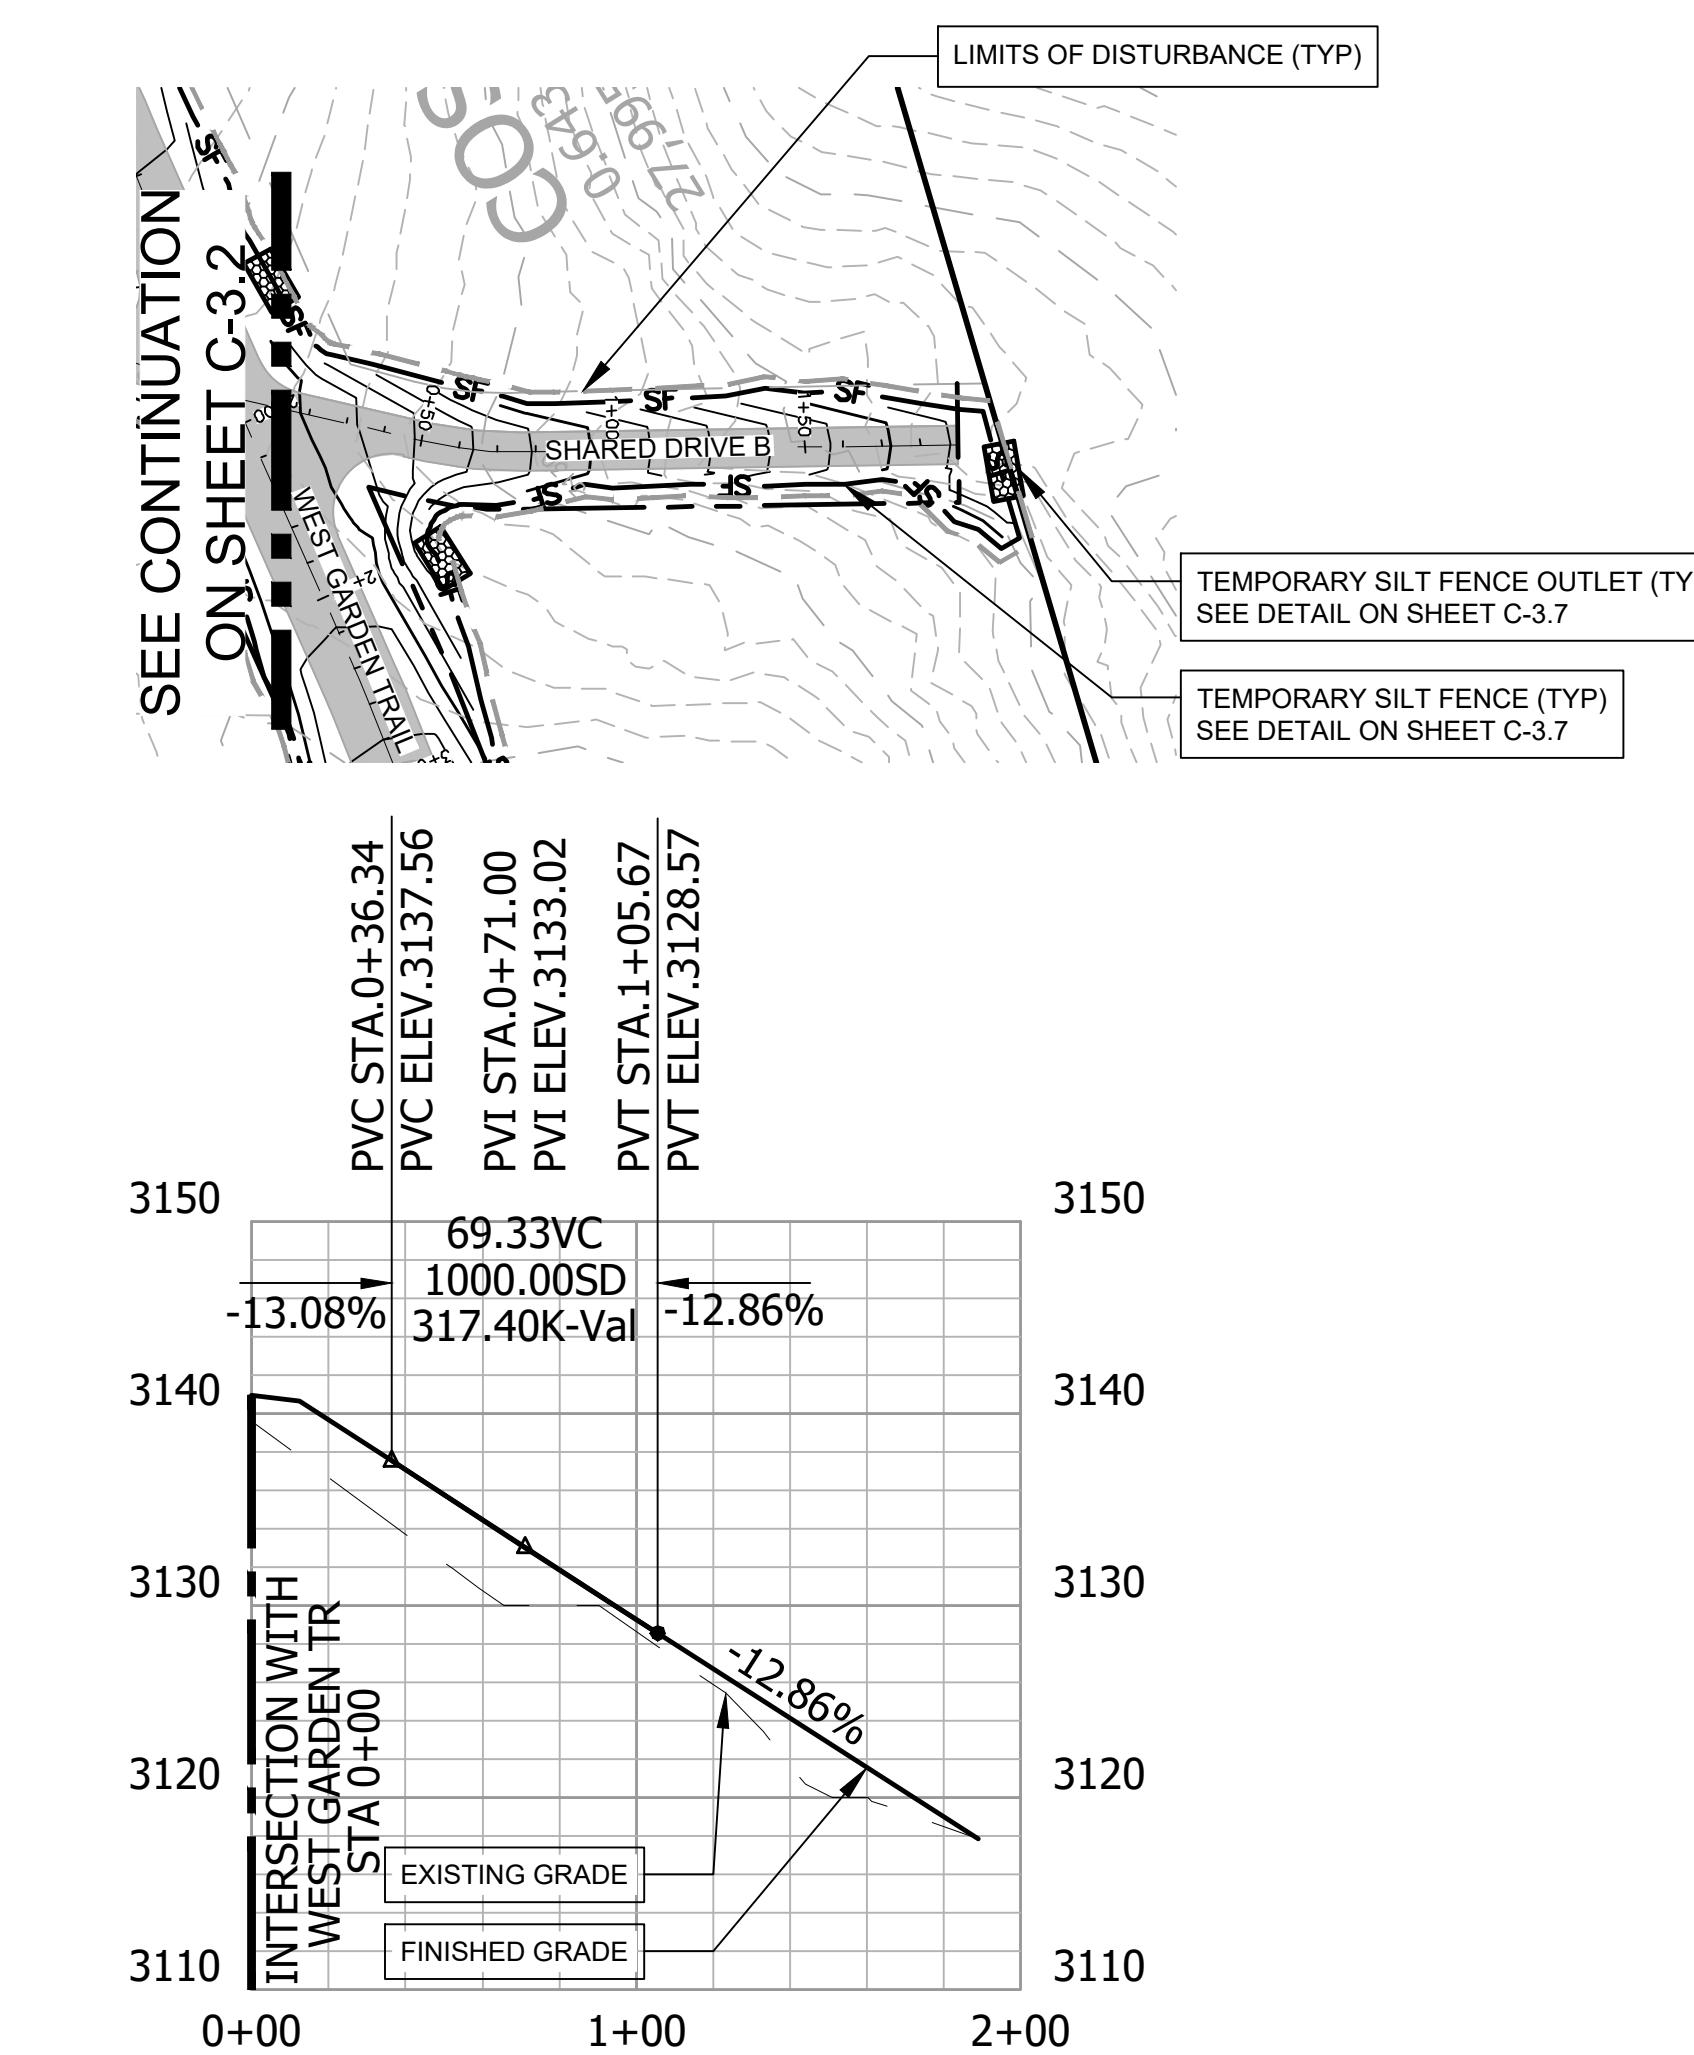
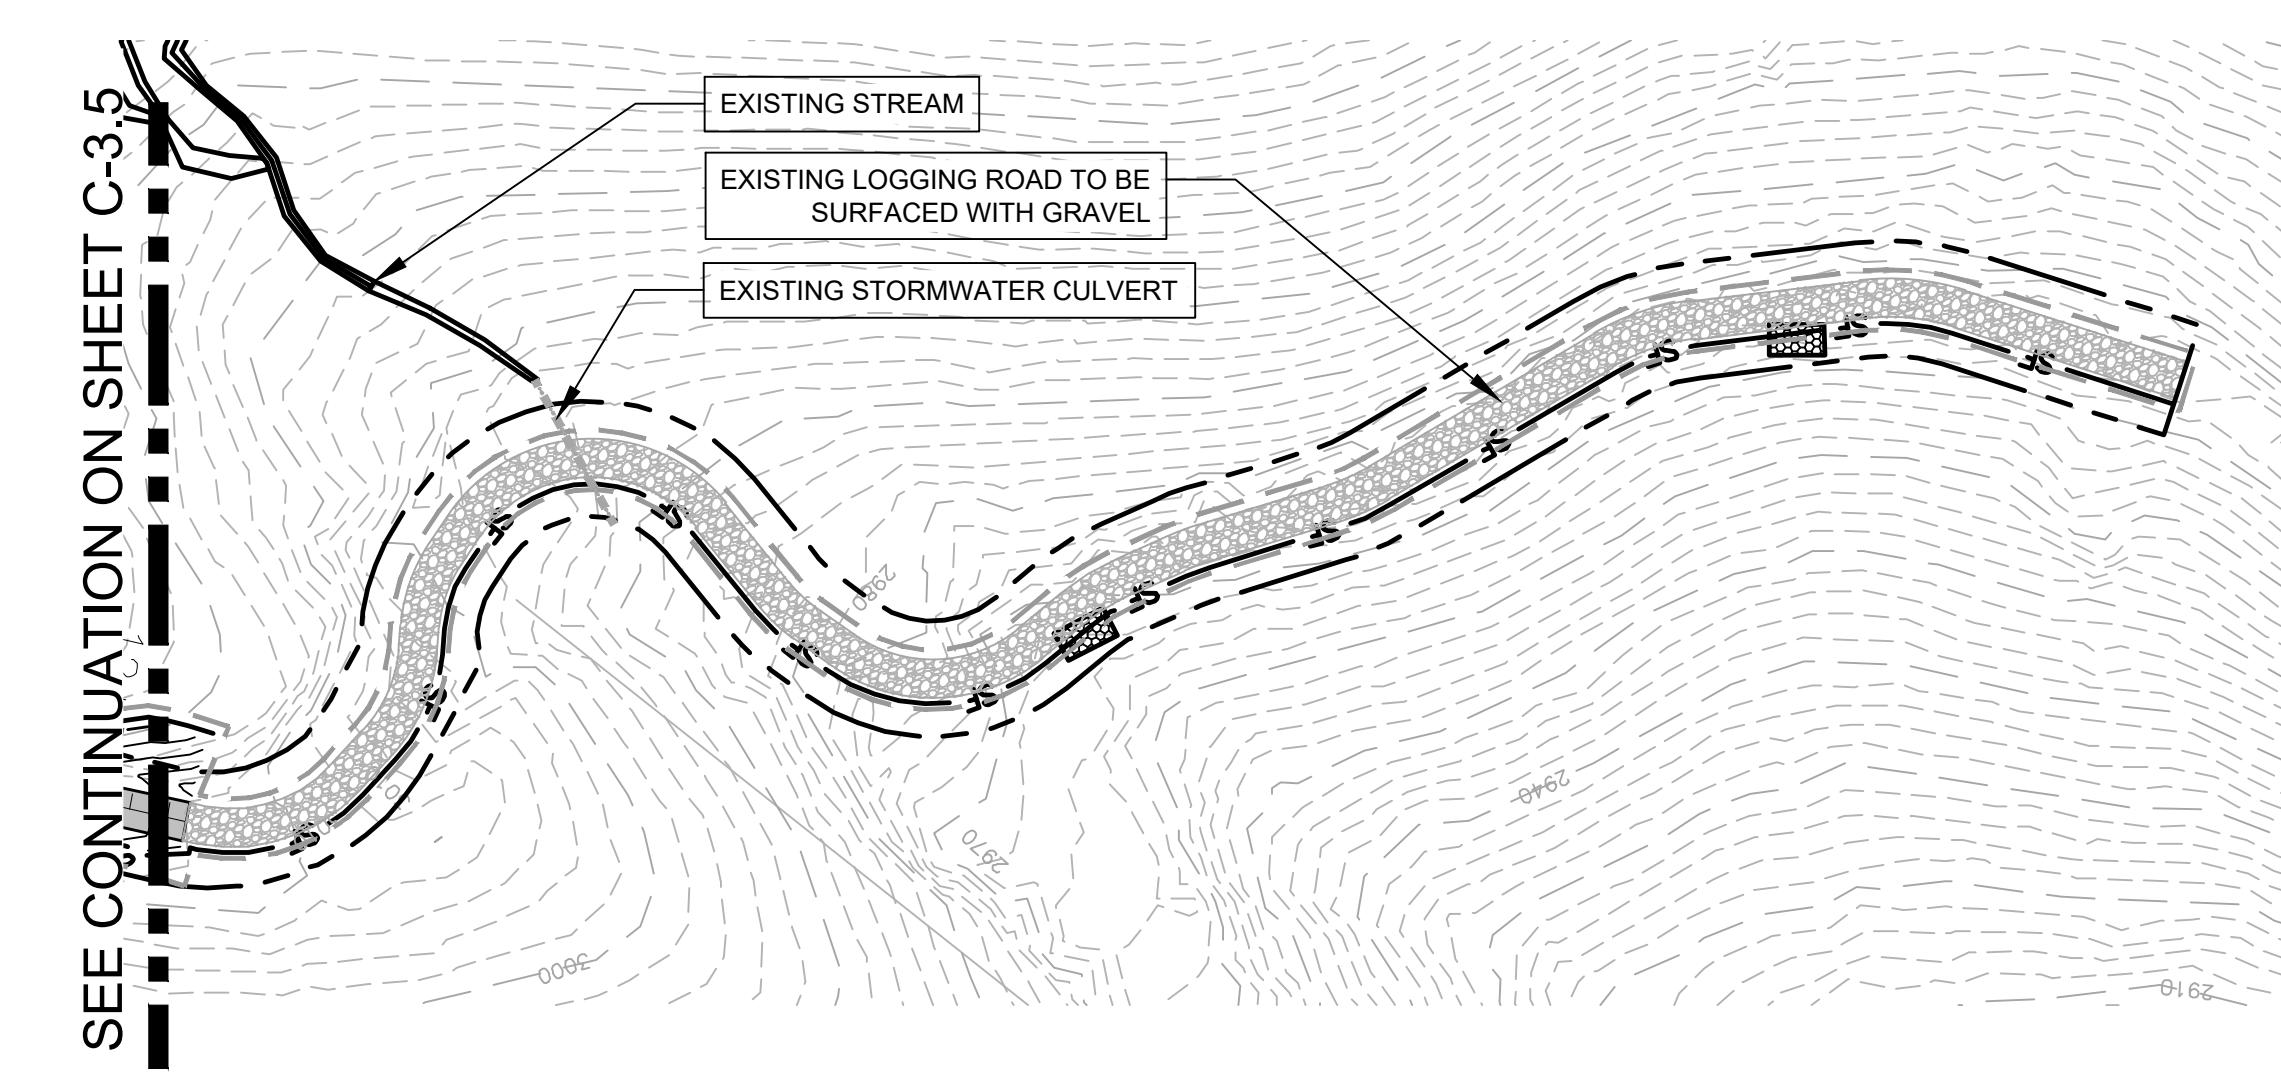
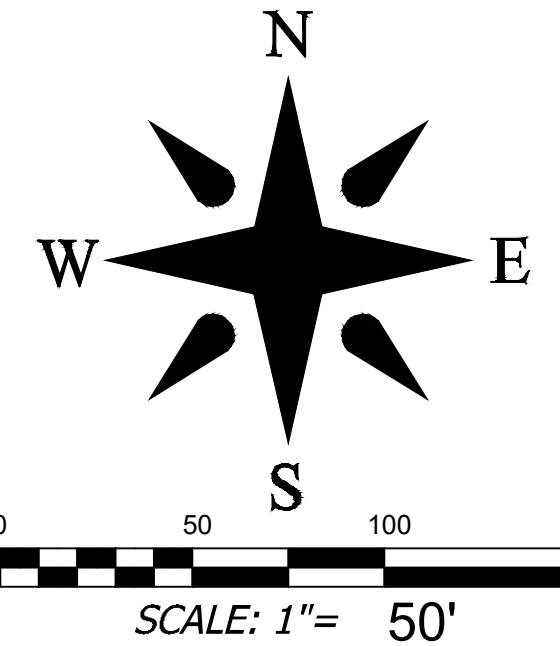


Project No: 543521	RICH MOUNTAIN PHASE 3 MAJOR SUBDIVISION HENDERSON COUNTY NORTH CAROLINA	Reviewed: JHK Drawn: ZAW Checked: JHK Date: 12-15-2022
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REVISIONS/SUBMISSIONS		
No. 1	HENDERSON COUNTY PLANNING	Date 12-15-2022
REVISION Submission number within a triangle indicates changes made on this sheet		
<p>FINAL DRAWING - FOR REVIEW PURPOSES ONLY</p>		

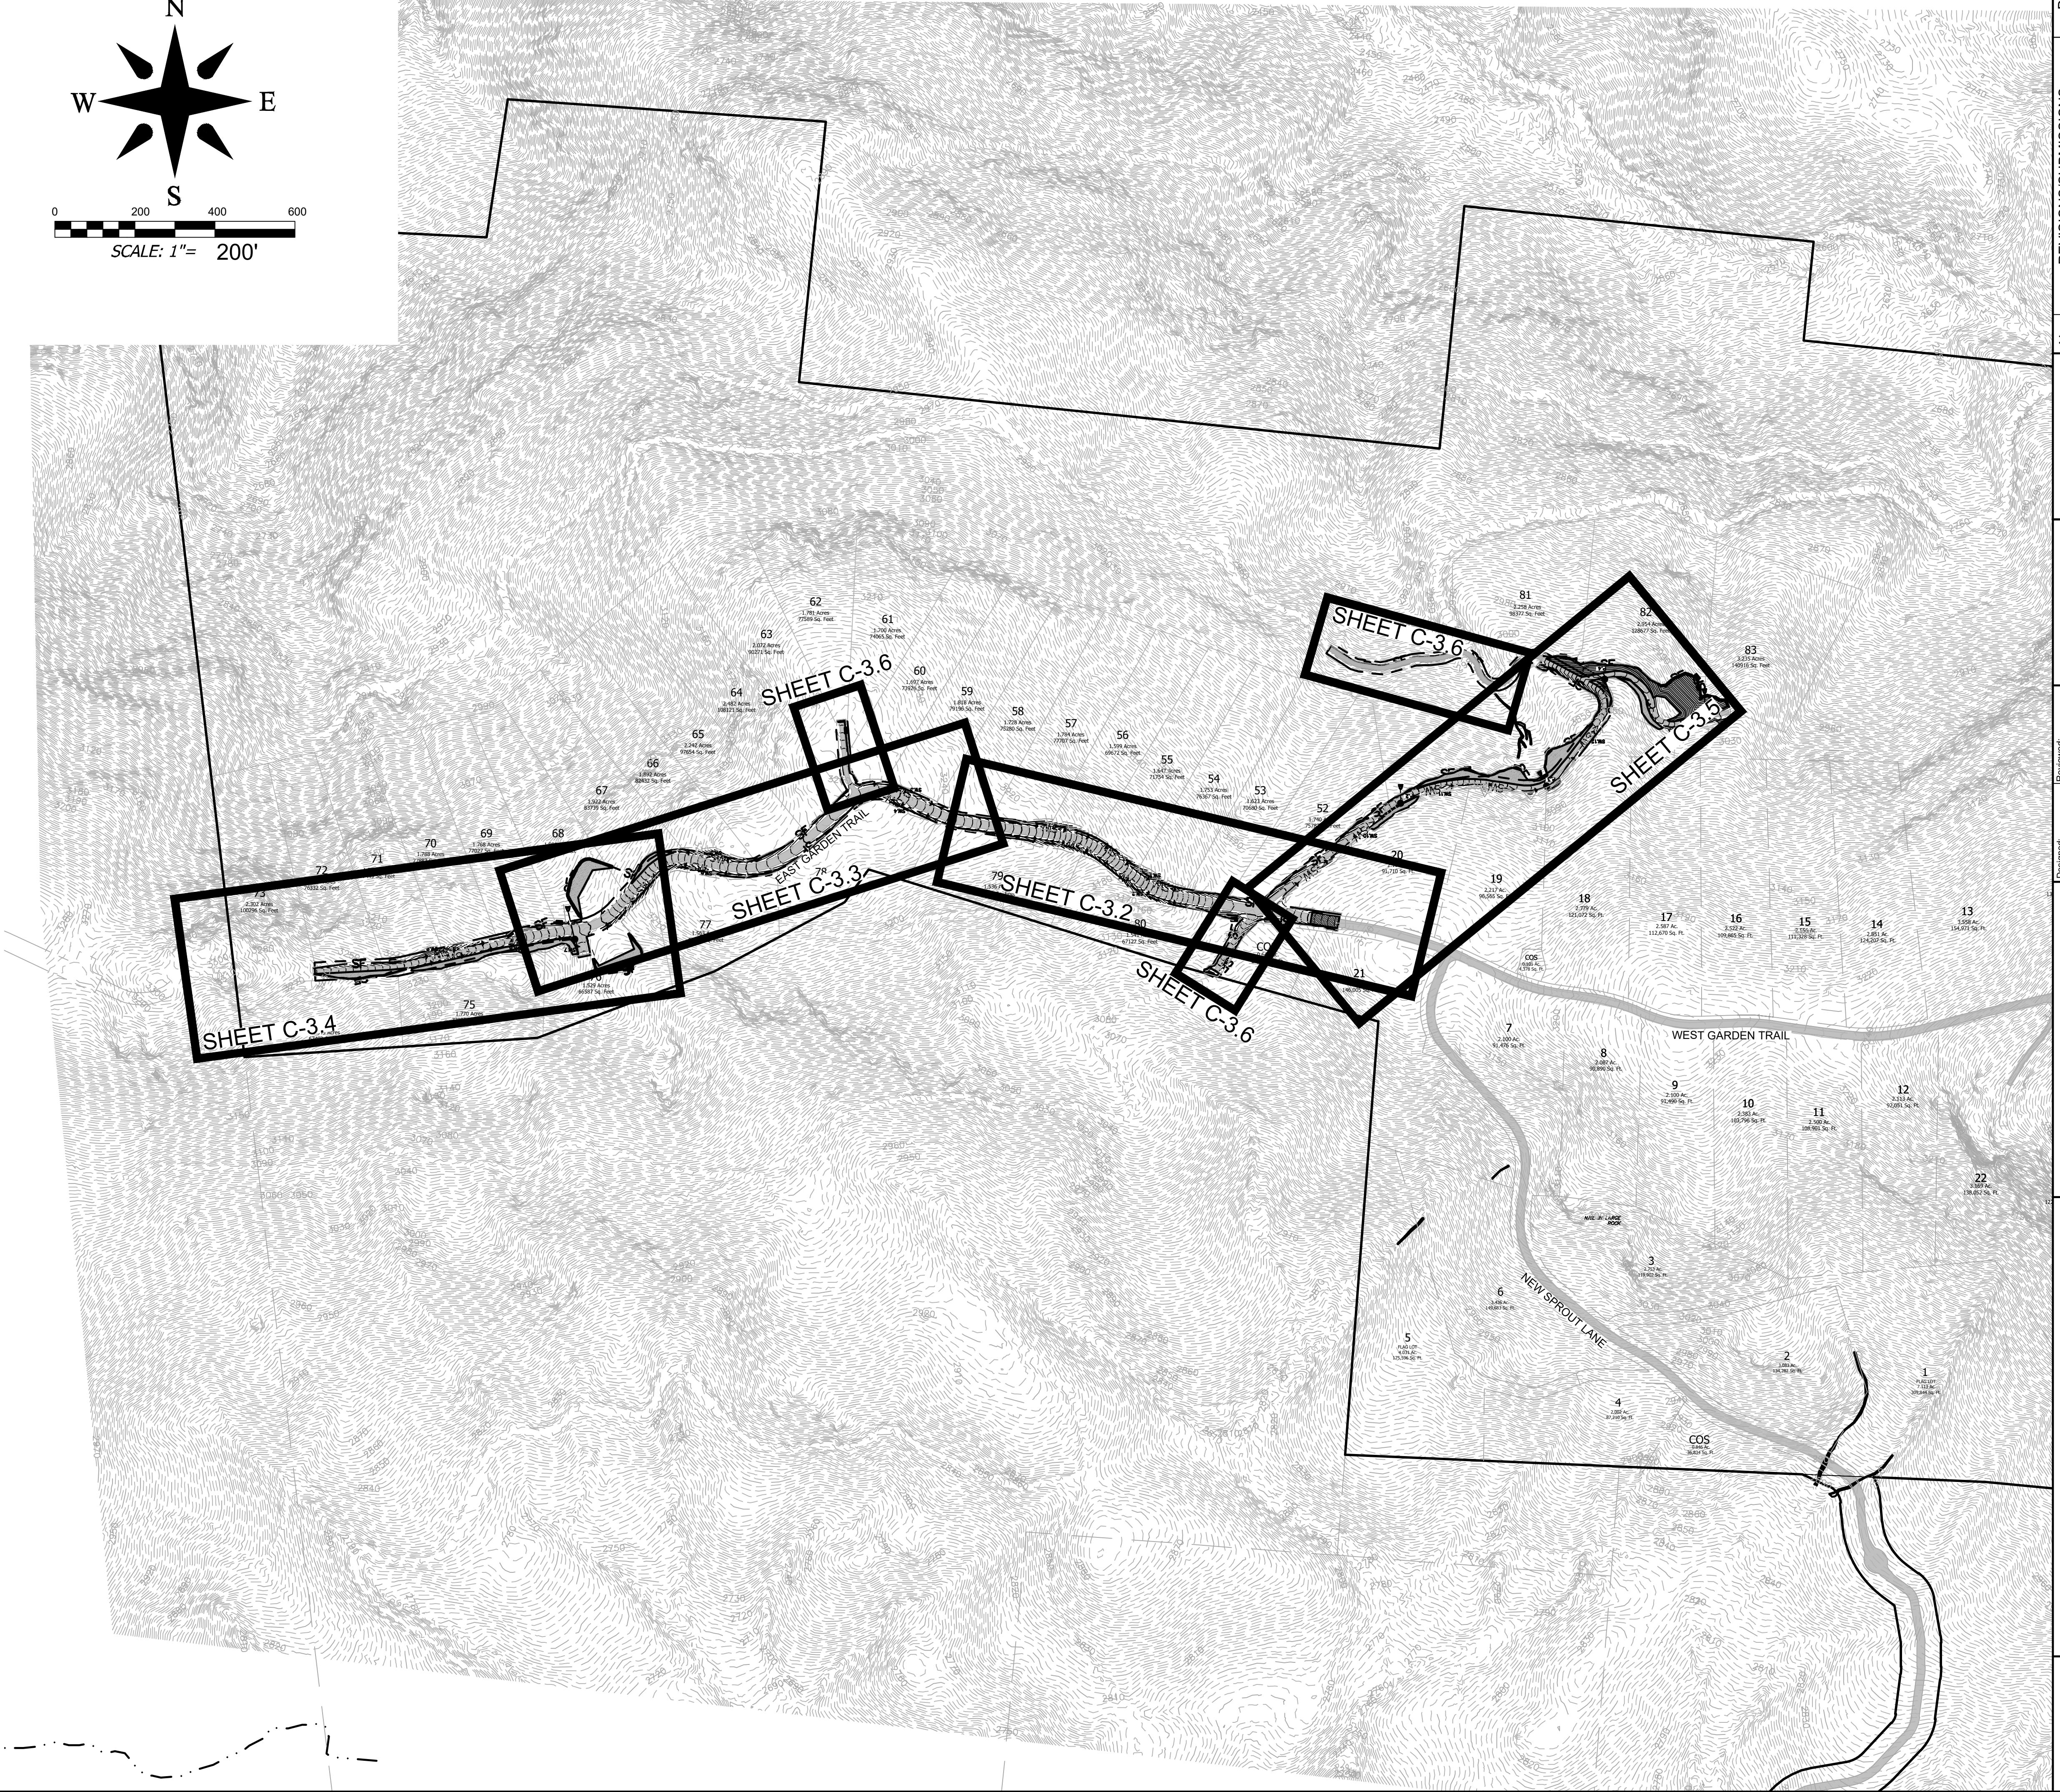






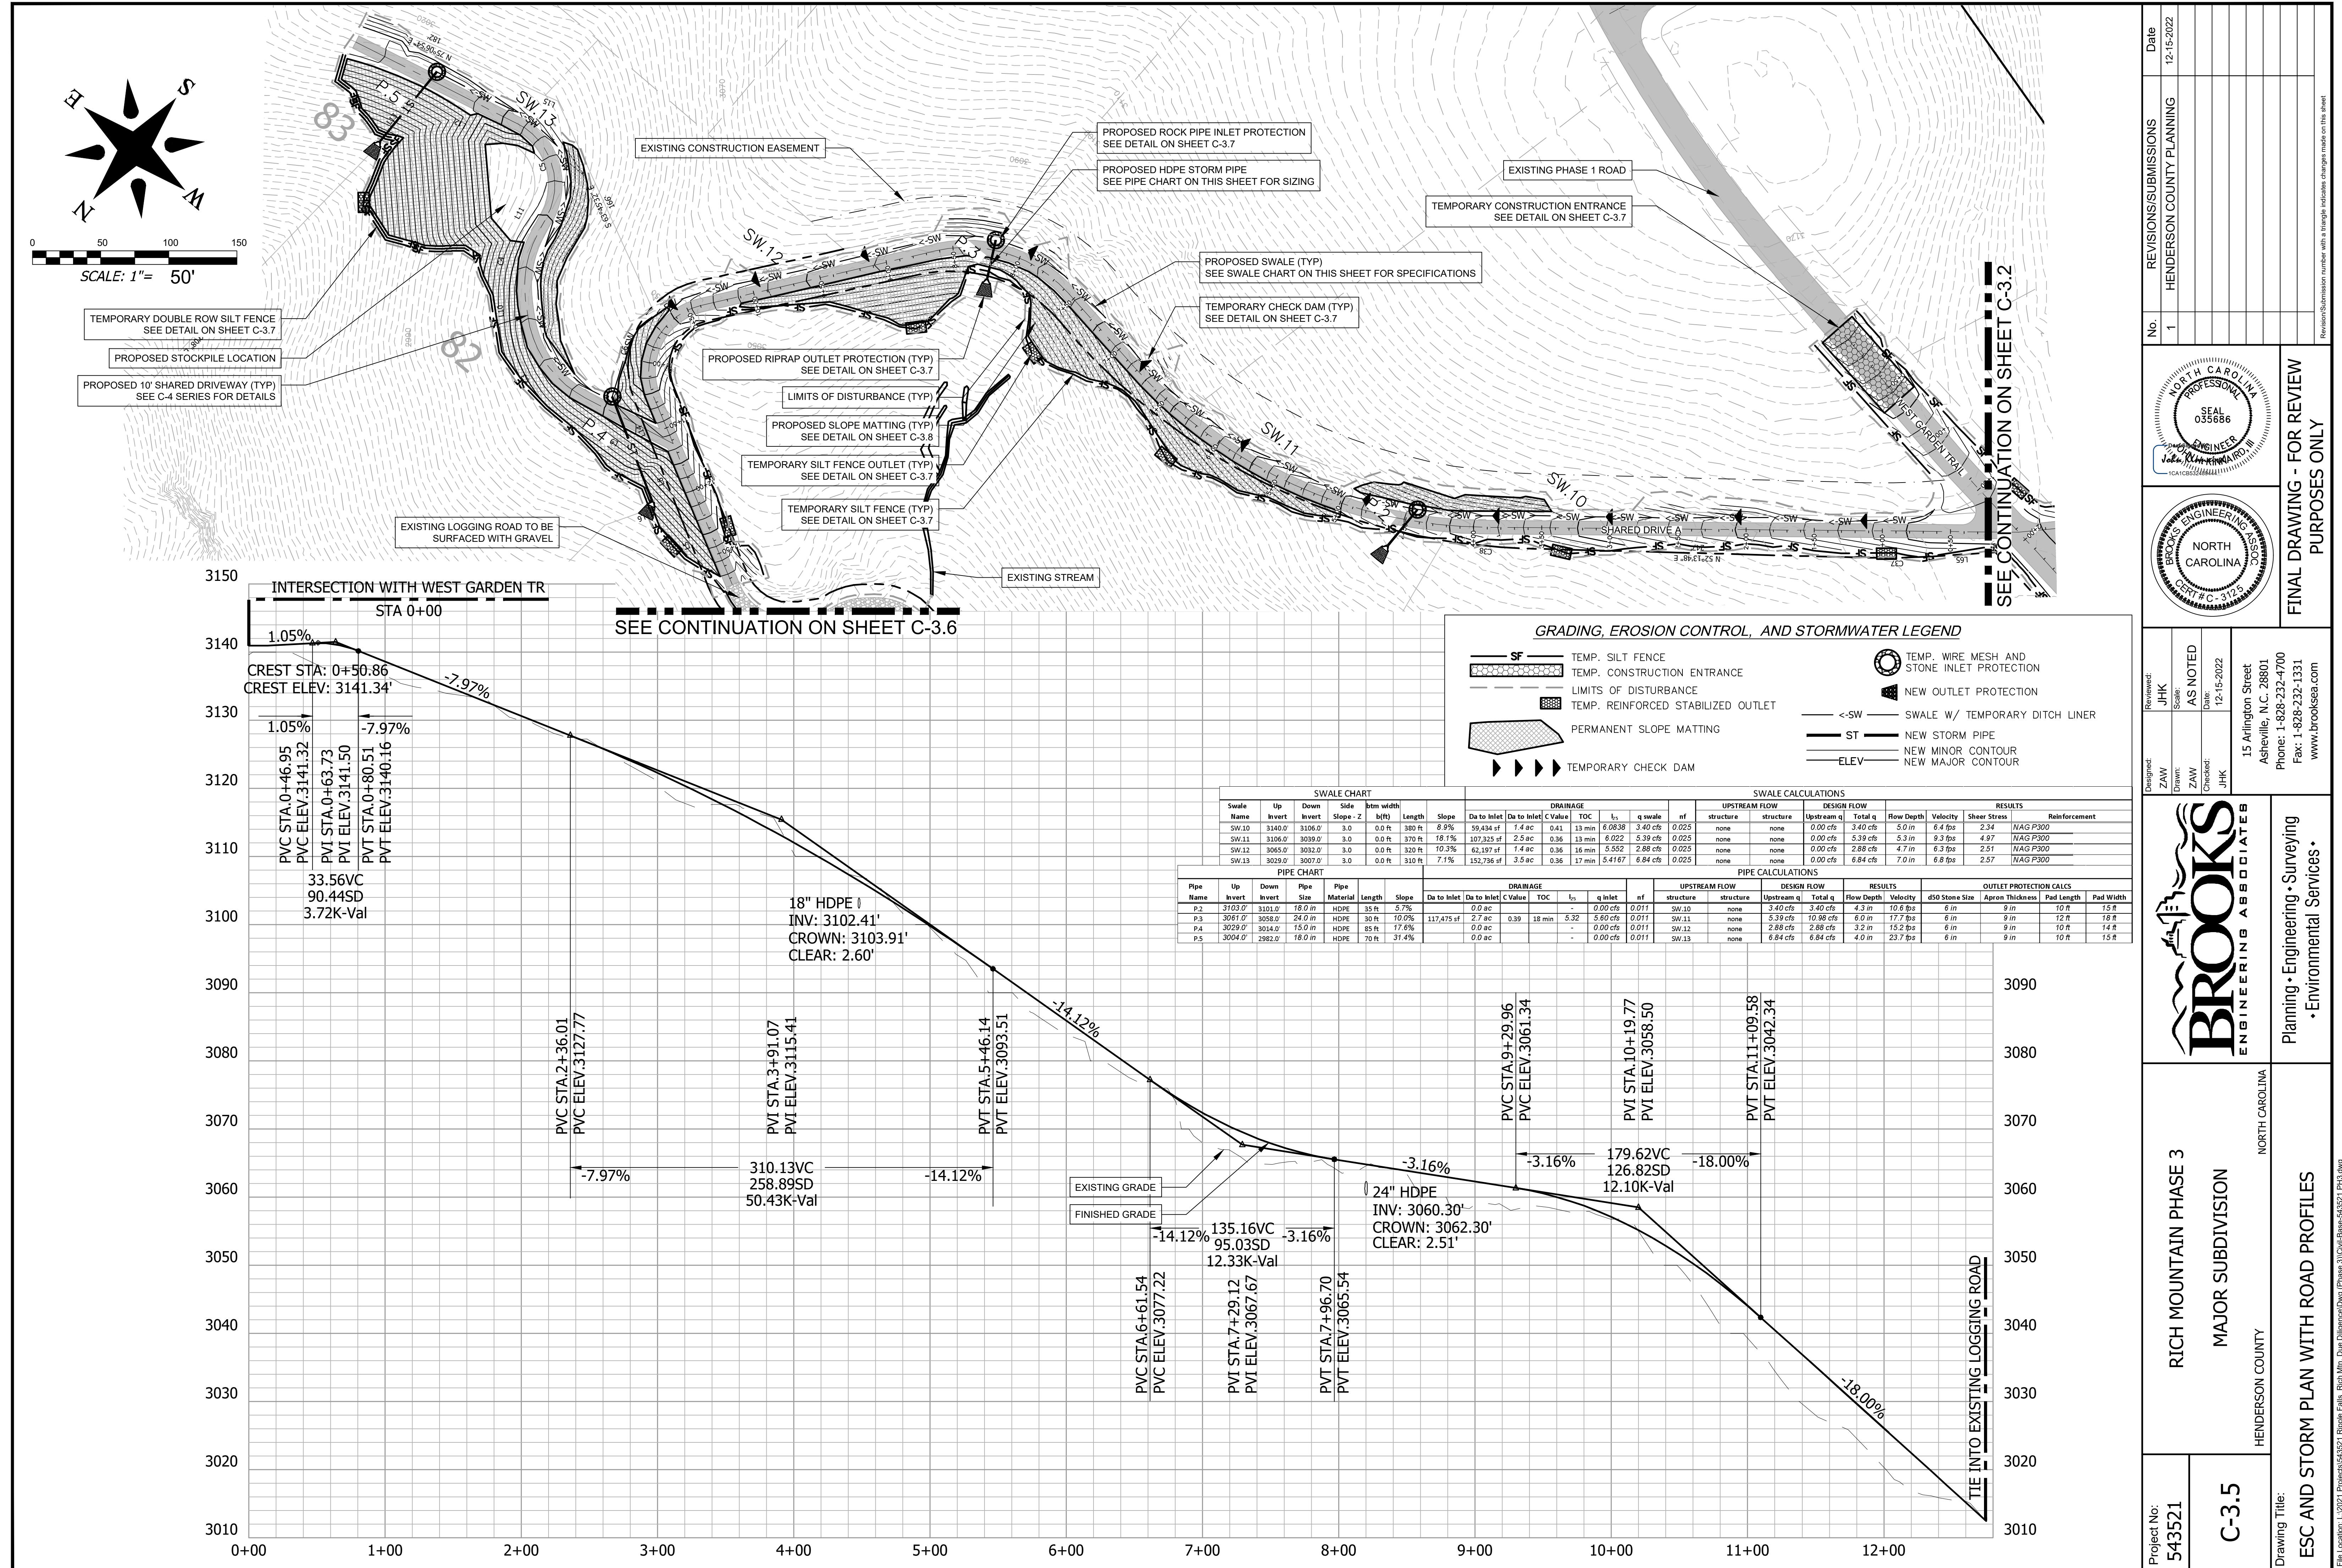

GRADING, EROSION CONTROL, AND STORMWATER LEGEND	
SF	TEMP. SILT FENCE
—	TEMP. CONSTRUCTION ENTRANCE
- - -	LIMITS OF DISTURBANCE
■ ■ ■	TEMP. REINFORCED STABILIZED OUTLET
△ △ △	PERMANENT SLOPE MATTING
► ► ►	TEMPORARY CHECK DAM
○ ○ ○	TEMP. WIRE MESH AND STONE INLET PROTECTION
▲ ▲ ▲	NEW OUTLET PROTECTION
— <-SW	SWALE W/ TEMPORARY DITCH LINER
— ST	NEW STORM PIPE
—	NEW MINOR CONTOUR
— ELEV	NEW MAJOR CONTOUR

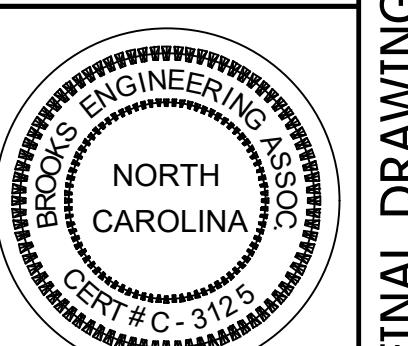Project No: 543521	RICH MOUNTAIN PHASE 3 MAJOR SUBDIVISION HENDERSON COUNTY NORTH CAROLINA	Reviewed: JHK Scale: AS NOTED Checked: JHK Date: 12-15-2022 Phone: 1-828-232-4700 Fax: 1-828-232-1331 www.brooksea.com	No. 1 REVISIONS/SUBMISSIONS HENDERSON COUNTY PLANNING Date 12-15-2022
C-3.6	<b>BROOKS</b> ENGINEERING ASSOCIATES Planning • Engineering • Surveying • Environmental Services •		No. 0 REVISIONS/SUBMISSIONS C-3.6 Date 12-15-2022
Drawing Title:  ESC AND STORM PLAN WITH ROAD PROFILES	FINAL DRAWING - FOR REVIEW PURPOSES ONLY		
 			
<small>Revision Submission number within a triangle indicates changes made on this sheet File Location: L:\2021 Projects\543521_Rapile Falls_Rich Mtn. Due Diligence\DWG\Phase 3\Civil\Assess-543521_PHA.dwg</small>			



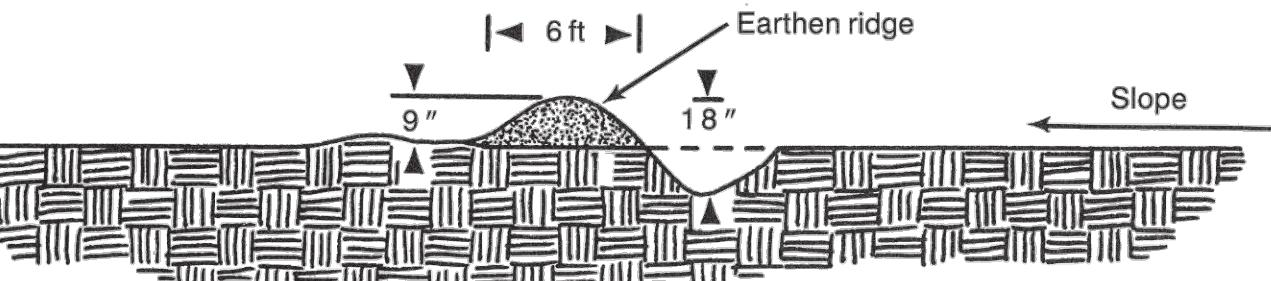
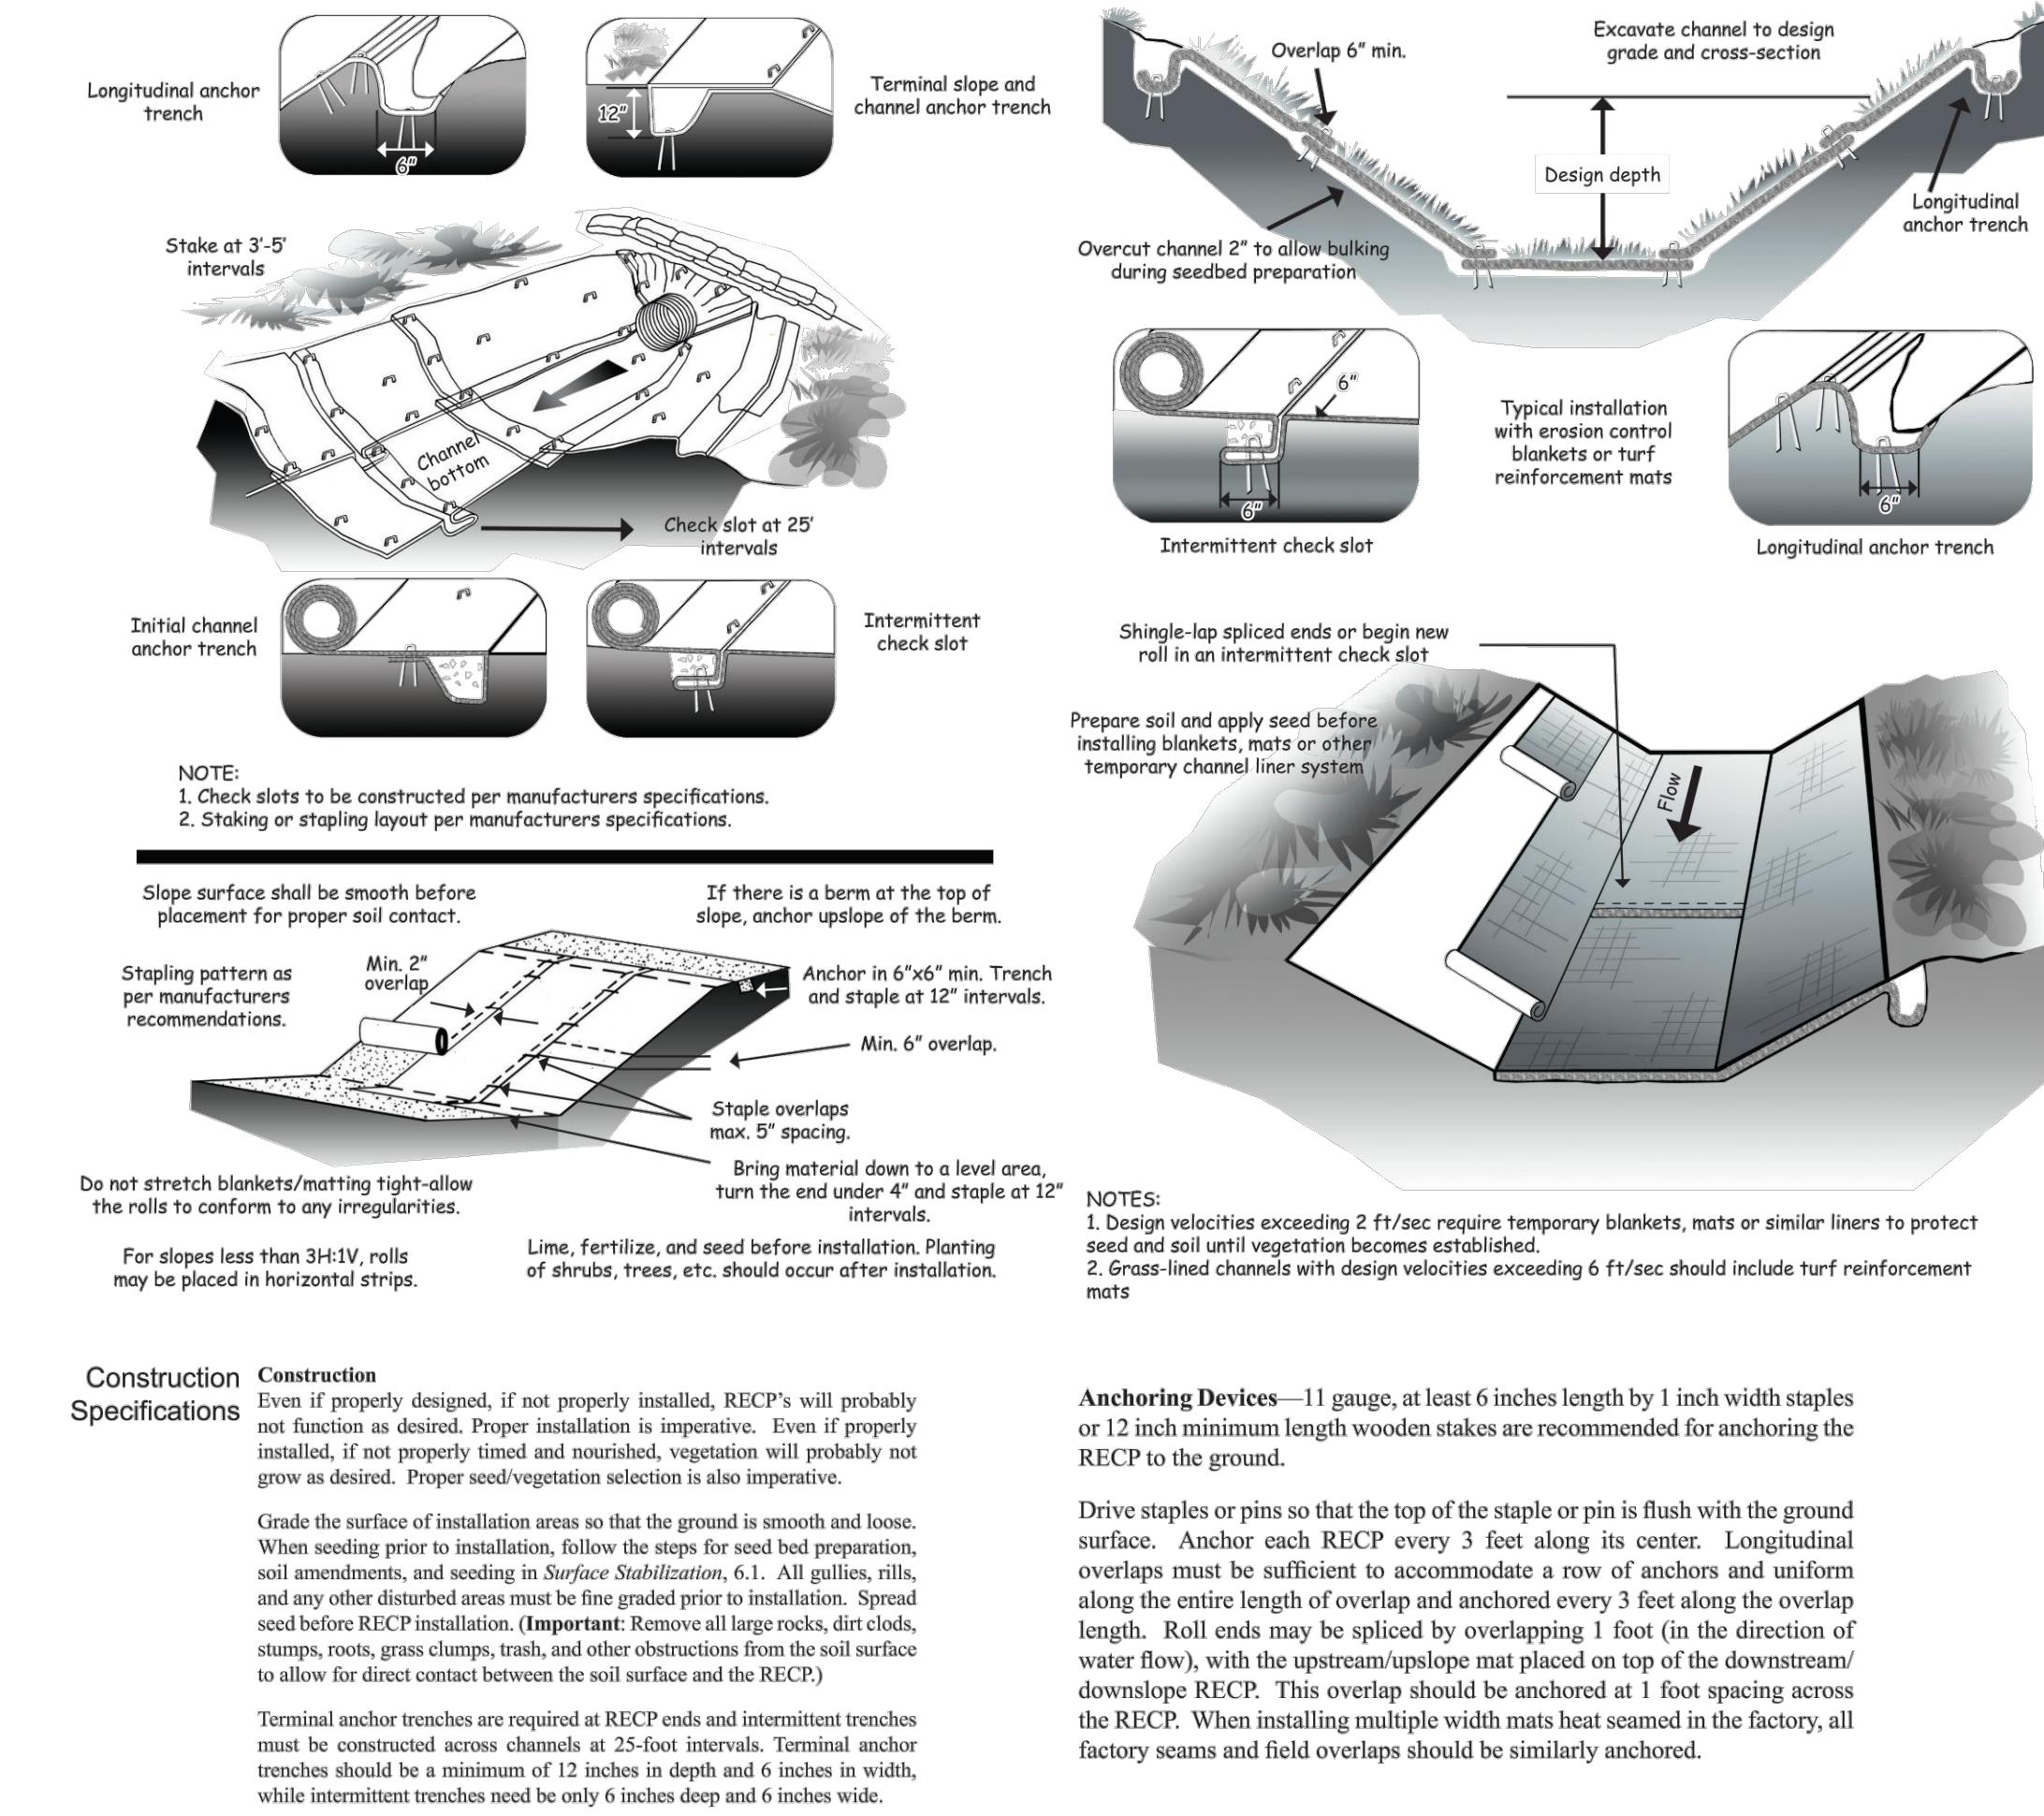
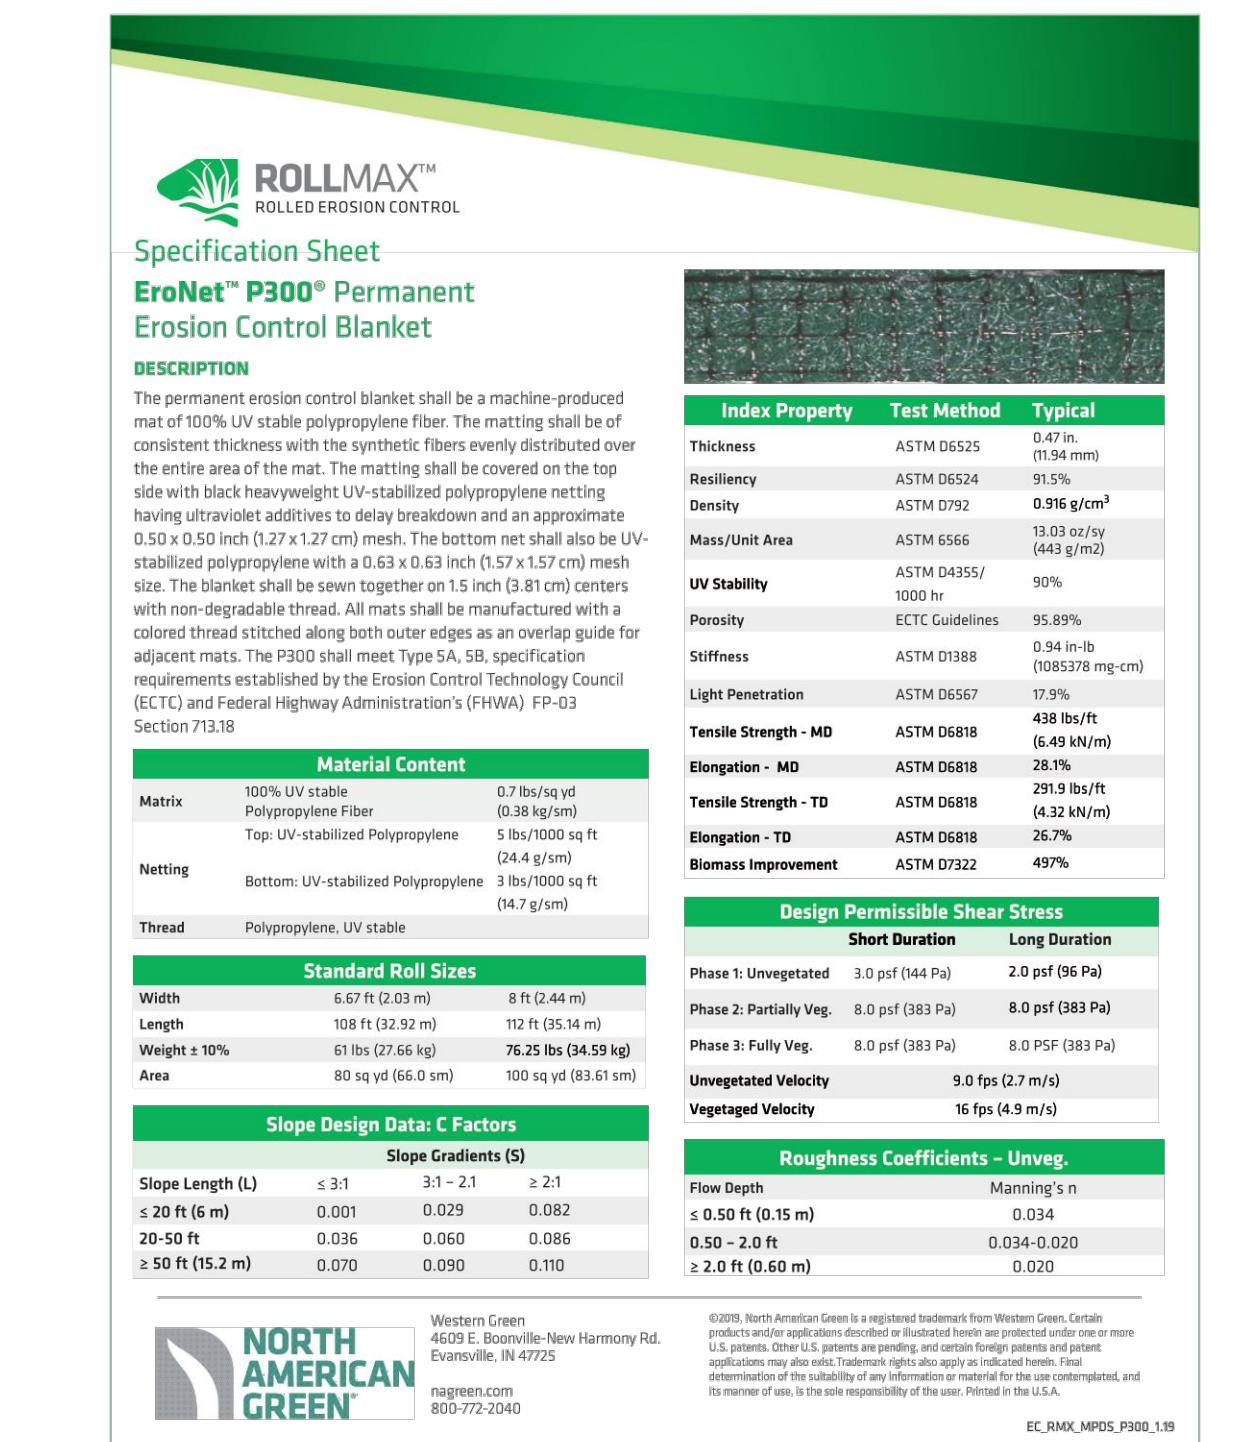


Figure 6.23b Section view of a water bar.

**Maintenance** Periodically inspect right-of-way diversions for wear and after every heavy rainfall for erosion damage. Immediately remove sediment from the flow area, and repair the dike. Check outlet areas, and make timely repairs as needed. When permanent road drainage is established and the area above the temporary right-of-way diversions is permanently stabilized, remove the dike, and fill the channel to blend with the natural ground, and appropriately stabilize the disturbed area.

**References** *Outlet Protection*  
6.40, Level Spreader  
6.41, Outlet Stabilization Structure

**Appendix**  
8.03, Estimating Runoff

**Design Criteria** **Height**—18-inch minimum measured from the channel bottom to the ridge top.

**Side slope**—2:1 or flatter

3:1 or flatter where vehicles cross

**Base width of ridge**—6 feet minimum (Figure 6.23b).



**Spacing of water bars** is shown in Table 6.23a:

Slope (%)	Spacing (Ft)
<5	125
5 to 10	100
10 to 20	75
20 to 35	50
>35	25

**Grade and angle**—A crossing angle should be selected to provide a positive grade not to exceed 2%.

**Outlet**—Diversions should have stable outlets, either natural or constructed. Site spacing may need to be adjusted for field conditions to use the most suitable areas for water disposal.



**Construction Specifications**  
1. Install the diversion as soon as the right-of-way has been cleared and graded.  
2. Disk the base for the constructed ridge before placing fill.

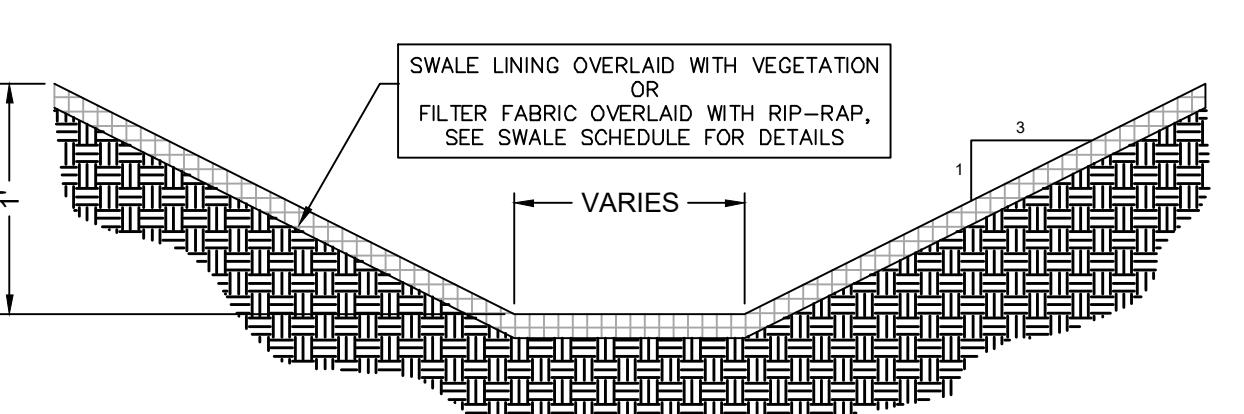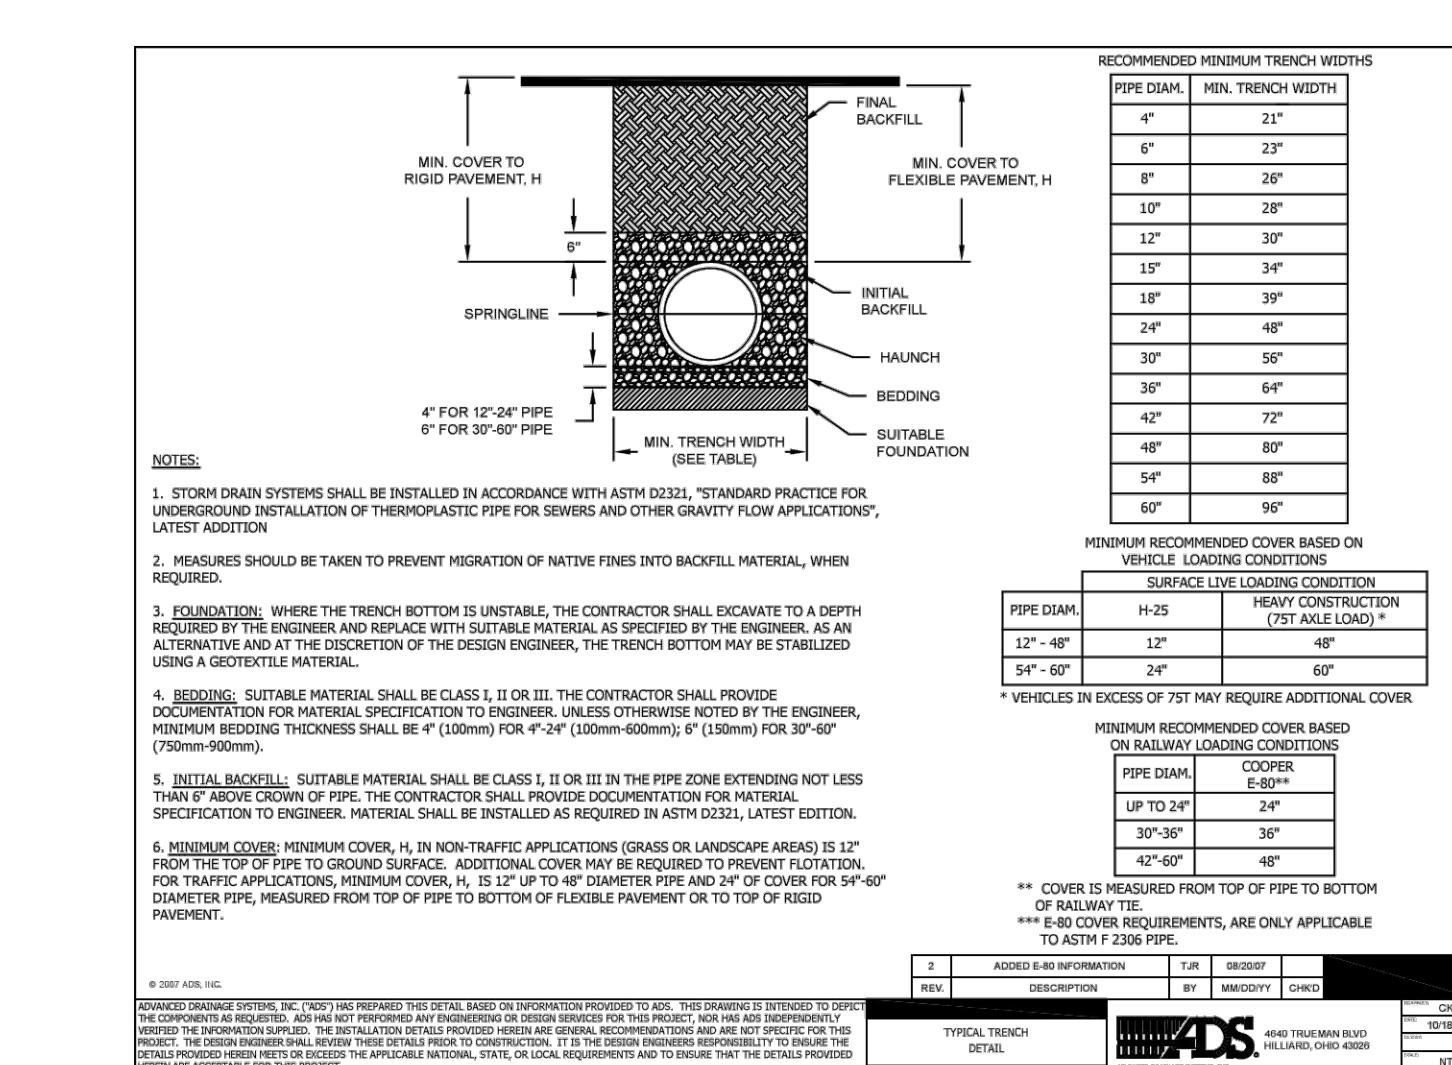

RICH MOUNTAIN PHASE 3  
MAJOR SUBDIVISION  
HENDERSON COUNTY  
NORTH CAROLINA

Project No:  
543521  
Drawing Title:  
EROSION CONTROL DETAILS  
File Location: L:\2021 Projects\543521\Ripple Falls\_Rich Min. Due Diligence\DWG\Phase 3\Chd-Detail\543521\_Ph3.dwg

No.	1	REVISIONS/SUBMISSIONS	Date	12-15-2022	
Revision/Submission number within a triangle indicates changes made on this sheet					
 <b>NORTH CAROLINA</b> <b>PROFESSIONAL ENGINEERS</b> <b>BOARD</b> <b>JOHN H. KENNEDY, III</b> <b>SEAL 035686</b> <b>NORTH CAROLINA</b> <b>CERTIFICATE</b> <b>CE-2022-C-3125</b>					
FINAL DRAWING - FOR REVIEW PURPOSES ONLY					
Reviewed:	JHK	Scale:	ZAW	Date:	AS-NOTED
Drawn:	JHK	Checked:	JHK	Date:	12-15-2022
Phone: 1-828-232-4700 Fax: 1-828-232-1331 www.brooksea.com					
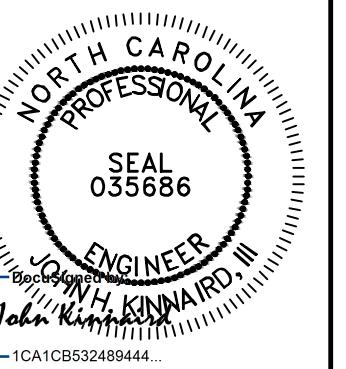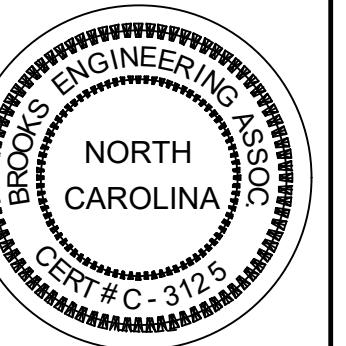
<p><b>CONSTRUCTION SEQUENCE</b></p> <ol style="list-style-type: none"> <li>1. HOLD A PRE-CONSTRUCTION MEETING PRIOR TO OBTAINING A LAND DISTURBING PERMIT FROM HENDERSON COUNTY. OBTAIN PERMIT.</li> <li>2. SURVEY AND DELINEATE THE LIMITS OF DISTURBANCE.</li> <li>3. CALL THE ENGINEER AT 828-232-4700 TO SCHEDULE PRE-CONSTRUCTION MEETING AT LEAST 48 HOURS PRIOR TO PROJECT ACTIVATION. INCLUDE HENDERSON COUNTY SITE DEVELOPMENT DEPARTMENT IN THE PRE-CONSTRUCTION MEETING INVITE.</li> <li>4. INSTALL RAIN GAUGE ON SITE.</li> <li>5. INSTALL PERMIT BOX (INSPECTION REPORTS AND PERMITS TO BE PLACED IN BOX).</li> <li>6. INSTALL CONSTRUCTION ENTRANCE / EXITS.</li> <li>7. INSTALL ALL PERIMETER DEVICES SUCH AS SILT FENCE AND SILT DITCHES.</li> <li>8. INSTALL ALL CONSTRUCTION FENCING AS REQUIRED BY OWNER.</li> <li>9. HAVE THE SITE INSPECTED BY THE ENGINEER AND HENDERSON COUNTY EROSION CONTROL PRIOR TO PROCEEDING WITH MASS GRADING.</li> <li>10. CONTINUE WITH CLEARING TO REMOVE ALL VEGETATION, INCLUDING ROOT MATS, FROM THE PROPOSED LIMITS OF DISTURBANCE.</li> <li>11. STOCKPILE TOPSOIL IN DESIGNATED AREA.</li> <li>12. TURN GRIND ALL VEGETATION AND STOCKPILE MATERIAL.</li> <li>13. DURING MASS GRADING, BEGIN TO INSTALL PERMANENT RUNOFF CONVEYANCE SYSTEMS SUCH AS STORM DRAINAGE, INLETS, DITCHES, AND PERMANENT DIVERSION.</li> <li>14. INSTALL REMAINING STORM DRAINAGE SYSTEM AND INLET AND OUTLET PROTECTION DEVICES SIMILARLY AS LISTED.</li> <li>15. INSTALL SLOPE MAPPING ON ALL CUT AND FILL SLOPES IN ACCORDANCE WITH PERMIT TIME REQUIREMENTS.</li> <li>16. MONITOR DUST DURING EARTH MOVING ACTIVITIES. IF DUST FORMS, WET SITE TO ELIMINATE LOSS OF DUST SEDIMENT.</li> <li>17. BRING ALL FILL AREAS TO FINAL GRADE. A GEOTECH MUST MONITOR ALL FILL BANKS AND MATERIAL FORMING THE ROAD BASE AND ALL CUT AND FILL SLOPES GREATER THAN 3:1.</li> <li>18. FINE GRADE ROADS.</li> <li>19. INSTALL STONE AND BINDER ON ROAD AREAS.</li> <li>20. PROVIDE PERMANENT VEGETATION FOR THE REMAINDER OF THE SITE.</li> <li>21. CONTACT EROSION CONTROL INSPECTOR AND REQUEST CLOSEOUT OF THE CONSTRUCTION ACTIVITIES PERMIT.</li> <li>22. REMOVE ALL SEDIMENT FENCE, COLLECTED SEDIMENT, INLET PROTECTION, ETC. AND DISPOSE IN PERMITTED CONSTRUCTION DEBRIS LANDFILL.</li> </ol>	<p><b>General Notes</b> All seeding to be in accordance with NCDEQ STD #6.11</p> <p>The kinds of seed and fertilizer, and the rates of application of seed, fertilizer and limestone, shall be as stated below. During periods of overlapping dates, the kind of seed to be used shall be determined. All rates are in pounds per acre.</p> <table border="1" style="width: 100%; border-collapse: collapse;"> <thead> <tr> <th colspan="4" style="text-align: center;">All Roadway Areas</th> </tr> </thead> <tbody> <tr> <td>March 1-August 31</td> <td>September 1-February 28</td> <td></td> <td></td> </tr> <tr> <td>50 lbs Tall Fescue</td> <td>50 lbs Tall Fescue</td> <td></td> <td></td> </tr> <tr> <td>10 lbs Centipede</td> <td>10 lbs Centipede</td> <td></td> <td></td> </tr> <tr> <td>25 lbs Bermudagrass (hulled)</td> <td>35 lbs Bermudagrass (hulled)</td> <td></td> <td></td> </tr> <tr> <td>500 lbs Fertilizer</td> <td>500 lbs Fertilizer</td> <td></td> <td></td> </tr> <tr> <td>4000 lbs Limestone</td> <td>4000 lbs Limestone</td> <td></td> <td></td> </tr> </tbody> </table> <table border="1" style="width: 100%; border-collapse: collapse;"> <thead> <tr> <th colspan="4" style="text-align: center;">Waste and Borrow Locations</th> </tr> </thead> <tbody> <tr> <td>March 1-August 31</td> <td>September 1-February 28</td> <td></td> <td></td> </tr> <tr> <td>75 lbs Tall Fescue</td> <td>75 lbs Tall Fescue</td> <td></td> <td></td> </tr> <tr> <td>25 lbs Bermudagrass (hulled)</td> <td>35 lbs Bermudagrass (hulled)</td> <td></td> <td></td> </tr> <tr> <td>500 lbs Fertilizer</td> <td>500 lbs Fertilizer</td> <td></td> <td></td> </tr> <tr> <td>4000 lbs Limestone</td> <td>4000 lbs Limestone</td> <td></td> <td></td> </tr> </tbody> </table> <p><b>Soil Prep</b> Preparation for primary/permanent stabilization shall not begin until construction and utility work within the preparation area is complete. However, it may be necessary to prepare for nurse crops prior to completion of construction and installation of utilities.</p> <p>All areas to be seeded or planted shall be tilled a depth of 12". Ripping consists of creating fissures in a criss-cross pattern over the entire surface area, utilizing an implement that will not glaze the side walls of the fissures. Site preparation that does not comply with these documents shall not be acceptable. The depth of soil preparation may be established as a range based on the approval of the reviewing state or local agency. Once tilled or ripped according to the approved plan, all areas are to be returned to the approved final grade. pH modifiers and/or other soil amendments can be added during the soil preparation procedure or as described below.</p> <p>Till or disc the prepared areas to be seeded to a minimum depth of four (4) inches. Remove stones larger than three (3) inches on any side slopes and remove any material that surface. If not incorporated during the soil preparation, add pH modifiers and fertilizers. Spread up to 6" of excess topsoil over the entire area if available. Re-compact the area utilizing a cultipacker roller. The finished grade shall be a smooth even soil surface with a loose, uniformly fine texture. All ridges and depressions shall be removed and filled to provide the approved surface drainage. Seeding of graded areas is to be done immediately after finished grades are obtained and seeded preparation is completed.</p> <p><b>Planting</b> Prepare the seed as described in above in soil preparation. Apply seed at rates specified on the plans, and/or as recommended above, with a cyclone seeder, prop type spreader, drill, or hydroseeder on and/or into the prepared bed. Incorporate the seed into the seed bed as specified. Provide finished grades as specified on the approved plan and carefully culti-pack the seedbed as terrain allows. Mulch immediately.</p>	All Roadway Areas				March 1-August 31	September 1-February 28			50 lbs Tall Fescue	50 lbs Tall Fescue			10 lbs Centipede	10 lbs Centipede			25 lbs Bermudagrass (hulled)	35 lbs Bermudagrass (hulled)			500 lbs Fertilizer	500 lbs Fertilizer			4000 lbs Limestone	4000 lbs Limestone			Waste and Borrow Locations				March 1-August 31	September 1-February 28			75 lbs Tall Fescue	75 lbs Tall Fescue			25 lbs Bermudagrass (hulled)	35 lbs Bermudagrass (hulled)			500 lbs Fertilizer	500 lbs Fertilizer			4000 lbs Limestone	4000 lbs Limestone			<p><b>TEMPORARY SEEDING</b></p> <p><b>General Notes</b> All seeding to be in accordance with NCDEQ STD #6.10</p> <table border="1" style="width: 100%; border-collapse: collapse;"> <thead> <tr> <th>Species</th> <th>Rate (lb/acre)</th> <th>Season</th> <th>Seeding Dates</th> </tr> </thead> <tbody> <tr> <td>Rye (grain)</td> <td>120</td> <td>Winter/Spring/Fall</td> <td>1/1-5/1, 8/15-12/30</td> </tr> <tr> <td>Annual lespedeza (Kobe)</td> <td>50</td> <td>Winter/Spring</td> <td>1/1-5/1</td> </tr> <tr> <td>German Millet</td> <td>40</td> <td>Summer</td> <td>5/1-8/15</td> </tr> </tbody> </table> <p>Omit annual lespedeza when duration of temporary cover is not to extend beyond June. A small-stemmed Sudangrass may be substituted for German millet at a rate of 50 lb/acre.</p> <p><b>Soil Amendments</b> Follow recommendations of soil tests or apply 2,000 lb/acre ground agricultural limestone and 750 lb/acre 10-10-10 fertilizer.</p> <p>For fall seeding, use 1000 lb/acre 10-10-10 fertilizer.</p> <p><b>Mulch</b> Apply 4,000 lb/acre straw. Anchor straw by tacking with asphalt, netting, or a mulch anchoring tool.</p> <p><b>Maintenance</b> Re-plant if growth is not fully adequate. Reseed, re-fertilize and mulch immediately following erosion or other damage.</p> <p>For fall, repair and re-fertilize damaged areas immediately. Topdress with 50 lb/acre of nitrogen in March. If it is necessary to extend temporary cover beyond June 15, overseed with 50 lb/acre Kobe lespedeza in late February or early March.</p>	Species	Rate (lb/acre)	Season	Seeding Dates	Rye (grain)	120	Winter/Spring/Fall	1/1-5/1, 8/15-12/30	Annual lespedeza (Kobe)	50	Winter/Spring	1/1-5/1	German Millet	40	Summer	5/1-8/15
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#### GROUND STABILIZATION AND MATERIALS HANDLING PRACTICES FOR COMPLIANCE WITH THE NCG01 CONSTRUCTION GENERAL PERMIT

Implementing the details and specifications on this plan sheet will result in the construction activity being considered compliant with the Ground Stabilization and Materials Handling sections of the NCG01 Construction General Permit (Sections E and F, respectively). The permittee shall comply with the Erosion and Sediment Control plan approved by the delegated authority having jurisdiction. All details and specifications shown on this sheet may not apply depending on site conditions and the delegated authority having jurisdiction.

#### SECTION E: GROUND STABILIZATION

##### Required Ground Stabilization Timeframes

Site Area Description	Stabilize within this many calendar days after ceasing land disturbance	Timeframe variations
(a) Perimeter dikes, swales, ditches, and perimeter slopes	7	None
(b) High Quality Water (HQW) Zones	7	None
(c) Slopes steeper than 3:1	7	If slopes are 10' or less in length and are not steeper than 2:1, 14 days are allowed
(d) Slopes 3:1 to 4:1	14	-7 days for slopes greater than 50' in length and with slopes steeper than 4:1 -7 days for perimeter dikes, swales, ditches, perimeter slopes and HQW Zones -10 days for Falls Lake Watershed
(e) Areas with slopes flatter than 4:1	14	-7 days for perimeter dikes, swales, ditches, perimeter slopes and HQW Zones -10 days for Falls Lake Watershed unless there is zero slope

**Note:** After the permanent cessation of construction activities, any areas with temporary ground stabilization shall be converted to permanent ground stabilization as soon as practicable but in no case longer than 90 calendar days after the last land disturbing activity. Temporary ground stabilization shall be maintained in a manner to render the surface stable against accelerated erosion until permanent ground stabilization is achieved.

#### GROUND STABILIZATION SPECIFICATION

Stabilize the ground sufficiently so that rain will not dislodge the soil. Use one of the techniques in the table below:


Temporary Stabilization	Permanent Stabilization
◦ Temporary grass seed covered with straw or other mulches and tackifiers	◦ Permanent grass seed covered with straw or other mulches and tackifiers
◦ Hydroseeding	◦ Geotextile fabrics such as permanent soil reinforcement matting
◦ Rolled erosion control products with or without temporary grass seed	◦ Hydroseeding
◦ Appropriately applied straw or other mulch	◦ Shrubs or other permanent plantings covered with mulch
◦ Plastic sheeting	◦ Uniform and evenly distributed ground cover sufficient to restrain erosion
	◦ Structural methods such as concrete, asphalt or retaining walls
	◦ Rolled erosion control products with grass seed

#### POLYACRYLAMIDES (PAMS) AND FLOCCULANTS

- Select flocculants that are appropriate for the soils being exposed during construction, selecting from the NC DWR List of Approved PAMS/Flocculants .
- Apply flocculants at or before the inlets to Erosion and Sediment Control Measures.
- Apply flocculants at the concentrations specified in the NC DWR List of Approved PAMS/Flocculants and in accordance with the manufacturer's instructions.
- Provide ponding area for containment of treated Stormwater before discharging offsite.
- Store flocculants in leak-proof containers that are kept under storm-resistant cover or surrounded by secondary containment structures.

#### EQUIPMENT AND VEHICLE MAINTENANCE

- Maintain vehicles and equipment to prevent discharge of fluids.
- Provide drip pans under any stored equipment.
- Identify leaks and repair as soon as feasible, or remove leaking equipment from the project.
- Collect all spent fluids, store in separate containers and properly dispose as hazardous waste (recycle when possible).
- Remove leaking vehicles and construction equipment from service until the problem has been corrected.
- Bring used fuels, lubricants, coolants, hydraulic fluids and other petroleum products to a recycling or disposal center that handles these materials.

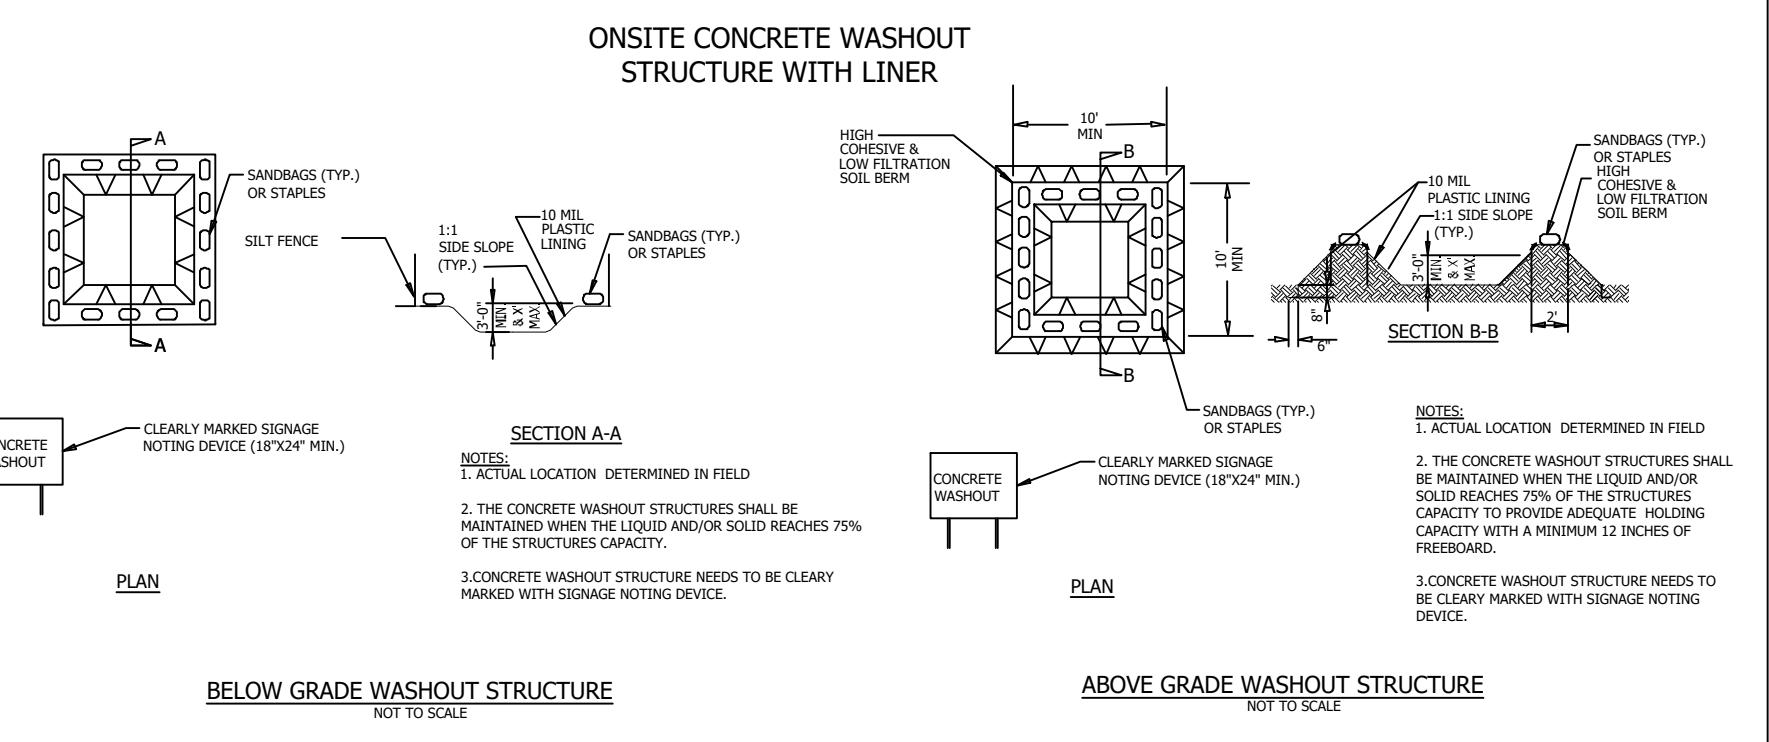

#### LITTER, BUILDING MATERIAL AND LAND CLEARING WASTE

- Never bury or burn waste. Place litter and debris in approved waste containers.
- Provide a sufficient number and size of waste containers (e.g. dumpster, trash receptacle) on site to contain construction and domestic wastes.
- Locate waste containers at least 50 feet away from storm drain inlets and surface waters unless no other alternatives are reasonably available.
- Locate waste containers on areas that do not receive substantial amounts of runoff from upland areas and does not drain directly to a storm drain, stream or wetland.
- Cover waste containers at the end of each workday and before storm events or provide secondary containment. Repair or replace damaged waste containers.
- Anchor all lightweight items in waste containers during times of high winds.
- Empty waste containers as needed to prevent overflow. Clean up immediately if containers overflow.
- Dispose waste off-site at an approved disposal facility.
- On business days, clean up and dispose of waste in designated waste containers.

#### PAINT AND OTHER LIQUID WASTE

- Do not dump paint and other liquid waste into storm drains, streams or wetlands.
- Locate paint washouts at least 50 feet away from storm drain inlets and surface waters unless no other alternatives are reasonably available.
- Contain liquid wastes in a controlled area.
- Containment must be labeled, sized and placed appropriately for the needs of site.
- Prevent the discharge of soaps, solvents, detergents and other liquid wastes from construction sites.

#### PORTABLE TOILETS

- Install portable toilets on level ground, at least 50 feet away from storm drains, streams or wetlands unless there is no alternative reasonably available. If 50 foot offset is not attainable, provide relocation of portable toilet behind silt fence or place on a gravel pad and surround with sand bags.
- Provide staking or anchoring of portable toilets during periods of high winds or in high foot traffic areas.
- Monitor portable toilets for leaking and properly dispose of any leaked material. Utilize a licensed sanitary waste hauler to remove leaking portable toilets and replace with properly operating unit.

#### EARTHEN STOCKPILE MANAGEMENT

- Show stockpile locations on plans. Locate earthen-material stockpile areas at least 50 feet away from storm drain inlets, sediment basins, perimeter sediment controls and surface waters unless it can be shown no other alternatives are reasonably available.
- Protect stockpile with silt fence installed along toe of slope with a minimum offset of five feet from the toe of stockpile.
- Provide stable stone access point when feasible.
- Stabilize stockpile within the timeframes provided on this sheet and in accordance with the approved plan and any additional requirements. Soil stabilization is defined as vegetative, physical or chemical coverage techniques that will restrain accelerated erosion on disturbed soils for temporary or permanent control needs.

#### CONCRETE WASHOUTS

- Do not discharge concrete or cement slurry from the site.
- Dispose of, or recycle settled, hardened concrete residue in accordance with local and state solid waste regulations and at an approved facility.
- Manage washout from mortar mixers in accordance with the above item and in addition place the mixer and associated materials on impervious barrier and within lot perimeter silt fence.
- Install temporary concrete washouts per local requirements, where applicable. If an alternate method or product is to be used, contact your approval authority for review and approval. If local standard details are not available, use one of the two types of temporary concrete washouts provided on this detail.
- Do not use concrete washouts for dewatering or storing defective curb or sidewalk sections. Stormwater accumulated within the washout may not be pumped into or discharged to the storm drain system or receiving surface waters. Liquid waste must be pumped out and removed from project.
- Locate washouts at least 50 feet from storm drain inlets and surface waters unless it can be shown that no other alternatives are reasonably available. At a minimum, install protection of storm drain inlet(s) closest to the washout which could receive spills or overflow.
- Locate washouts in an easily accessible area, on level ground and install a stone entrance pad in front of the washout. Additional controls may be required by the approving authority.
- Install at least one sign directing concrete trucks to the washout within the project limits. Post signage on the washout itself to identify this location.
- Remove leavings from the washout when at approximately 75% capacity to limit overflow events. Replace the tarp, sand bags or other temporary structural components when no longer functional. When utilizing alternative or proprietary products, follow manufacturer's instructions.
- At the completion of the concrete work, remove remaining leavings and dispose of in an approved disposal facility. Fill pit, if applicable, and stabilize any disturbance caused by removal of washout.

#### HERBICIDES, PESTICIDES AND RODENTICIDES



- Store and apply herbicides, pesticides and rodenticides in accordance with label restrictions.
- Store herbicides, pesticides and rodenticides in their original containers with the label, which lists directions for use, ingredients and first aid steps in case of accidental poisoning.
- Do not store herbicides, pesticides and rodenticides in areas where flooding is possible or where they may spill or leak into wells, stormwater drains, ground water or surface water. If a spill occurs, clean area immediately.
- Do not stockpile these materials onsite.

#### HAZARDOUS AND TOXIC WASTE

- Create designated hazardous waste collection areas on-site.
- Place hazardous waste containers under cover or in secondary containment.
- Do not store hazardous chemicals, drums or bagged materials directly on the ground.

NCG01 GROUND STABILIZATION AND MATERIALS HANDLING

EFFECTIVE: 04/01/19

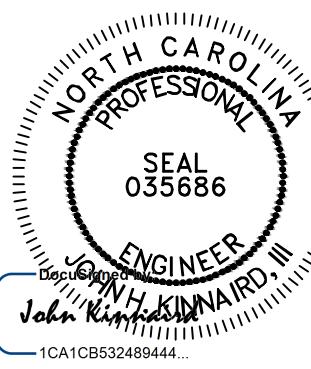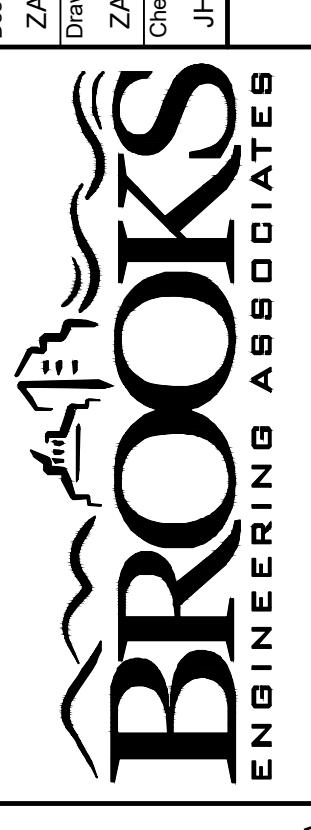Project No: 543521	Date: 12-15-2022
Revision/Submissions: 1 HENDERSON COUNTY PLANNING	No. 1
Revision Submission number within a triangle indicates changes made on this sheet	
 	
<b>FINAL DRAWING - FOR REVIEW PURPOSES ONLY</b>	
Planning • Engineering • Surveying • Environmental Services •	<b>RICH MOUNTAIN PHASE 3</b> <b>MAJOR SUBDIVISION</b> <b>HENDERSON COUNTY</b> <b>NORTH CAROLINA</b>  <b>C-3.10</b> Drawing Title: <b>NCG01 DETAILS</b> File Location: L:\2021 Projects\543521_Ripple Falls_Ren Min Due Diligence\DWG\Phase 3\Ch3-Detail\543521_Ph3.dwg File Location: L:\2021 Projects\543521_Ripple Falls_Ren Min Due Diligence\DWG\Phase 3\Ch3-Detail\543521_Ph3.dwg

<p><b>PART III</b> <b>SELF-INSPECTION, RECORDKEEPING AND REPORTING</b></p>																							
<p><b>SECTION A: SELF-INSPECTION</b></p> <p>Self-inspections are required during normal business hours in accordance with the table below. When adverse weather or site conditions would cause the safety of the inspection personnel to be in jeopardy, the inspection may be delayed until the next business day on which it is safe to perform the inspection. In addition, when a storm event of equal to or greater than 1.0 inch occurs outside of normal business hours, the self-inspection shall be performed upon the commencement of the next business day. Any time when inspections were delayed shall be noted in the Inspection Record.</p> <table border="1" style="width: 100%; border-collapse: collapse;"> <thead> <tr> <th style="text-align: left;">Inspect</th> <th style="text-align: left;">Frequency (during normal business hours)</th> <th style="text-align: left;">Inspection records must include:</th> </tr> </thead> <tbody> <tr> <td>(1) Rain gauge maintained in good working order</td> <td>Daily</td> <td>Daily rainfall amounts. If no daily rain gauge observations are made during weekend or holiday periods, and no individual-day rainfall information is available, record the cumulative rain measurement for those un(anc this will determine if a site inspection is needed). Days on which no rainfall occurred shall be recorded as "zero." The permittee may use another rain-monitoring device approved by the Division.</td> </tr> <tr> <td>(2) E&amp;SC Measures and within 24 hours of a rain event &gt; 1.0 inch in 24 hours</td> <td>At least once per 7 calendar days and within 24 hours of a rain event &gt; 1.0 inch in 24 hours</td> <td>1. Identification of the measures inspected, 2. Date and time of the inspection, 3. Name of the person performing the inspection, 4. Indication of whether the measures were operating properly, 5. Description of maintenance needs for the measure, 6. Description, evidence, and date of corrective actions taken.</td> </tr> <tr> <td>(3) Stormwater discharge outfalls (SDCs)</td> <td>At least once per 7 calendar days and within 24 hours of a rain event &gt; 1.0 inch in 24 hours</td> <td>1. Identification of the discharge outfalls inspected, 2. Date and time of the inspection, 3. Name of the person performing the inspection, 4. Evidence of indicators of stormwater pollution such as oil sheen, floating or suspended solids or discoloration, 5. Indication of visible sediment leaving the site, 6. Description, evidence, and date of corrective actions taken.</td> </tr> <tr> <td>(4) Perimeter of site</td> <td>At least once per 7 calendar days and within 24 hours of a rain event &gt; 1.0 inch in 24 hours</td> <td>If visible sedimentation is found outside site limits, then a record of the following shall be made: 1. Actions taken to clean up or stabilize the sediment that has left the site limits, 2. Description, evidence, and date of corrective actions taken, and 3. An explanation as to the actions taken to control future</td> </tr> <tr> <td>(5) Streams or wetlands onsite or offsite (where accessible)</td> <td>At least once per 7 calendar days and within 24 hours of a rain event &gt; 1.0 inch in 24 hours</td> <td>If the stream or wetland has increased visible sedimentation or a stream has visible increased turbidity from the construction activity, then a record of the following shall be made: 1. Description, evidence and date of corrective actions taken, and 2. Records of the required reports to the appropriate Division</td> </tr> <tr> <td>(6) Ground stabilization measures</td> <td>After each phase of grading</td> <td>Regional Office per Part III, Section C, Item (2)(a) of this permit. 1. The phase of grading (installation of perimeter E&amp;SC measures, clearing and grubbing, installation of storm drainage facilities, completion of all land-disturbing activity, construction or redevelopment, permanent ground cover). 2. Documentation that the required ground stabilization measures have been provided within the required timeframe or an assurance that they will be provided as soon as possible.</td> </tr> </tbody> </table> <p>NOTE: The rain inspection resets the required 7 calendar day inspection requirement.</p>			Inspect	Frequency (during normal business hours)	Inspection records must include:	(1) Rain gauge maintained in good working order	Daily	Daily rainfall amounts. If no daily rain gauge observations are made during weekend or holiday periods, and no individual-day rainfall information is available, record the cumulative rain measurement for those un(anc this will determine if a site inspection is needed). Days on which no rainfall occurred shall be recorded as "zero." The permittee may use another rain-monitoring device approved by the Division.	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<p><b>SECTION B: RECORDKEEPING</b></p> <p><b>1. E&amp;SC Plan Documentation</b></p> <p>The approved E&amp;SC plan as well as any approved deviation shall be kept on the site. The approved E&amp;SC plan must be kept up-to-date throughout the coverage under this permit. The following items pertaining to the E&amp;SC plan shall be kept on site and available for inspection at all times during normal business hours.</p> <table border="1" style="width: 100%; border-collapse: collapse;"> <thead> <tr> <th style="text-align: left;">Item to Document</th> <th style="text-align: left;">Documentation Requirements</th> </tr> </thead> <tbody> <tr> <td>(a) Each E&amp;SC measure has been installed and does not significantly deviate from the locations, dimensions and relative elevations shown on the approved E&amp;SC plan. This documentation is required upon the initial installation of the E&amp;SC measures or if the E&amp;SC measures are modified after initial installation.</td> <td>Initial and date each E&amp;SC measure on a copy of the approved E&amp;SC plan or complete, date and sign an inspection report that lists each E&amp;SC measure shown on the approved E&amp;SC plan. This documentation is required upon the initial installation of the E&amp;SC measures or if the E&amp;SC measures are modified after initial installation.</td> </tr> <tr> <td>(b) A phase of grading has been completed. 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Additional Documentation to be Kept on Site</b></p> <p>In addition to the E&amp;SC plan documents above, the following items shall be kept on the site and available for inspectors at all times during normal business hours, unless the Division provides a site-specific exemption based on unique site conditions that make this requirement not practical:</p> <ul style="list-style-type: none"> <li>(a) This General Permit as well as the Certificate of Coverage, after it is received.</li> <li>(b) Records of inspections made during the previous twelve months. The permittee shall record the required observations on the Inspection Record Form provided by the Division or a similar inspection form that includes all the required elements. Use of electronically-available records in lieu of the required paper copies will be allowed if shown to provide equal access and utility as the hard-copy records.</li> </ul> <p><b>3. Documentation to be Retained for Three Years</b></p> <p>All data used to complete the e-NOI and all inspection records shall be maintained for a period of three years after project completion and made available upon request [40 CFR 122.41]</p>			Item to Document	Documentation Requirements	(a) Each E&SC measure has been installed and does not significantly deviate from the locations, dimensions and relative elevations shown on the approved E&SC plan. This documentation is required upon the initial installation of the E&SC measures or if the E&SC measures are modified after initial installation.	Initial and date each E&SC measure on a copy of the approved E&SC plan or complete, date and sign an inspection report that lists each E&SC measure shown on the approved E&SC plan. This documentation is required upon the initial installation of the E&SC measures or if the E&SC measures are modified after initial installation.	(b) A phase of grading has been completed. 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**PART II, SECTION G, ITEM (4)**  
**DRAW DOWN OF SEDIMENT BASINS FOR MAINTENANCE OR CLOSE OUT**



Sediment basins and traps that receive runoff from drainage areas of one acre or more shall use outlet structures that withdraw water from the surface when these devices need to be drawn down for maintenance or close out unless this is infeasible. The circumstances in which it is not feasible to withdraw water from the surface shall be rare (for example, times with extended cold weather). Non-surface withdrawals from sediment basins shall be allowed only when all of the following criteria have been met:

- (a) The E&SC plan authority has been provided with documentation of the non-surface withdrawal and the specific time periods or conditions in which it will occur. The non-surface withdrawal shall not commence until the E&SC plan authority has approved these items,
- (b) The non-surface withdrawal has been reported as an anticipated bypass in accordance with Part III, Section C, Item (2)(c) and (d) of this permit,
- (c) Dewatering discharges are treated with controls to minimize discharges of pollutants from stormwater that is removed from the sediment basin. Examples of appropriate controls include properly sited, designed and maintained dewatering tanks, weir tanks, and filtration systems,
- (d) Vegetated, upland areas of the sites or a properly designed stone pad is used to the extent feasible at the outlet of the dewatering treatment devices described in Item (c) above,
- (e) Velocity dissipation devices such as check dams, sediment traps, and riprap are provided at the discharge points of all dewatering devices, and
- (f) Sediment removed from the dewatering treatment devices described in Item (c) above is disposed of in a manner that does not cause deposition of sediment into waters of the United States.

**NCG01 SELF-INSPECTION, RECORDKEEPING AND REPORTING**


**EFFECTIVE: 04/01/19**

<p>Project No: 543521</p> <p>Drawing Title: C-3.11</p>	<p>Date 12-15-2022</p>	<p>No. 1</p> <p>REVISIONS/SUBMISSIONS HENDERSON COUNTY PLANNING</p>	<p>Revision Submission number within a triangle indicates changes made on this sheet</p>
  <p><b>FINAL DRAWING - FOR REVIEW PURPOSES ONLY</b></p>			
<p><b>BROOKS</b> ENGINEERING ASSOCIATES</p> <p>Planning • Engineering • Surveying • Environmental Services •</p> <p>RICH MOUNTAIN PHASE 3 MAJOR SUBDIVISION NORTH CAROLINA HENDERSON COUNTY NORTH CAROLINA Environmental Quality</p>			
<p>File Location: L:\2021 Projects\543521_Ripple Falls_Ren Min Due Diligence\Drawg Phase 3\Chd-Detail543521_Pt3.dwg</p>			

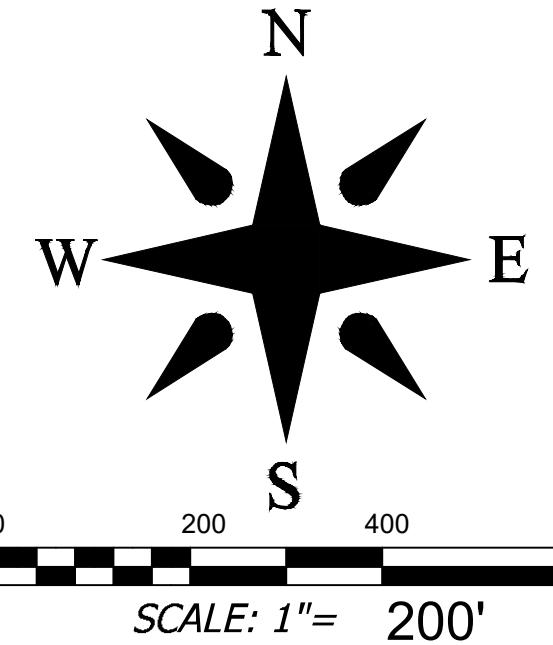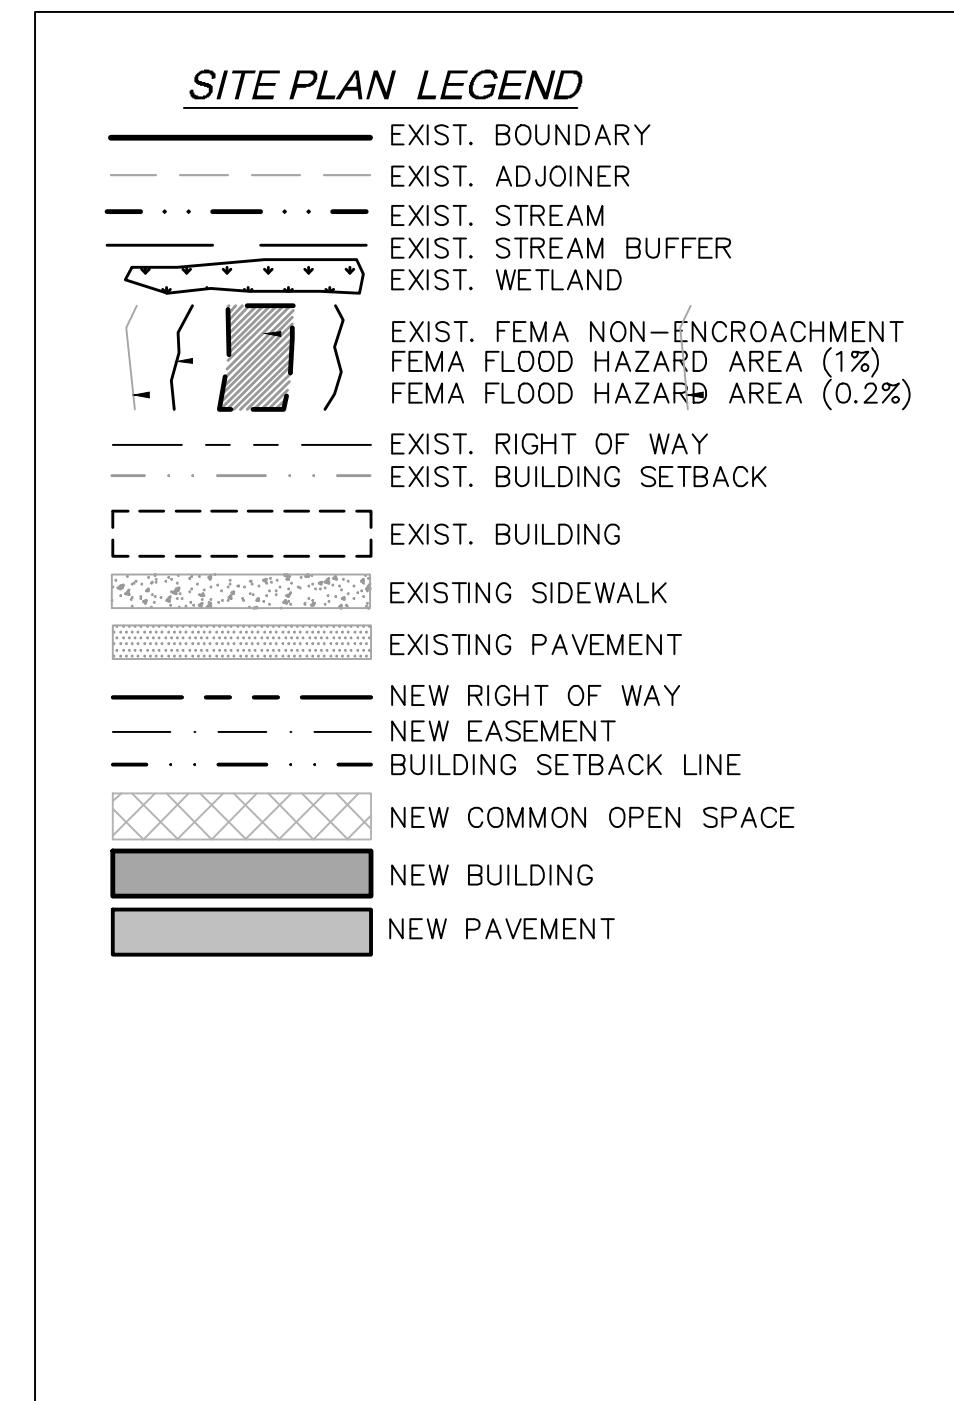


<b>DEVELOPMENT DATA</b>	
PROPERTY ADDRESS:	LOCUST GROVE ROAD HENDERSONVILLE NC
PIN NUMBER:	SEE COVER SHEET
PROPERTY SIZE:	PH3: 150.06 AC - TOTAL: 377.96 AC
ZONING REVIEW:	HENDERSON COUNTY
EROSION CONTROL REVIEW:	HENDERSON COUNTY
STORMWATER REVIEW:	HENDERSON COUNTY
ZONING CLASSIFICATION:	R3
PROPOSED NUMBER OF UNITS:	PH3: 32 - TOTAL: 83
PROPOSED DENSITY:	PH3: 0.21 LOTS/AC - TOTAL: 0.22 LOTS/AC
LOTS 1-1 AND 83 ARE LOCATED WITHIN A FARMLAND PRESERVATION DISTRICT. LOTS 52-82 ARE WITHIN 1/2 MILE OF A FARMLAND DISTRICT.	
WATER AND SEWER WILL BE PROVIDED BY INDIVIDUAL WELLS AND SEPTIC SYSTEMS.	
PUBLIC WATER AND SEWER ARE APPROXIMATELY 3.0 MILES FROM THE SITE.	
DRY HYDRANT IS LOCATED APPROXIMATELY 0.90 ROAD MILES FROM THE ENTRANCE TO THE SITE.	
PROPERTY OWNER: Ripple Falls LLC	
CONTACT: ANDY BAKER	
ADDRESS: 69 CLARK GAP ROAD	
FLETCHER NC	
EMAIL: <a href="mailto:ANDY@FMCAROLINA.COM">ANDY@FMCAROLINA.COM</a>	
PHONE: (616) 402-0367	
DEVELOPER: Ripple Falls LLC	
CONTACT: ANDY BAKER	
ADDRESS: 69 CLARK GAP ROAD	
FLETCHER NC	
EMAIL: <a href="mailto:ANDY@FMCAROLINA.COM">ANDY@FMCAROLINA.COM</a>	
PHONE: (616) 402-0367	
ENGINEER: Brooks Engineering Associates	
CONTACT: JOHN KINNARD, PE	
ADDRESS: 17 ARLINGTON ST	
ASHEVILLE, NC 28801	
EMAIL: <a href="mailto:JKINNARD@BROOKSEA.COM">JKINNARD@BROOKSEA.COM</a>	
PHONE: 828-232-4700	

<b>SITE AND ZONING NOTES</b>	
PROPERTY ZONING:	R3
PROPERTY SIZE:	PH3: 150.06 AC   TOTAL: 377.96 AC
PROPERTY STEEPER THAN 60%:	16.76 AC (6.82%)
MINIMUM LOT SIZE:	1.50 AC / 35,640 SQ.FT.
SMALLEST PROPOSED LOT:	1.52 ACRES / 66,136 SQ.FT.
COMMON OPEN SPACE:	158.73 AC (42.0%)
MINIMUM LOT WIDTH:	30' @ R.O.W.
MAXIMUM BUILDING HEIGHT:	40'
SETBACKS:	
FRONT: 15' (LOCAL)	
REAR: 15'	
SIDE: 15'	
PROPOSED LINEAR FEET OF ROAD:	
PHASE 1: 1,389 LF	
PHASE 2: 2,688 LF	
PHASE 3: 4,415 LF	
TOTAL ON PROPERTY:	15,235 LF
*ALL DIMENSIONS ARE FROM EDGE OF ASPHALT, FACE OF CURB, FACE OF WALL, OR FACE OF BUILDING UNLESS OTHERWISE NOTED.	
*ALL CONSTRUCTION SHALL BE IN ACCORDANCE WITH THE LATEST EDITION OF DETAILS, SPECIFICATIONS, AND OTHER DEVELOPMENT ORDINANCES OF HENDERSON CO.	

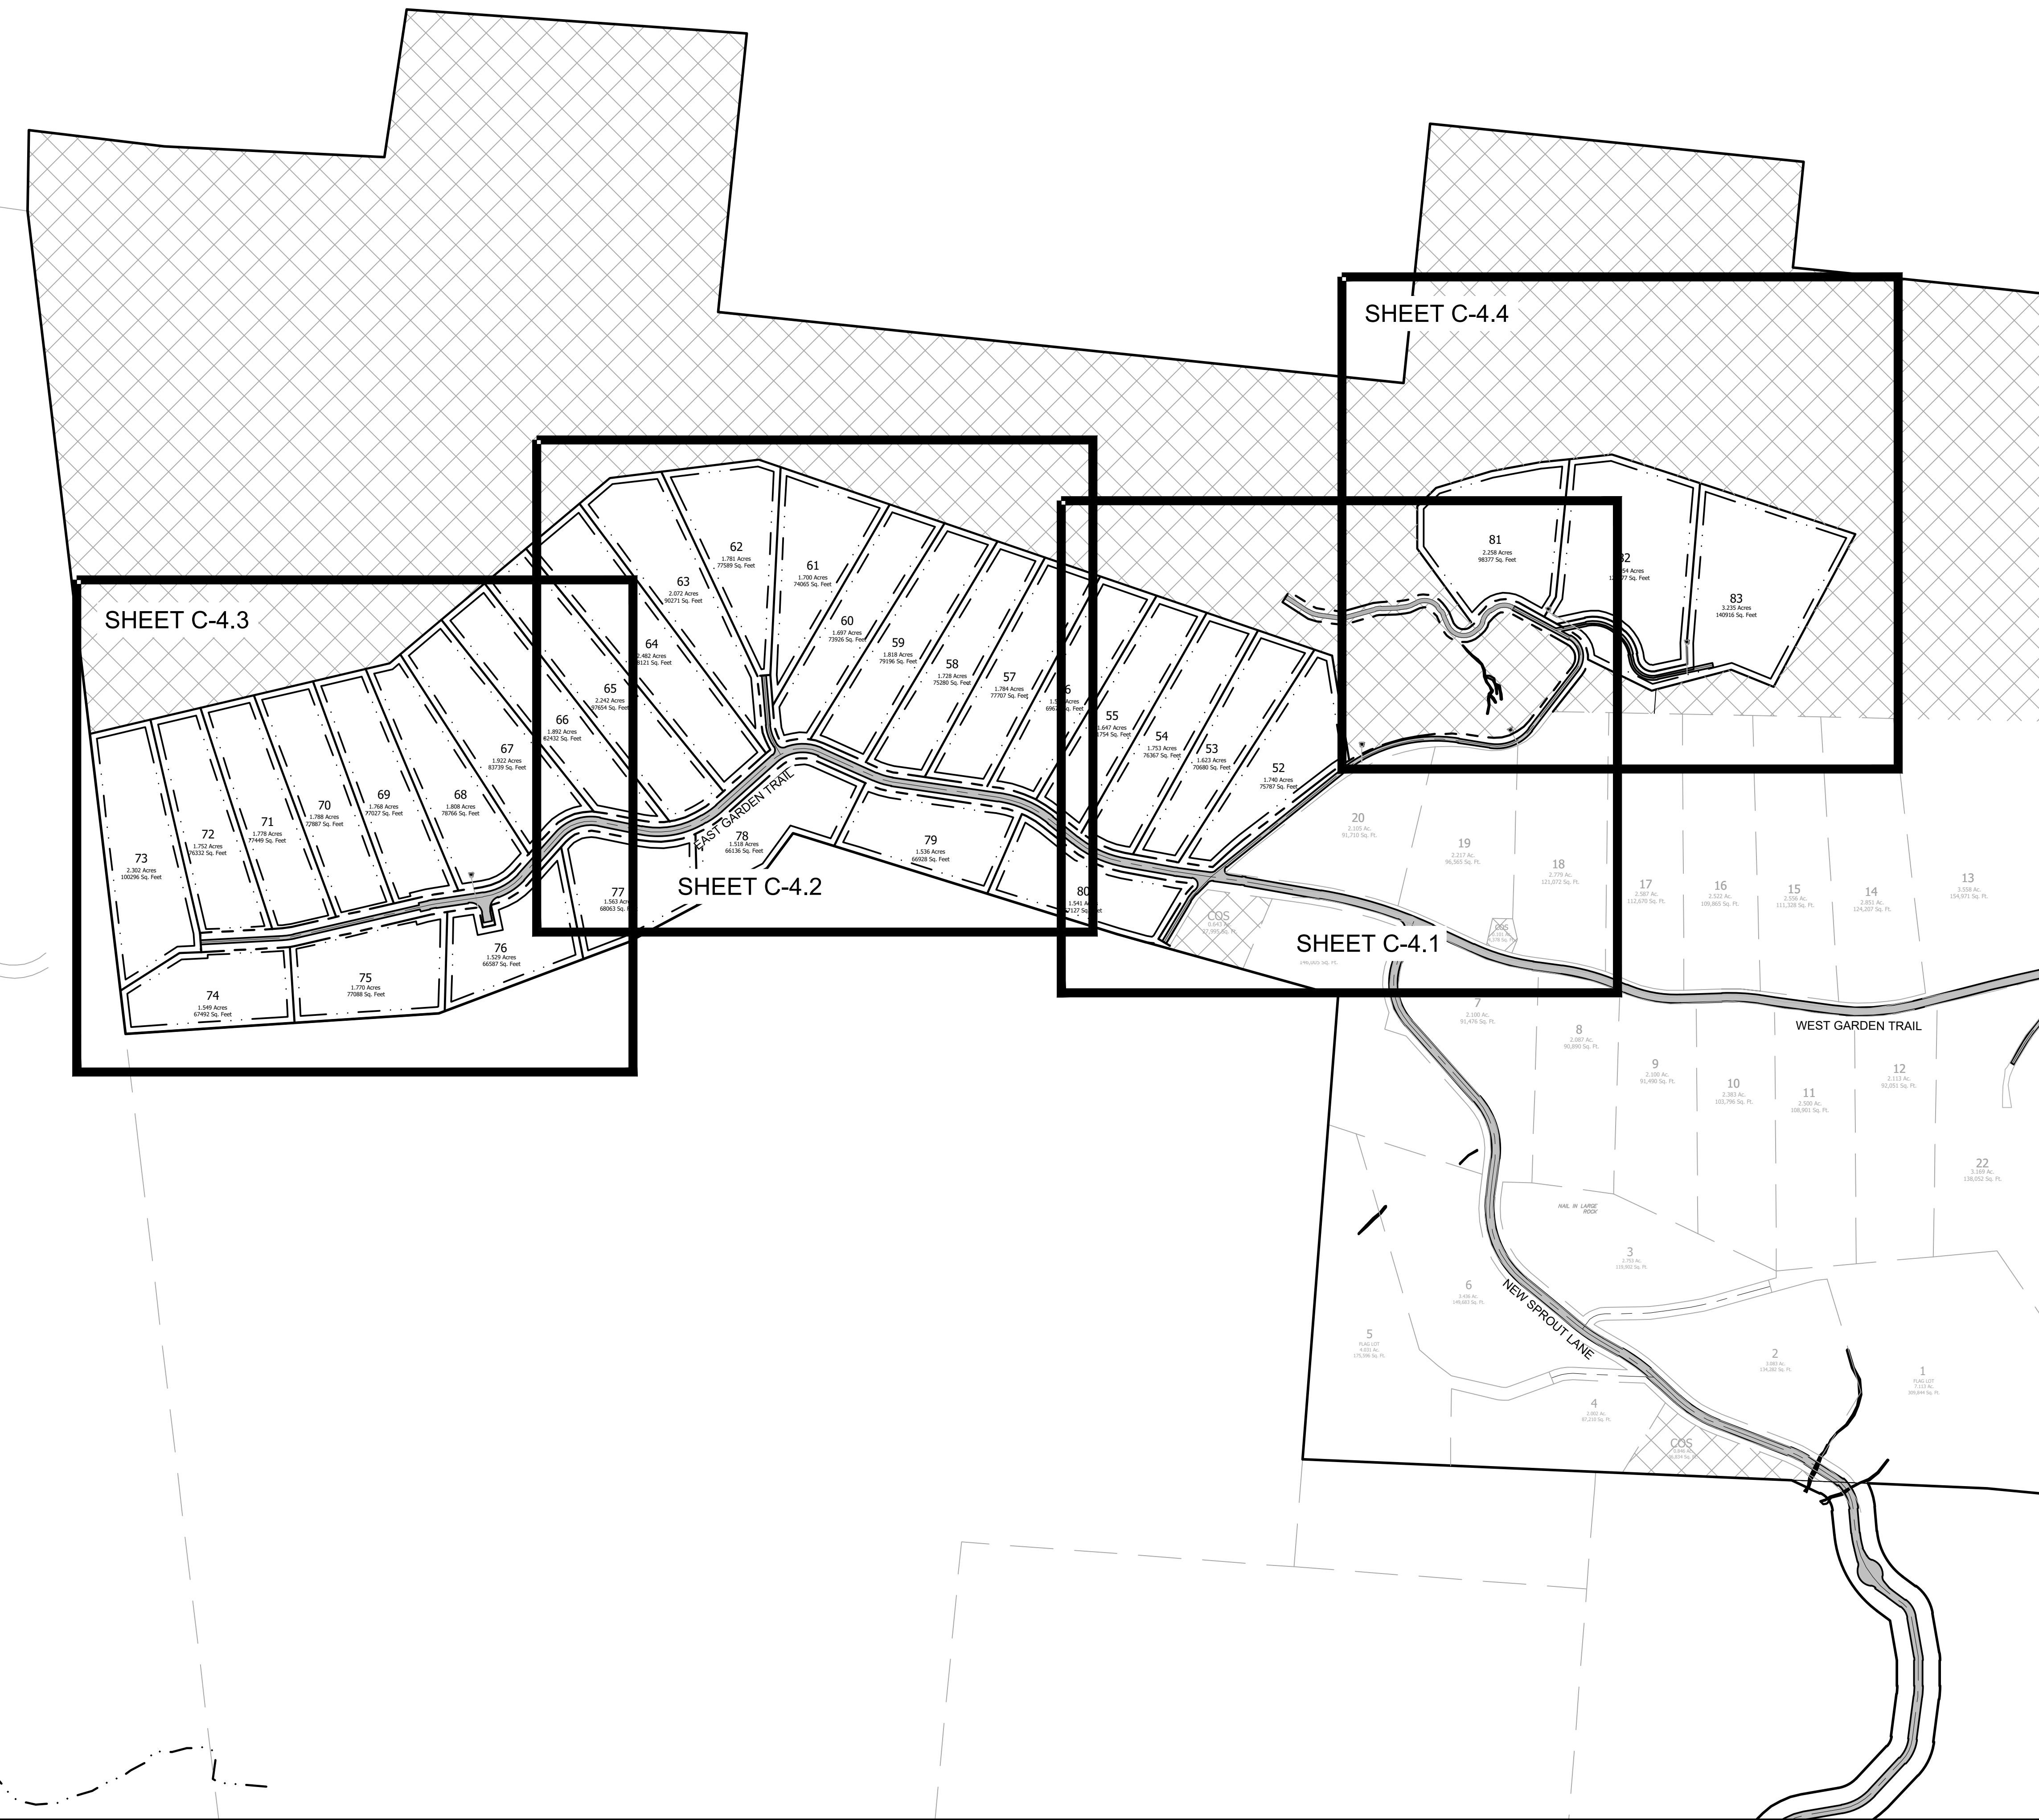


Project No: 543521	RICH MOUNTAIN PHASE 3 MAJOR SUBDIVISION		
OVERALL SITE PLAN		HENDERSON COUNTY	
Drawing Title: C-4.0	HENDERSON COUNTY		
OVERALL SITE PLAN			
NORTH CAROLINA PROFESSIONAL ENGINEER JOHN KINNARD III ICA/CB53249944			
NORTH CAROLINA CERT. NO. C-3125 BROOKS ENGINEERING ASSOCIATES 15 Arlington Street Asheville, NC 28801 Phone: 1-828-232-1331 Fax: 1-828-232-4700 www.brooksea.com			
No.	REVISIONS/SUBMISSIONS	Date	
1	HENDERSON COUNTY PLANNING	12-15-2022	
Revision Submission number within a triangle indicates changes made on this sheet			

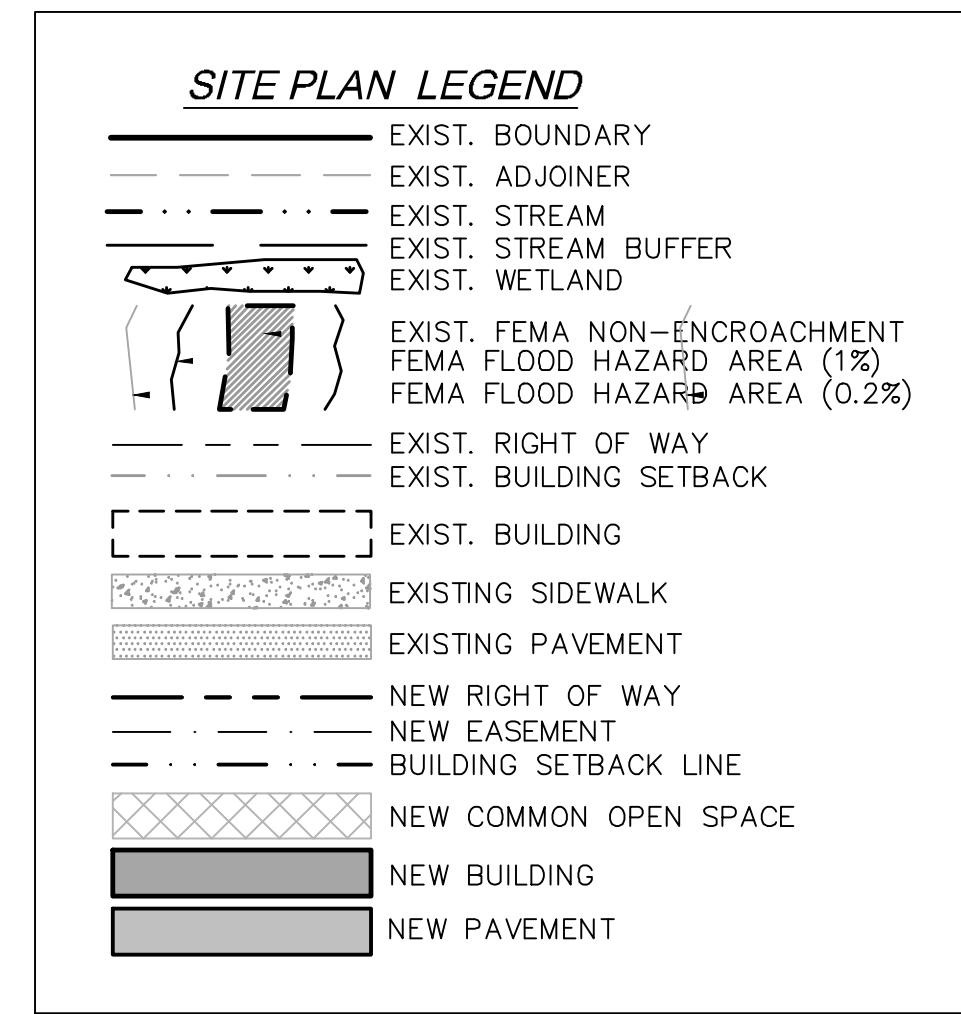

**SITE AND ZONING NOTES**


PROPERTY ZONING: R3  
PROPERTY SIZE: PH3: 150.06 AC | TOTAL: 377.96 AC  
PROPERTY STEEPER THAN 60%: 16.76 AC (6.82%)  
MINIMUM LOT SIZE: 1.50 AC / 35,640 SQ.FT.  
SMALLEST PROPOSED LOT: 1.52 ACRES / 66,136 SQ.FT.  
COMMON OPEN SPACE: 158.73 AC. (42.0%)  
MINIMUM LOT WIDTH: 30' @ R.O.W.  
MAXIMUM BUILDING HEIGHT: 40'  
SETBACKS:  
FRONT: 15' (LOCAL)  
REAR: 15'  
SIDE: 15'  
PROPOSED LINEAR FEET OF ROAD:  
PHASE 1: 7,139 LF  
PHASE 2: 3,681 LF  
PHASE 3: 3,681 LF  
TOTAL ON PROPERTY: 15,235 LF  
\*ALL DIMENSIONS ARE FROM EDGE OF ASPHALT, FACE OF CURB, FACE OF WALL, OR FACE OF BUILDING UNLESS OTHERWISE NOTED.  
\*ALL CONSTRUCTION SHALL BE IN ACCORDANCE WITH THE LATEST EDITION OF DETAILS, SPECIFICATIONS, AND OTHER DEVELOPMENT ORDINANCES OF HENDERSON CO.

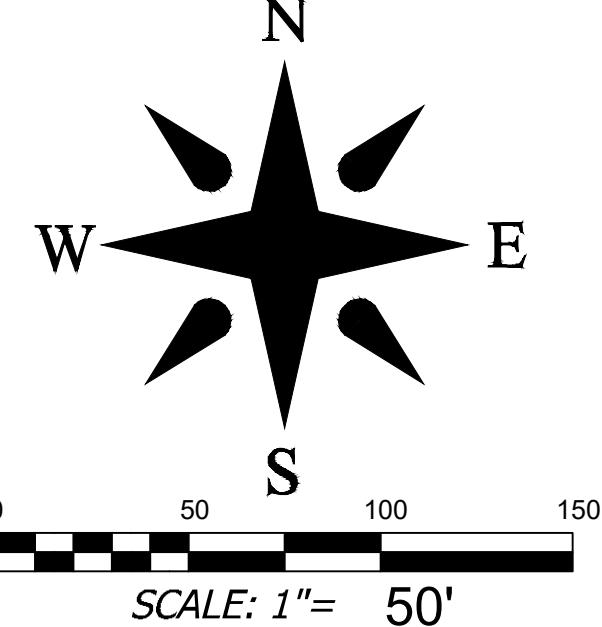

**DEVELOPMENT DATA**


PROPERTY ADDRESS: LOCUST GROVE ROAD HENDERSONVILLE NC  
PIN NUMBER: SEE COVER SHEET  
PROPERTY SIZE: PH3: 150.06 AC. - TOTAL: 377.96 AC.  
ZONING REVIEW: HENDERSON COUNTY  
EROSION CONTROL REVIEW: HENDERSON COUNTY  
STORMWATER REVIEW: HENDERSON COUNTY  
ZONING CLASSIFICATION: R3  
PROPOSED NUMBER OF UNITS: PH3: 32 - TOTAL: 83  
PROPOSED DENSITY: PH3: 0.21 LOTS/AC - TOTAL: 0.22 LOTS/AC  
LOTS 1-51 AND 83 ARE LOCATED WITHIN A FARMLAND PRESERVATION DISTRICT. LOTS 52-82 ARE WITHIN 1/2 MILE OF A FARMLAND DISTRICT.  
WATER AND SEWER WILL BE PROVIDED BY INDIVIDUAL WELLS AND SEPTIC SYSTEMS.  
PUBLIC WATER AND SEWER ARE APPROXIMATELY 3.0 MILES FROM THE SITE.  
DRY HYDRANT IS LOCATED APPROXIMATELY 0.90 ROAD MILES FROM THE ENTRANCE TO THE SITE.  
PROPERTY OWNER: RIPPLE FALLS LLC  
CONTACT: ANDY BAKER  
ADDRESS: 69 CLARK GAP ROAD FLETCHER NC  
EMAIL: ANDY@FMCAROLINA.COM  
PHONE: (616) 402-3367  
DEVELOPER: RIPPLE FALLS LLC  
CONTACT: ANDY BAKER  
ADDRESS: 69 CLARK GAP ROAD FLETCHER NC  
EMAIL: ANDY@FMCAROLINA.COM  
PHONE: (616) 402-3367  
ENGINEER: BROOKS ENGINEERING ASSOCIATES  
CONTACT: JOHN KINNARD, PE  
ADDRESS: 17 ARLINGTON ST ASHEVILLE, NC 28801  
EMAIL: JKINNARD@BROOKSEA.COM  
PHONE: 828-232-4700

**SEE CONTINUATION ON SHEET C-4.2**

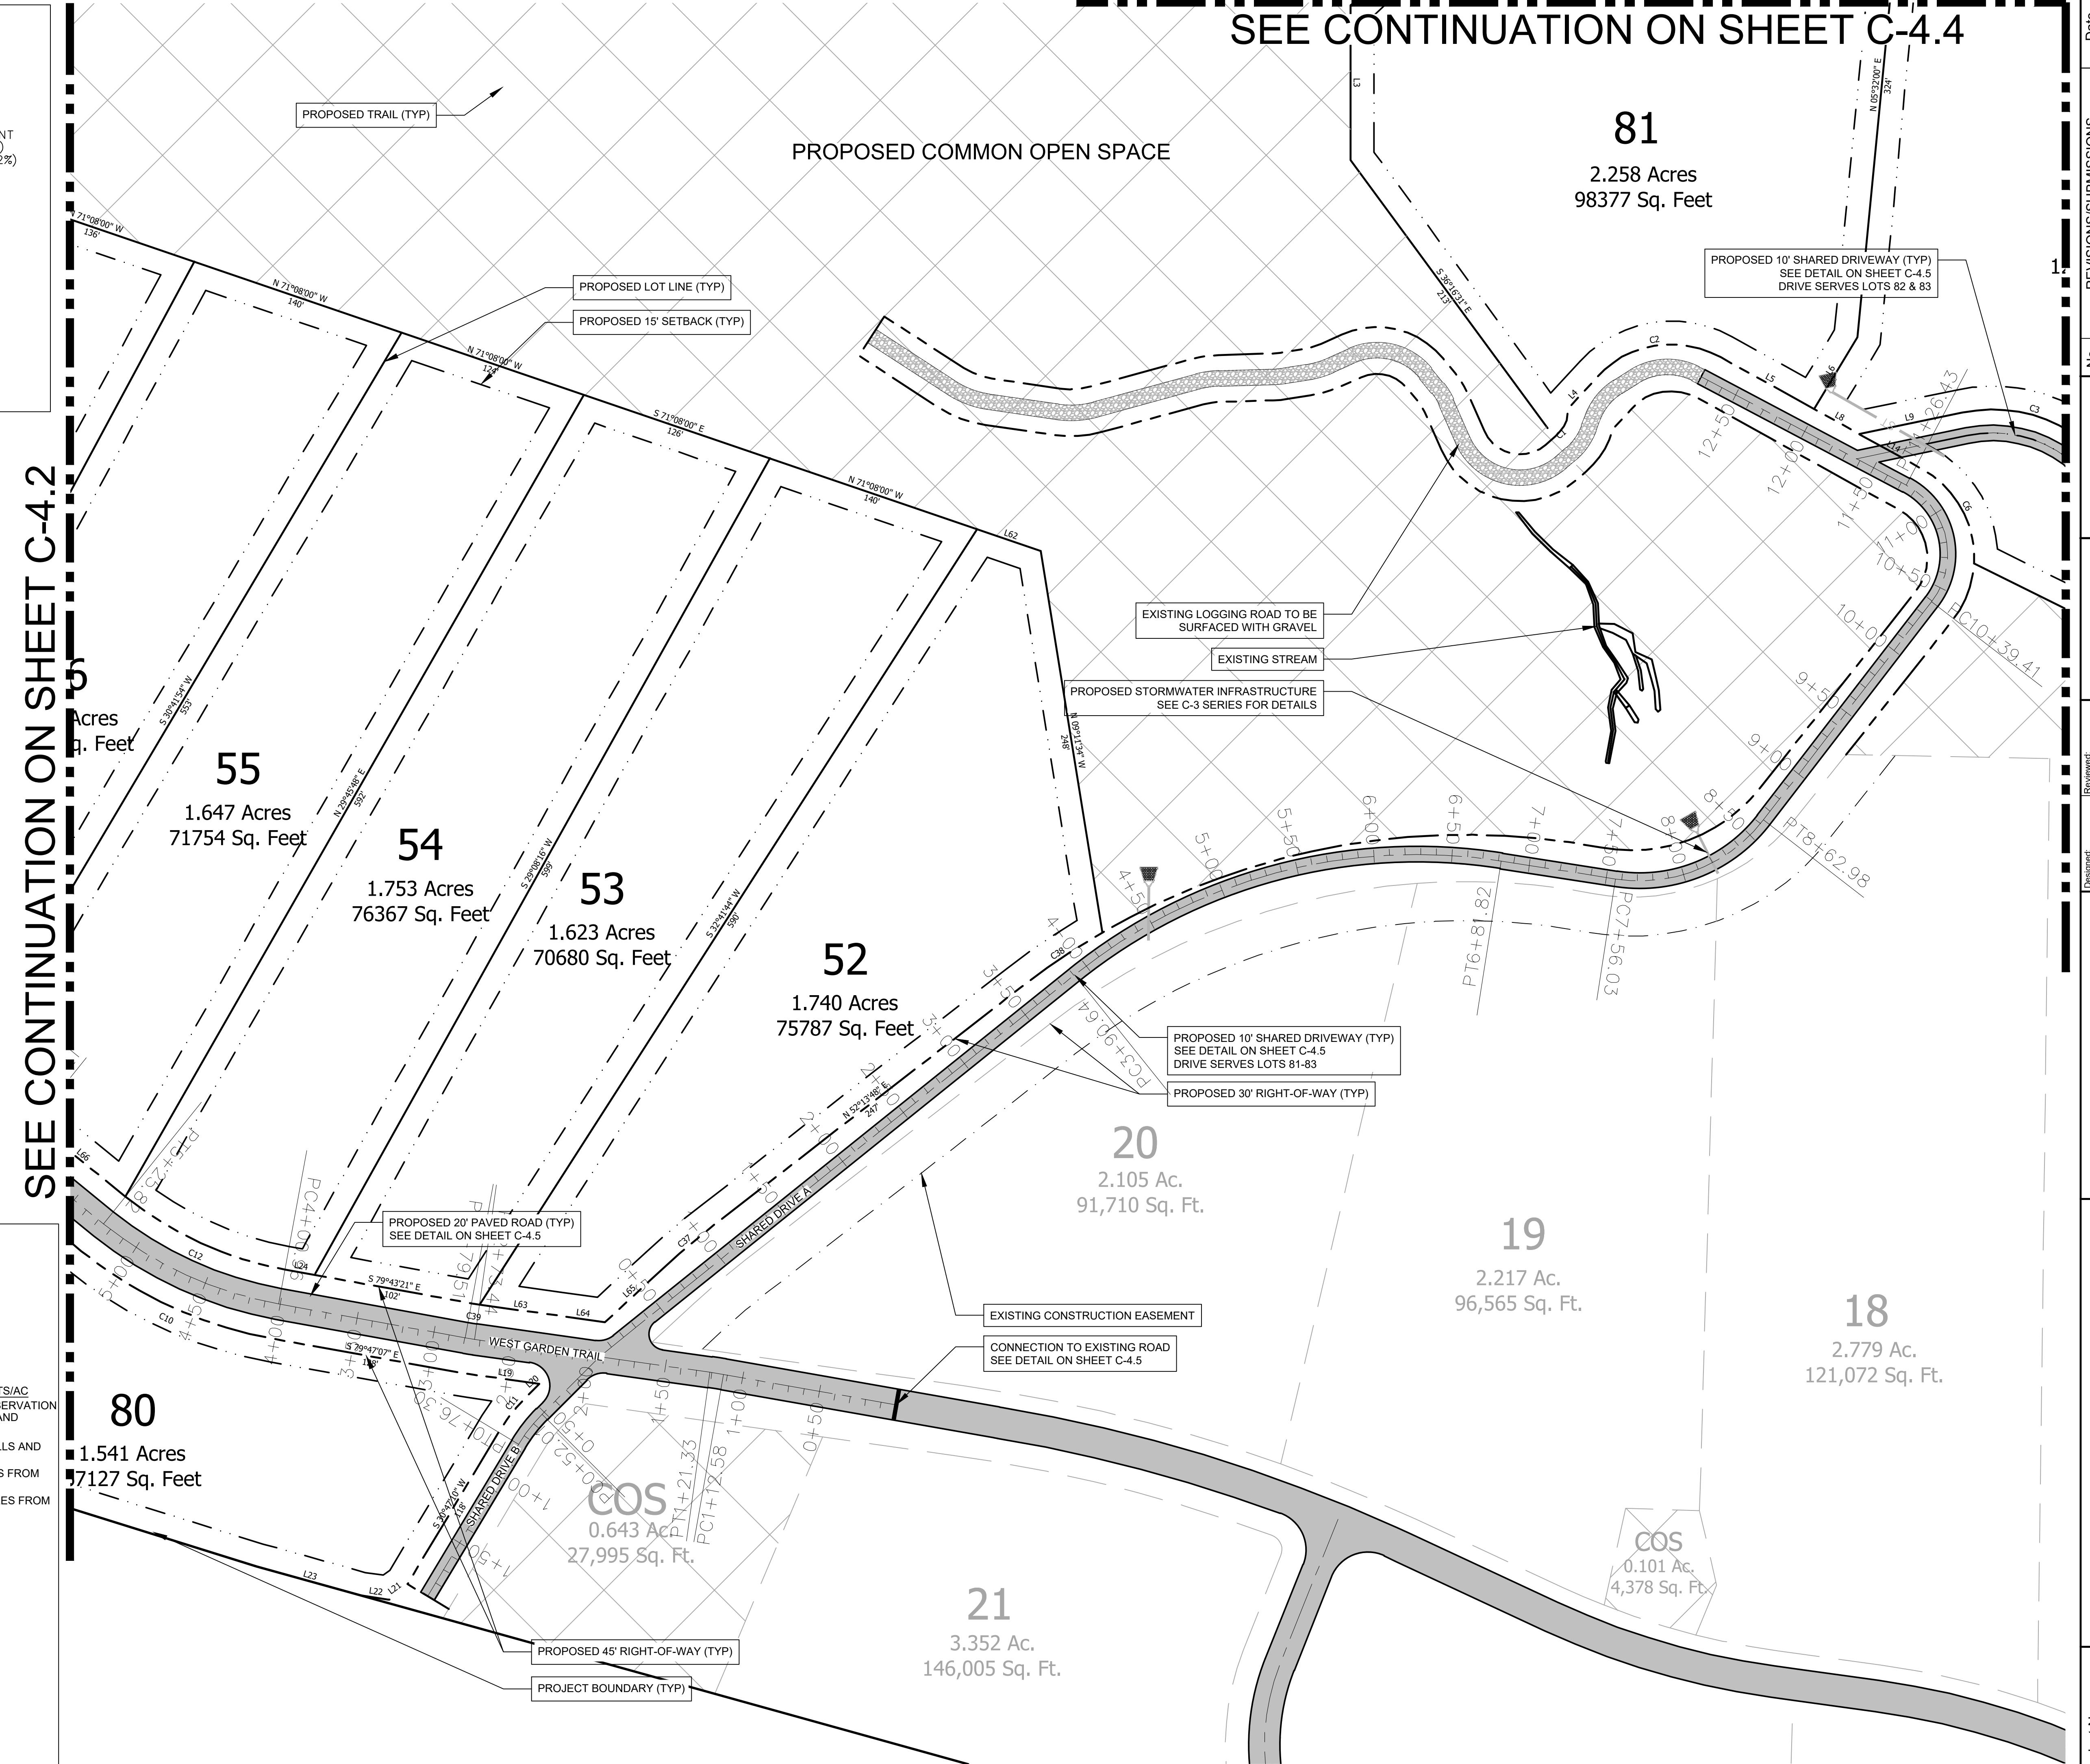


**SEE CONTINUATION ON SHEET C-4.4**

Project No:	543521	REVISIONS/SUBMISSIONS	Date: 12-15-2022
Drawing Title:	C-4.1	No. 1	HENDERSON COUNTY PLANNING
<div style="text-align: center;"> <p>SEAL 035686 JAH Kinnard III 1CAICB5324944...</p> <p><b>BROOKS</b> ENGINEERING ASSOCIATES</p> <p>FINAL DRAWING - FOR REVIEW PURPOSES ONLY</p> </div>			
<small>Revision Submission number within a triangle indicates changes made on this sheet</small>			

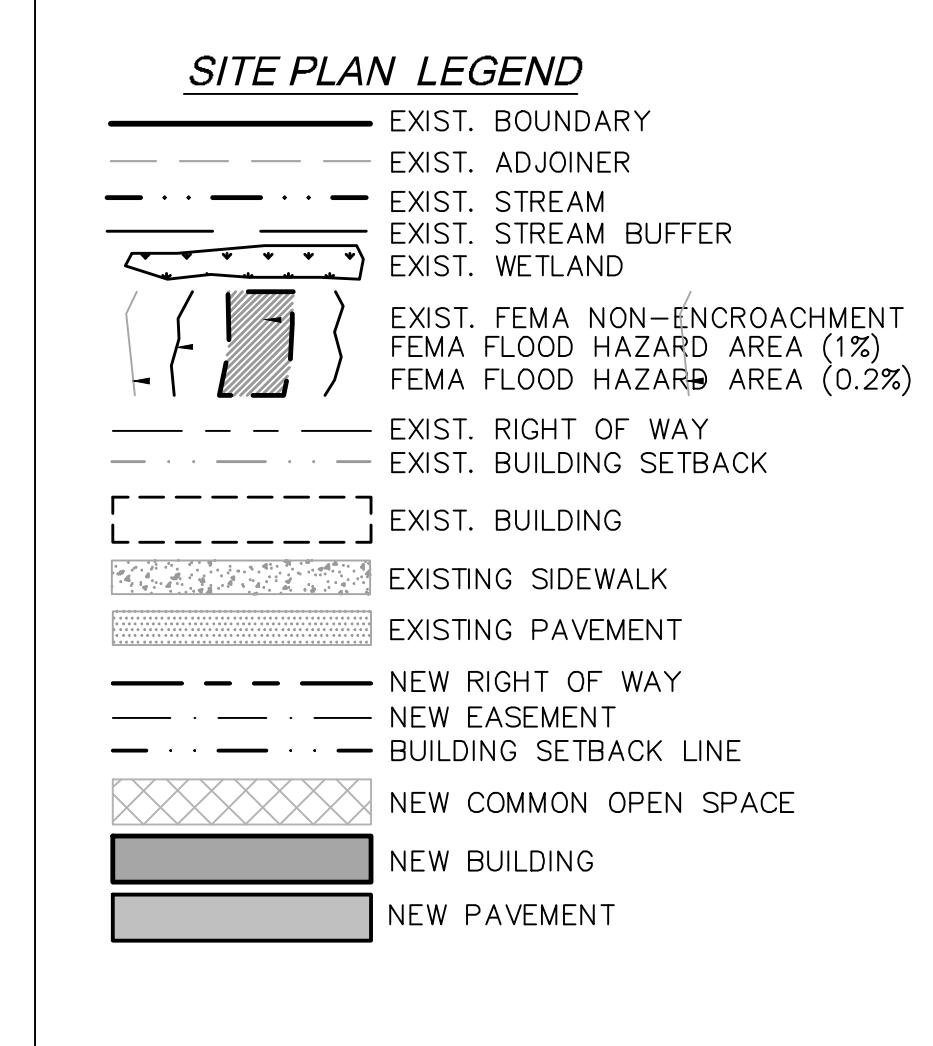

**SITE AND ZONING NOTES**

PROPERTY ZONING: R3  
 PROPERTY SIZE: PH3: 150.06 AC | TOTAL: 377.96 AC  
 PROPERTY STEEPER THAN 60%: 16.76 AC (6.82%)  
 MINIMUM LOT SIZE: 1.50 AC / 35,640 SQ.FT.  
 SMALLEST PROPOSED LOT: 1.52 ACRES / 66,136 SQ.FT.  
 COMMON OPEN SPACE: 158.73 AC (42.0%)  
 MINIMUM LOT WIDTH: 30' @ R.O.W.  
 MAXIMUM BUILDING HEIGHT: 40'  
 SETBACKS:  
 FRONT: 15' (LOCAL)  
 REAR: 15'  
 SIDE: 15'  
 PROPOSED LINEAR FEET OF ROAD:  
 PHASE 1: 7,139 LF  
 PHASE 2: 3,681 LF  
 PHASE 3: 3,681 LF  
 TOTAL ON PROPERTY: 15,235 LF  
 \*ALL DIMENSIONS ARE FROM EDGE OF ASPHALT, FACE OF CURB, FACE OF WALL, OR FACE OF BUILDING UNLESS OTHERWISE NOTED.  
 \*ALL CONSTRUCTION SHALL BE IN ACCORDANCE WITH THE LATEST EDITION OF DETAILS, SPECIFICATIONS, AND OTHER DEVELOPMENT ORDINANCES OF HENDERSON CO.

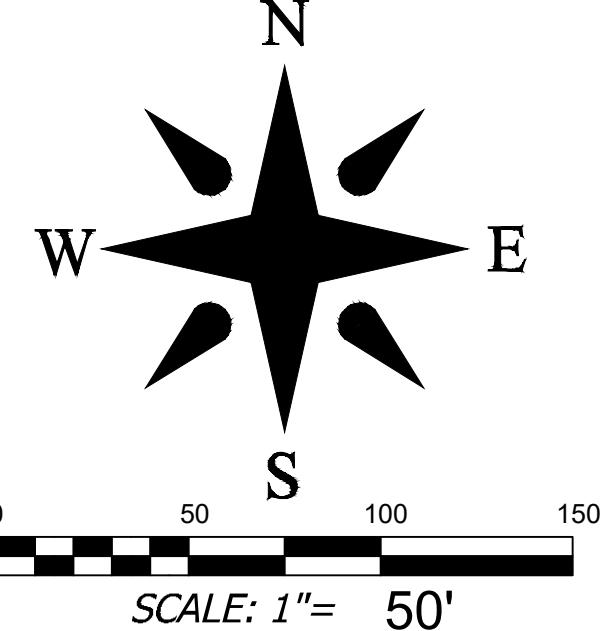

**DEVELOPMENT DATA**


PROPERTY ADDRESS: LOCUST GROVE ROAD HENDERSONVILLE NC  
 PIN NUMBER: SEE COVER SHEET  
 PROPERTY SIZE: PH3: 150.06 AC - TOTAL: 377.96 AC  
 ZONING REVIEW: HENDERSON COUNTY  
 EROSION CONTROL REVIEW: HENDERSON COUNTY  
 STORMWATER REVIEW: HENDERSON COUNTY  
 ZONING CLASSIFICATION: R3  
 PROPOSED NUMBER OF UNITS: PH3: 32 - TOTAL: 83  
 PROPOSED DENSITY: PH3: 0.21 LOTS/AC - TOTAL: 0.22 LOTS/AC  
 LOTS 1-51 AND 83 ARE LOCATED WITHIN A FARMLAND PRESERVATION DISTRICT. LOTS 52-82 ARE WITHIN 1/2 MILE OF A FARMLAND DISTRICT.  
 WATER AND SEWER WILL BE PROVIDED BY INDIVIDUAL WELLS AND SEPTIC SYSTEMS.  
 PUBLIC WATER AND SEWER ARE APPROXIMATELY 3.0 MILES FROM THE SITE.  
 DRY HYDRANT IS LOCATED APPROXIMATELY 0.90 ROAD MILES FROM THE ENTRANCE TO THE SITE.  
 PROPERTY OWNER: RIPPLE FALLS LLC  
 CONTACT: ANDY BAKER  
 ADDRESS: 69 CLARK GAP ROAD FLETCHER NC  
 EMAIL: ANDY@FMCAROLINA.COM  
 PHONE: (616) 402-3367  
 DEVELOPER: RIPPLE FALLS LLC  
 CONTACT: ANDY BAKER  
 ADDRESS: 69 CLARK GAP ROAD FLETCHER NC  
 EMAIL: ANDY@FMCAROLINA.COM  
 PHONE: (616) 402-3367  
 ENGINEER: BROOKS ENGINEERING ASSOCIATES  
 CONTACT: JOHN KINNARD, PE  
 ADDRESS: 17 ARLINGTON ST ASHEVILLE, NC 28801  
 EMAIL: JKINNARD@BROOKSEA.COM  
 PHONE: 828-232-4700

**SEE CONTINUATION ON SHEET C-4.3**




Project No:	543521	REVISIONS/SUBMISSIONS	Date
C-4.2	HENDERSON COUNTY	1 HENDERSON COUNTY PLANNING	12-15-2022
Drawing Title:			
No. 1 REVISION NUMBER SEAL OF NORTH CAROLINA PROFESSIONAL ENGINEER JOHN KINNARD III 035686 1CA1CB532489444...  NORTH CAROLINA CERTIFICATE C-3125 ENGINEERS & PLANNERS FINAL DRAWING - FOR REVIEW PURPOSES ONLY			
Reviewed: JHK Drawn: ZAW Checked: AS-NOTED Date: 12-15-2022 JHK 15 Arlington Street Asheville, NC 28801 Phone: 1-828-232-1331 Fax: 1-828-232-4700 www.brooksea.com			



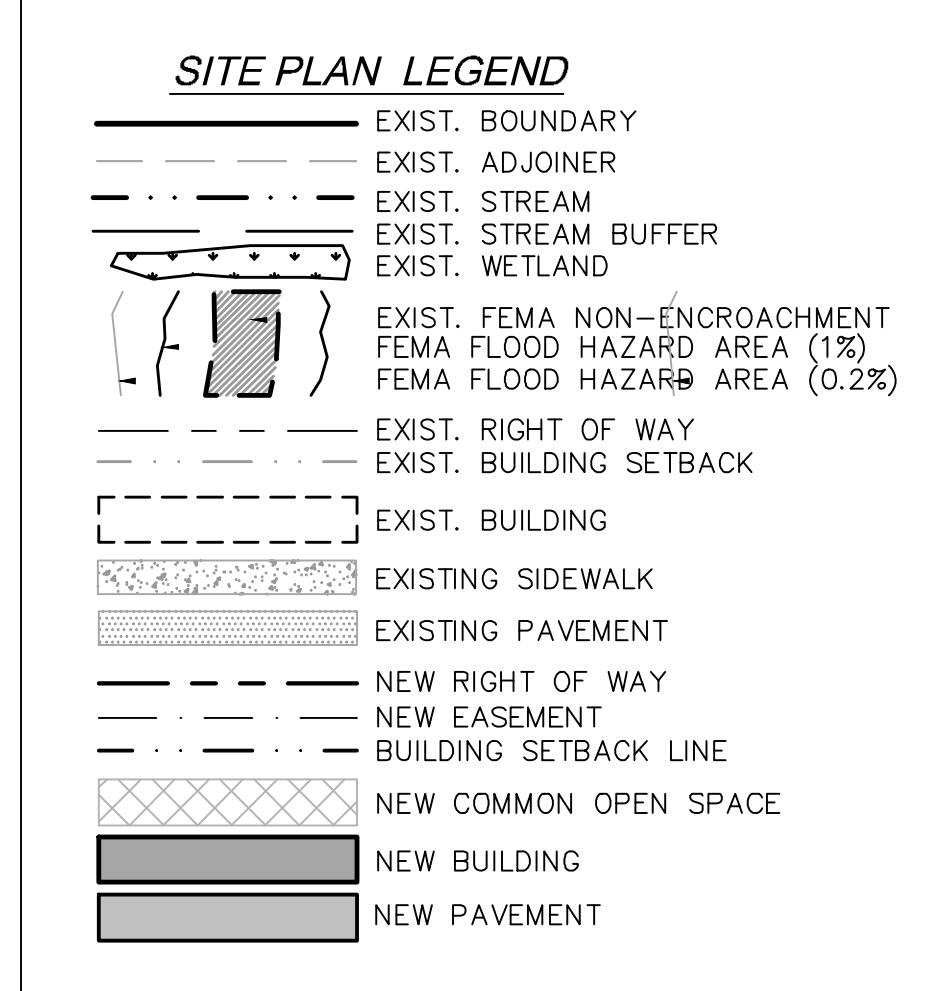


**SITE AND ZONING NOTES**

PROPERTY ZONING: R3  
 PROPERTY SIZE: PH3: 150.06 AC | TOTAL: 377.96 AC  
 PROPERTY STEEPER THAN 60%: 16.76 AC (6.82%)  
 MINIMUM LOT SIZE: 1.50 AC / 35,640 SQ.FT.  
 SMALLEST PROPOSED LOT: 1.52 ACRES / 66,136 SQ.FT.  
 COMMON OPEN SPACE: 158.73 AC (42.0%)  
 MINIMUM LOT WIDTH: 30' @ R.O.W.  
 MAXIMUM BUILDING HEIGHT: 40'  
 SETBACKS:  
 FRONT: 15' (LOCAL)  
 REAR: 15'  
 SIDE: 15'  
 PROPOSED LINEAR FEET OF ROAD:  
 PHASE 1: 7,139 LF  
 PHASE 2: 3,681 LF  
 PHASE 3: 3,615 LF  
 TOTAL ON PROPERTY: 15,235 LF  
 \*ALL DIMENSIONS ARE FROM EDGE OF  
 ASPHALT, FACE OF CURB, FACE OF WALL,  
 OR FACE OF BUILDING UNLESS OTHERWISE  
 NOTED.  
 \*ALL CONSTRUCTION SHALL BE IN  
 ACCORDANCE WITH THE LATEST EDITION OF  
 DETAILS, SPECIFICATIONS, AND OTHER  
 DEVELOPMENT ORDINANCES OF HENDERSON CO.

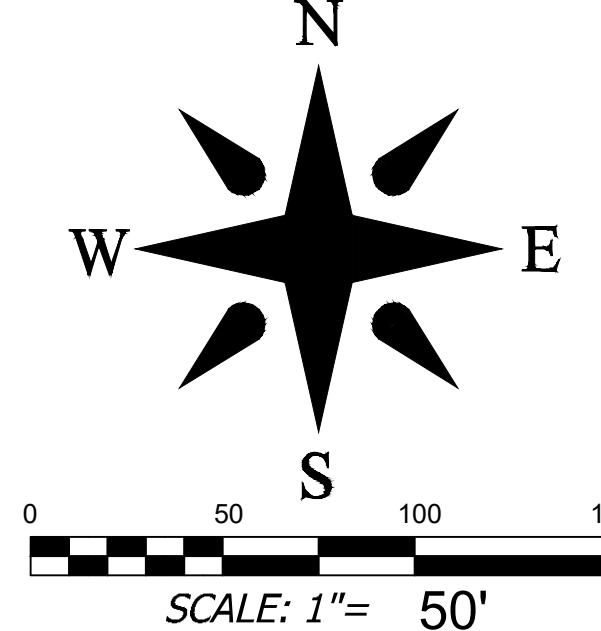



**DEVELOPMENT DATA**

PROPERTY ADDRESS: LOCUST GROVE ROAD  
 HENDERSONVILLE NC  
 PIN NUMBER: SEE COVER SHEET  
 PROPERTY SIZE: PH3: 150.06 AC - TOTAL: 377.96 AC  
 ZONING REVIEW: HENDERSON COUNTY  
 EROSION CONTROL REVIEW: HENDERSON COUNTY  
 STORMWATER REVIEW: HENDERSON COUNTY  
 ZONING CLASSIFICATION: R3  
 PROPOSED NUMBER OF UNITS: PH3: 32 - TOTAL: 83  
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 PROPERTY OWNER: RIPPLE FALLS LLC  
 CONTACT: ANDY BAKER  
 ADDRESS: 69 CLARK GAP ROAD  
 FLETCHER NC  
 EMAIL: ANDY@FMCAROLINA.COM  
 PHONE: (616) 402-0367  
 DEVELOPER: RIPPLE FALLS LLC  
 CONTACT: ANDY BAKER  
 ADDRESS: 69 CLARK GAP ROAD  
 FLETCHER NC  
 EMAIL: ANDY@FMCAROLINA.COM  
 PHONE: (616) 402-0367  
 ENGINEER: BROOKS ENGINEERING ASSOCIATES  
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 ASHEVILLE, NC 28801  
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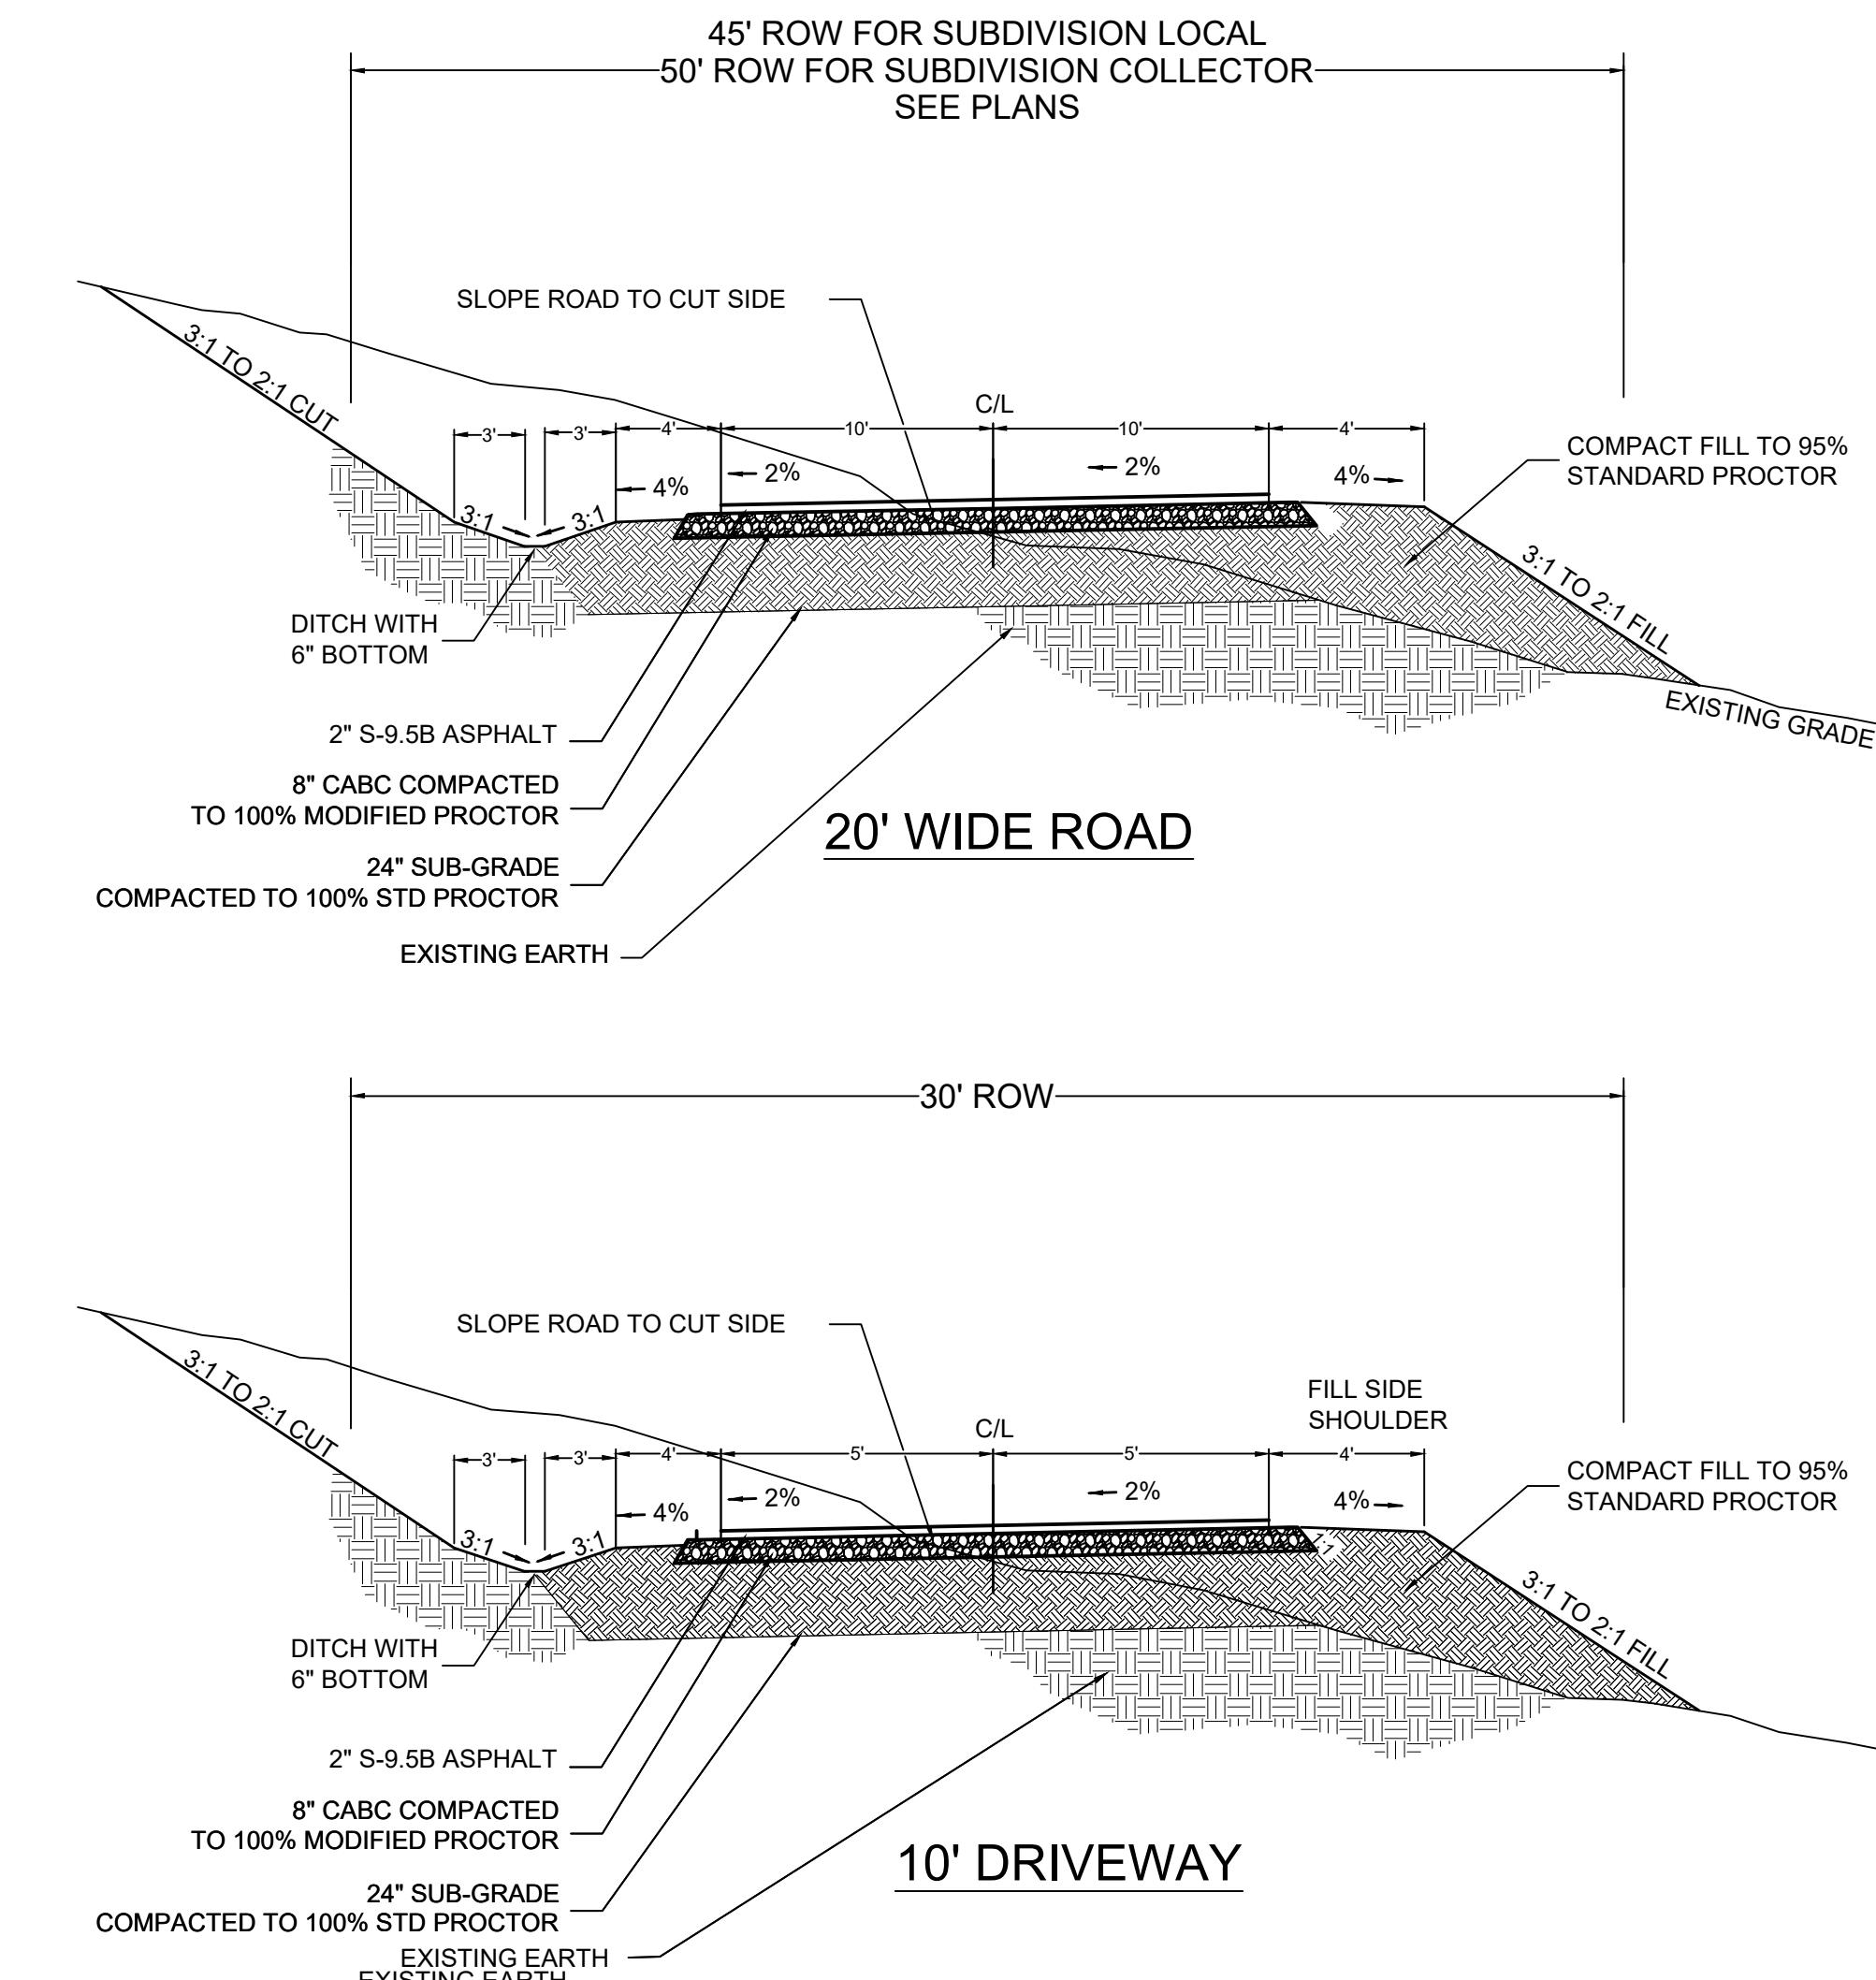
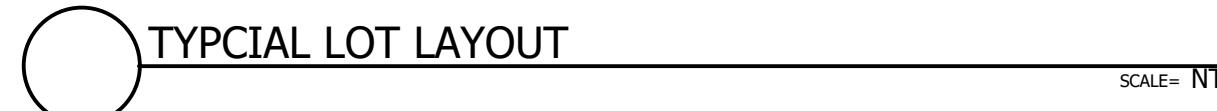
SEE CONTINUATION ON SHEET C-4.1

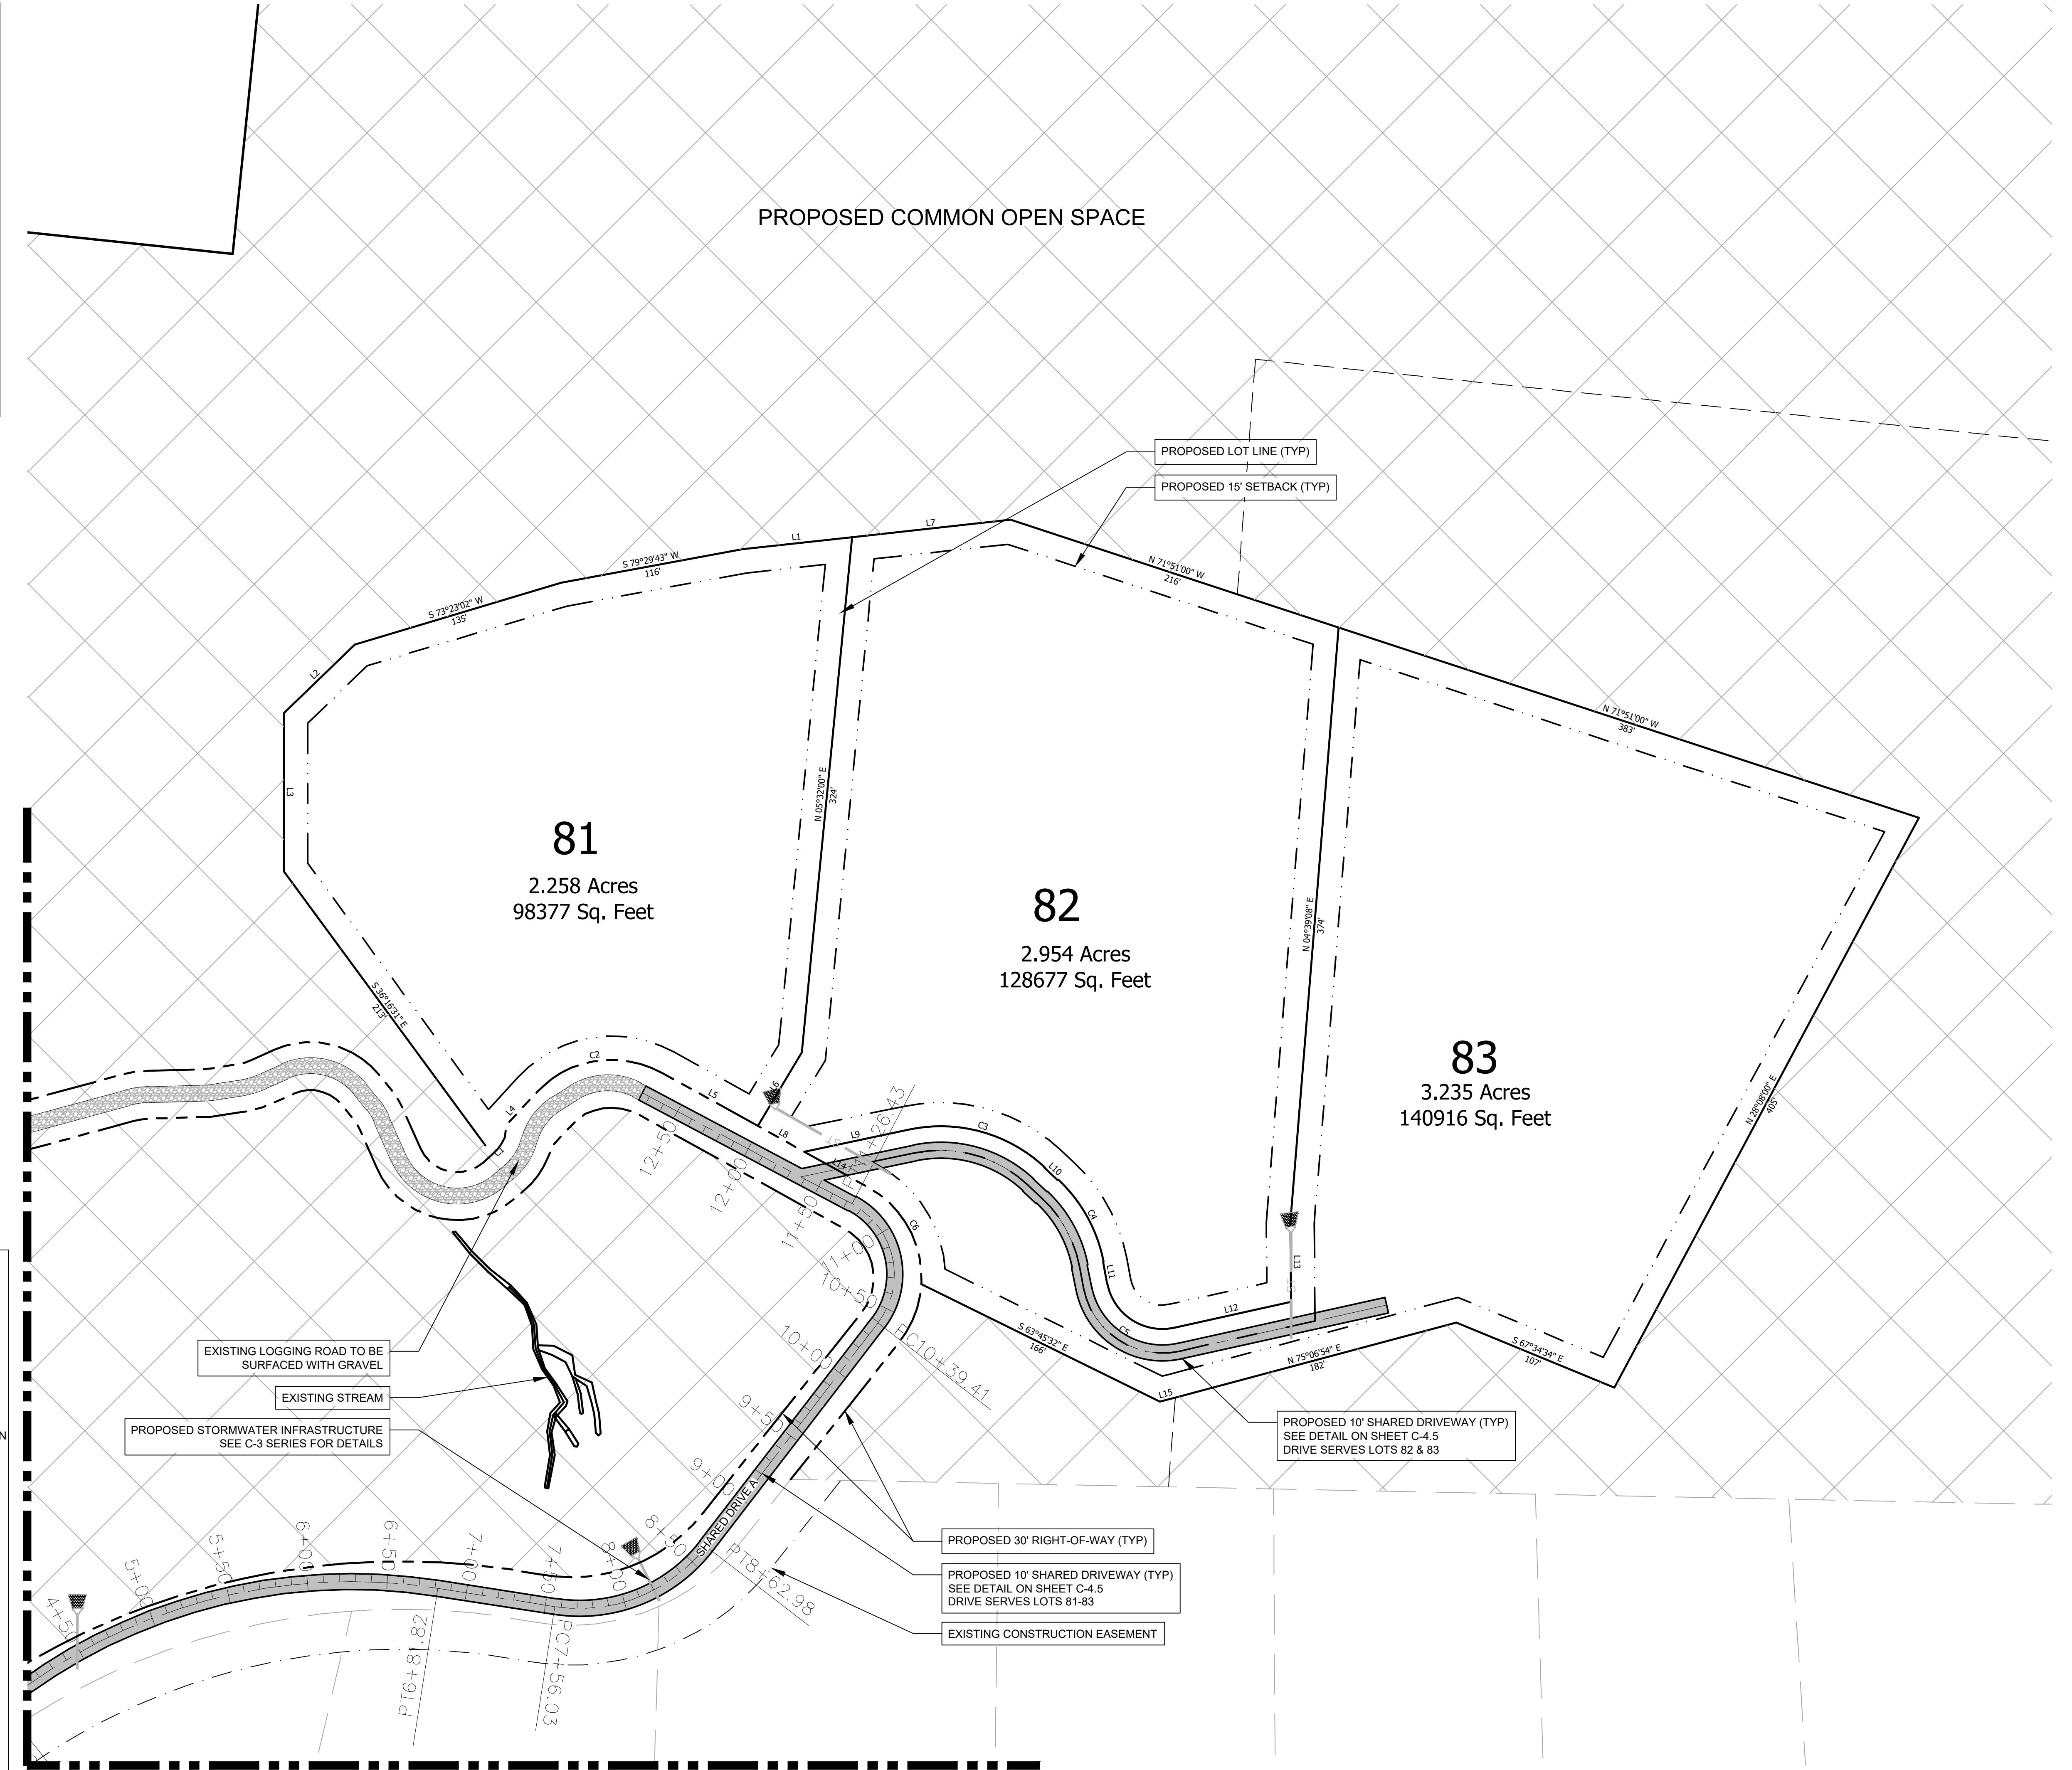Project No: 543521	RICH MOUNTAIN PHASE 3		
MAJOR SUBDIVISION		NORTH CAROLINA	
C-4.4	HENDERSON COUNTY	HENDERSON COUNTY	
Drawing Title: C-4.4	SITE PLAN		
No. 1	REVISIONS/SUBMISSIONS		
1 HENDERSON COUNTY PLANNING		Date 12-15-2022	
Revision Submission number within a triangle indicates changes made on this sheet			
 <b>JOHN KINNARD III</b> 1CATCB53249444			
 <b>BROOKS</b> ENGINEERING ASSOCIATES NORTH CAROLINA CERT.C-3125 15 Arlington Street Asheville, NC 28801 Phone: 1-828-232-4700 Fax: 1-828-232-1331 www.brooksea.com			
FINAL DRAWING - FOR REVIEW PURPOSES ONLY			

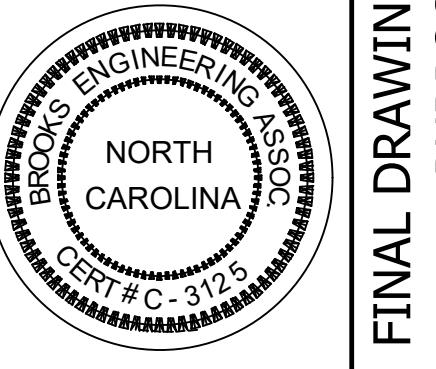


**STORMWATER NOTES:**

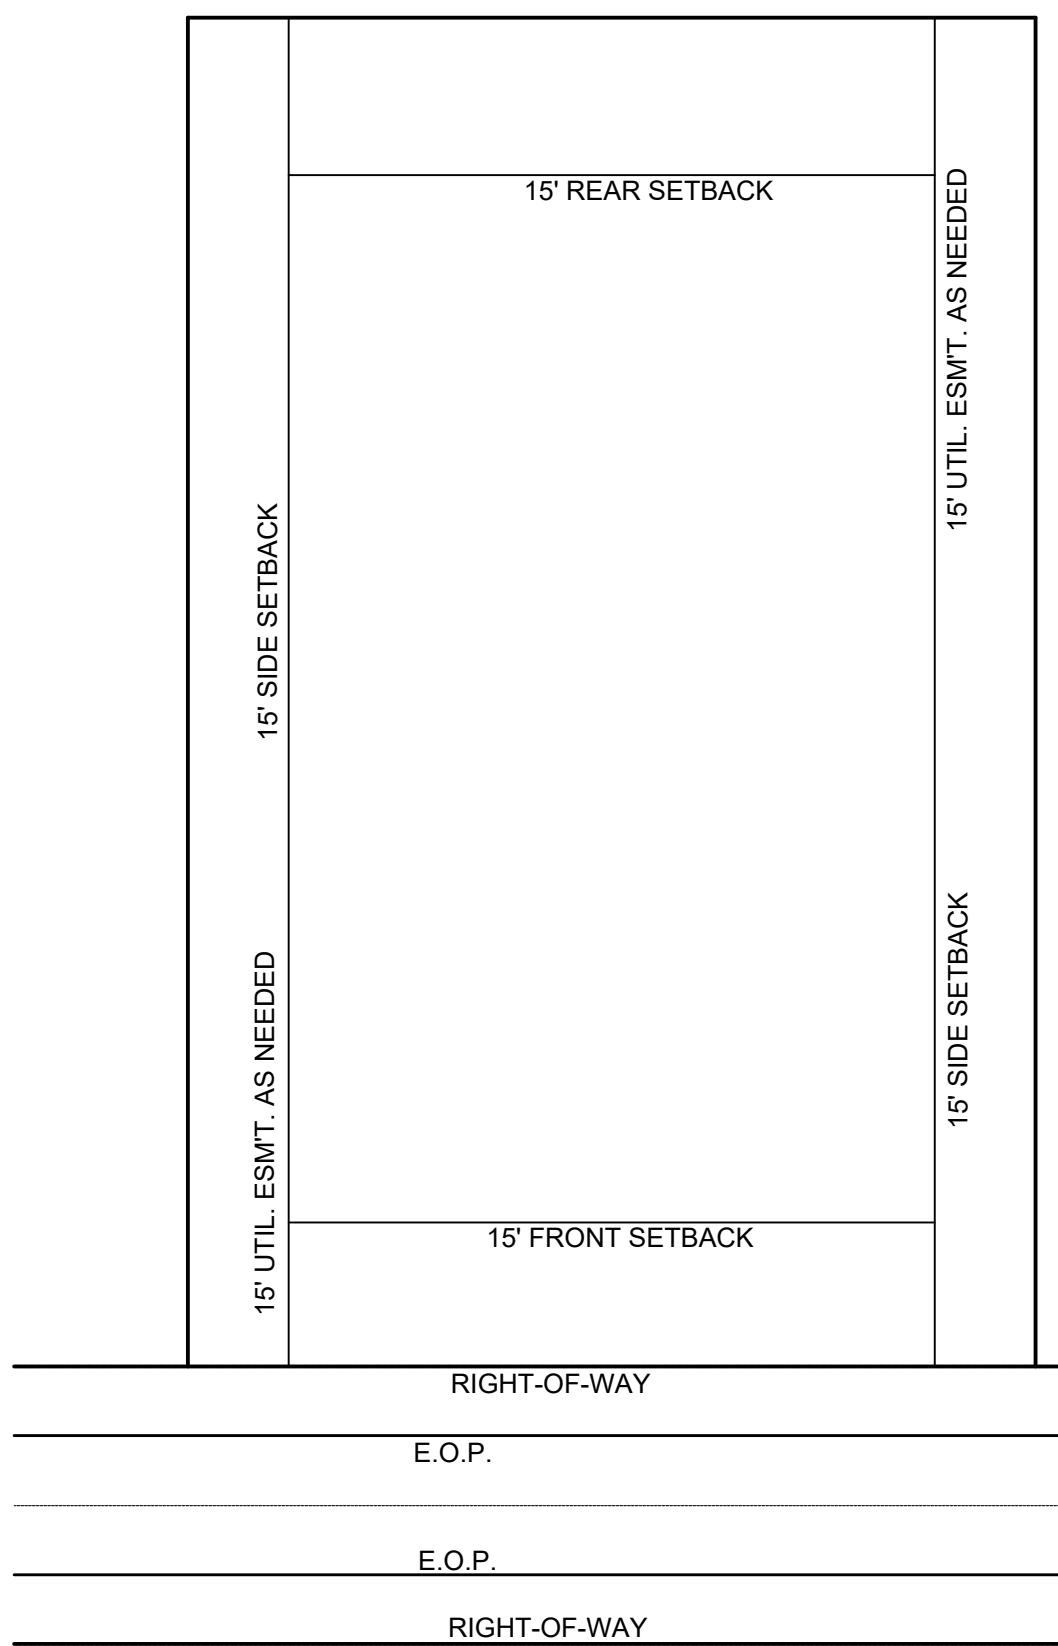1. FOR PROPOSED LOTS UP GRADIENT OF THE ROAD, DIRECT IMPERVIOUS AREA TO ROADSIDE SWALES BY USE OF DRIVEWAY DITCHES. DRIVEWAYS SHALL BE SLOPED TOWARDS VEGETATED CONVEYANCES.
2. FOR PROPOSED LOTS DOWN GRADIENT OF THE ROAD, DIRECT WATER TO SHEET FLOW OFF SITE.
3. ROOF DRAINS SHALL TERMINATE 10' FROM THE FOOTPRINT & ENTER VEGETATED STORMWATER CONVEYANCES.




**NOTES:**

1. NO BASE COURSE SHALL BE PLACED ON MUCK, PIPE CLAY, ORGANIC MATTER, OR OTHER UNSUITABLE MATERIAL.
2. DITCHES SHALL HAVE A MAXIMUM 3:1 SIDE SLOPE ON EACH SIDE FOR 1 VERTICAL FROM THE BOTTOM OF DITCH.
3. ROADS SHALL BE DESIGNED AND BUILT IN ACCORDANCE WITH "PRIVATE SUBDIVISION LOCAL ROAD" STANDARDS PER THE HENDERSON COUNTY SUBDIVISION REGULATIONS, LATEST EDITION.

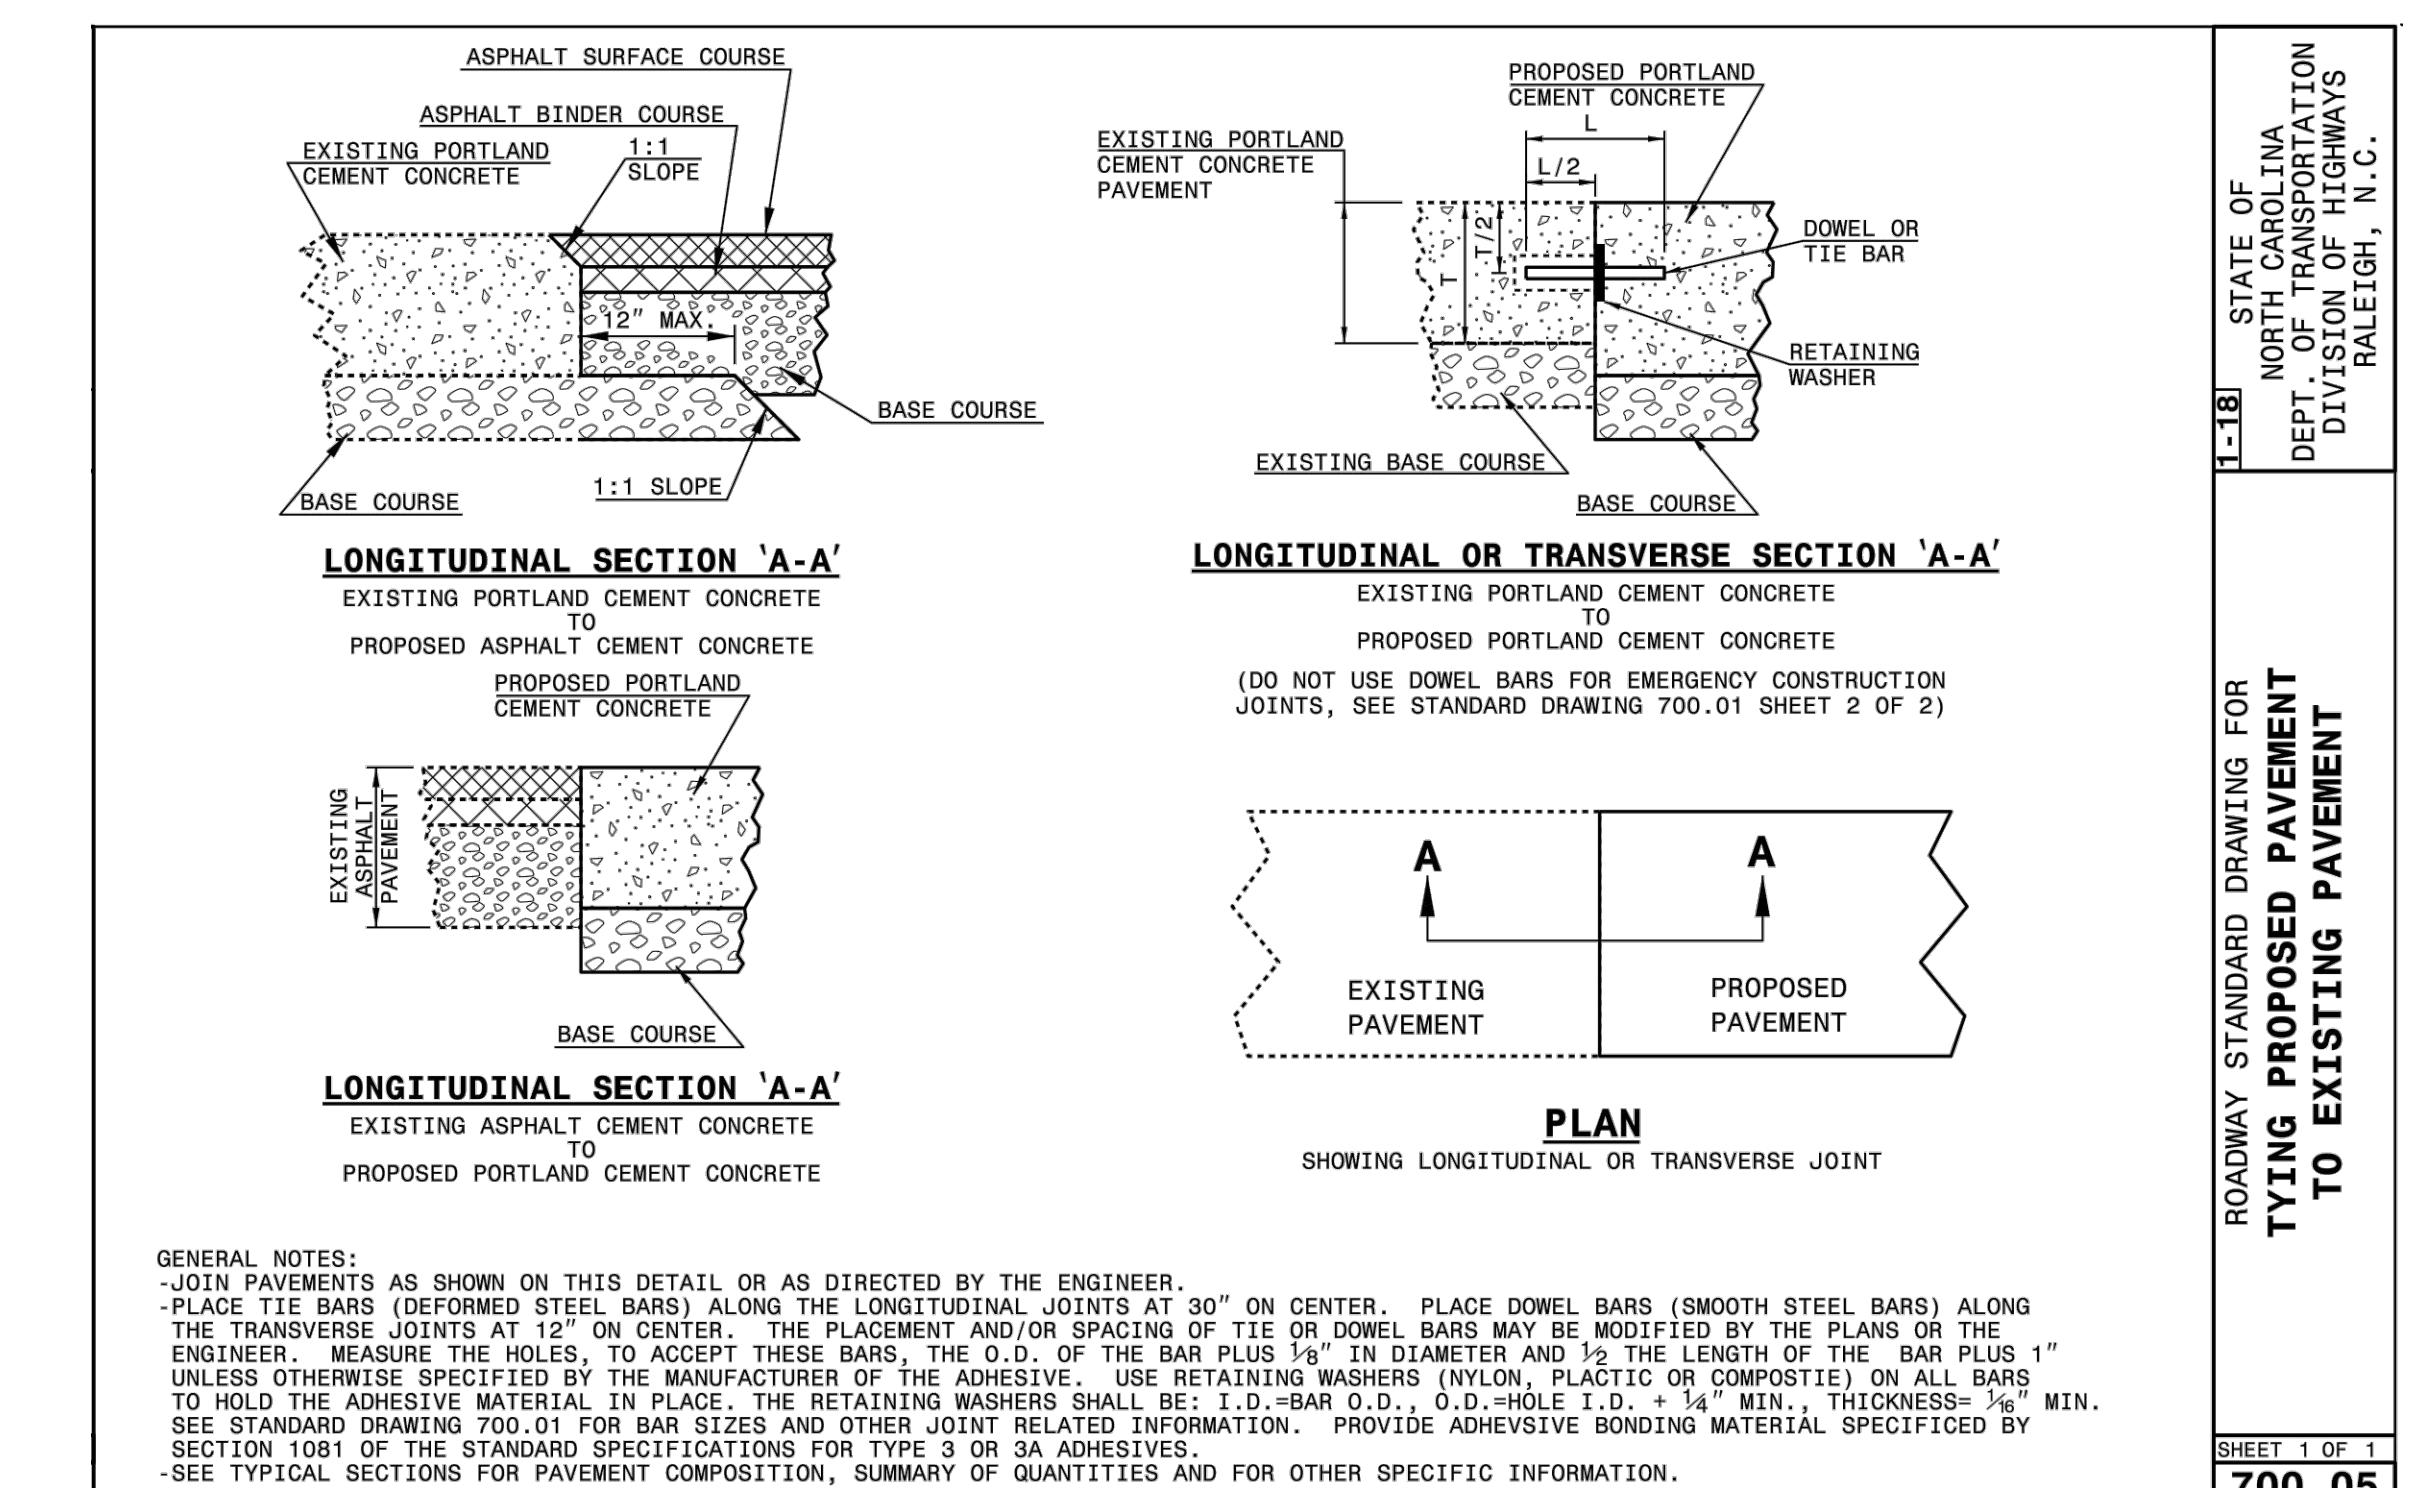

TYING PROPOSED PAVEMENT TO EXISTING PAVEMENT (NCDOT 700.05)

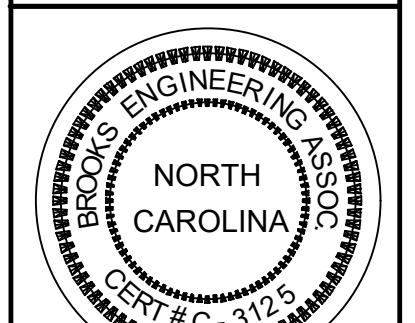Project No: 543521	RICH MOUNTAIN PHASE 3 MAJOR SUBDIVISION HENDERSON COUNTY NORTH CAROLINA	Reviewed: JHK Scale: ZAW Drawn: JHK Checked: JHK Date: 12-16-2022	No. 1 REVISIONS/SUBMISSIONS 1 HENDERSON COUNTY PLANNING Date 12-15-2022
FILE LOCATION: L:\2021 Projects\543521\Rich Mtain Due Diligence\Drawings\Phase 3\Civil Details\543521_Ph3.dwg		Site Submission number within a triangle indicates changes made on this sheet	
C-4.5		FINAL DRAWING - FOR REVIEW PURPOSES ONLY	
		 	
		<b>BROOKS</b> ENGINEERING ASSOCIATES 15 Arlington Street Asheville, NC 28801 Phone: 1-828-232-1331 Fax: 1-828-232-4700 www.brooksea.com	
SHEET 1 OF 1 <b>700.05</b>			
SITE DETAILS			

LINE	BEARING	DISTANCE
L1	S 45°54'39" W	61.72'
L2	S 00°00'00" E	99.04'
L3	N 42°44'08" E	37.12'
L4	S 60°58'28" E	68.29'
L5	N 31°07'06" E	53.70'
L6	S 83°43'59" W	99.84'
L7	S 60°58'28" E	33.23'
L8	N 78°12'33" E	67.46'
L9	S 46°50'57" E	11.66'
L10	S 10°56'53" E	13.90'
L11	N 77°30'03" E	74.96'
L12	N 00°35'19" W	49.55'
L13	S 60°58'28" E	45.88'
L14	N 75°06'54" E	10.16'
L15	N 42°01'23" E	16.63'
L16	S 78°32'40" E	99.77'
L17	S 51°06'19" E	75.39'
L18	S 82°02'19" E	44.50'
L19	S 47°08'09" W	3.92'
L20	S 53°14'11" W	14.32'
L21	N 81°29'40" W	18.79'
L22	N 74°27'28" W	69.18'
L23	N 79°43'21" W	19.22'
L24	S 48°17'03" W	34.22'
L25	S 60°48'44" W	10.87'
L26	S 72°40'31" E	57.24'
L27	S 60°48'44" W	10.87'
L28	S 03°02'48" E	7.50'
L29	S 86°57'12" W	50.93'
L30	N 13°02'49" W	7.46'
L31	N 69°20'46" E	14.95'
L32	S 81°30'07" W	23.80'
L33	S 11°37'12" E	47.24'
L34	S 78°22'48" W	30.00'
L35	N 11°37'12" W	48.28'
L36	S 81°40'46" W	73.94'
L37	S 78°32'40" E	99.77'
L38	N 42°01'01" E	78.15'
L39	S 76°47'32" W	57.83'
L40	N 81°30'07" E	56.78'
L41	N 42°01'01" E	52.60'
L42	S 49°54'20" W	33.21'
L43	S 76°47'32" W	22.27'
L44	N 76°57'11" E	55.72'
L45	N 13°02'49" W	7.50'
L46	N 76°57'11" E	22.56'
L47	N 81°30'07" E	56.78'
L48	N 86°57'12" E	21.27'
L49	S 03°02'48" E	7.50'
L50	N 03°02'48" W	45.00'
L51	S 65°48'53" E	33.58'
L52	S 81°40'19" E	74.41'
L53	S 04°56'47" E	44.59'
L54	S 30°24'51" E	9.37'
L55	S 04°56'47" E	71.45'
L56	N 71°08'00" W	53.48'
L57	N 85°03'13" E	30.00'
L58	S 49°30'38" W	92.03'
L59	N 30°24'51" W	9.42'
L60	S 49°54'20" W	34.71'
L61	N 71°08'00" W	42.95'
L62	S 82°02'19" E	51.92'
L63	S 82°02'19" E	29.25'
L64	N 47°08'09" E	49.51'
L65	S 51°06'19" E	75.39'
L66	S 81°40'19" E	30.12'

LINE TABLE

SCALE= NTS

CURVE	RADIUS	ARC LENGTH	CHORD LENGTH	CHORD BEARING	DELTA ANGLE
C1	35.00'	8.51'	8.49'	N 49°41'54" E	13°55'32"
C2	65.00'	86.55'	80.30'	N 80°52'50" E	76°17'24"
C3	95.00'	91.10'	87.65'	S 74°19'12" E	54°56'30"
C4	95.00'	59.53'	58.56'	S 28°53'55" E	35°54'04"
C5	35.00'	55.93'	50.16'	S 56°43'25" E	91°33'04"
C6	65.00'	73.06'	69.27'	S 28°46'26" E	64°24'03"
C7	77.50'	80.39'	76.84'	N 71°44'16" E	59°26'08"
C8	222.50'	134.62'	132.58'	N 84°07'20" E	34°40'00"
C9	227.50'	60.68'	60.50'	S 58°44'49" E	15°17'00"
C10	272.50'	136.10'	134.69'	S 65°24'50" E	28°37'02"
C11	115.01'	32.81'	32.70'	S 38°57'45" W	16°20'46"
C12	227.50'	113.63'	112.45'	N 65°24'50" W	28°37'02"
C13	177.50'	38.83'	38.75'	S 54°32'45" W	12°31'58"
C14	177.50'	62.96'	62.63'	S 70°58'23" W	20°19'18"
C15	227.50'	60.68'	60.50'	N 74°01'49" W	15°17'00"
C16	189.20'	62.26'	61.98'	N 71°53'40" W	18°51'15"
C17	77.50'	91.86'	86.57'	S 80°13'50" W	67°54'35"
C18	222.50'	48.69'	48.59'	S 54°32'37" W	12°32'14"
C19	222.50'	23.21'	23.20'	S 63°48'02" W	5°58'36"
C20	165.00'	14.97'	14.96'	S 84°21'15" W	5°11'53"
C21	165.00'	13.83'	13.82'	S 79°21'15" W	4°48'08"
C22	343.13'	36.66'	36.64'	S 77°53'27" W	6°07'17"
C23	172.50'	100.27'	98.86'	S 60°07'22" W	33°18'13"
C24	123.49'	15.97'	15.96'	S 82°30'43" E	7°24'41"
C25	177.50'	62.96'	62.63'	S 88°42'19" E	20°19'18"
C26	123.49'	112.14'	108.33'	S 67°46'02" E	52°01'49"
C27	127.50'	42.32'	42.12'	N 71°59'40" E	19°00'56"
C28	127.50'	42.32'	42.12'	N 52°58'44" E	19°00'56"
C29	222.50'	17.67'	17.66'	N 79°13'39" E	4°32'56"
C30	135.00'	23.56'	23.53'	N 81°57'12" E	10°00'01"
C31	127.50'	35.29'	35.17'	S 73°44'36" E	15°51'27"
C32	122.50'	33.04'	32.94'	S 73°32'31" E	15°27'17"
C33	85.00'	37.78'	37.47'	S 17°40'49" E	25°28'04"
C34	122.50'	68.83'	67.93'	N 82°38'05" E	32°11'32"
C35	122.50'	13.25'	13.24'	N 49°22'25" E	6°11'45"
C36	115.00'	51.12'	50.70'	N 17°40'49" W	25°28'04"
C37	515.00'	45.79'	45.77'	N 49°40'58" E	5°05'39"
C38	465.00'	62.61'	62.56'	N 56°05'14" E	7°42'52"
C39	127.50'	5.15'	5.15'	S 80°52'50" E	2°18'58"
C40	272.50'	56.14'	56.04'	S 57°00'24" E	11°48'11"
C41	272.50'	89.24'	88.84'	S 72°17'25" E	18°45'49"

CURVE TABLE

SCALE= NTS

Project No:

543521

Drawing Title:

C-4.6 LINE AND CURVE TABLES

RICH MOUNTAIN PHASE 3

MAJOR SUBDIVISION

HENDERSON COUNTY

NORTH CAROLINA

PLANNING • ENGINEERING • SURVEYING

• ENVIRONMENTAL SERVICES •

Reviewed:  
JHK  
Drawn:  
ZAW  
Checked:  
JHK  
Date:  
12-15-2022No.  
1  
REVISIONS/SUBMISSIONS  
1 - HENDERSON COUNTY PLANNINGNo.  
1  
NORTH CAROLINA PROFESSIONAL ENGINEER  
*J.W. KENNARD, III*  
1CA1CB53248944  
SEAL  
NORTH CAROLINA  
CERTIFICATE #3125  
BROOKS  
ENGINEERING ASSOCIATES  
15 Arlington Street  
Asheville, NC 28801  
Phone: 1-828-232-4700  
Fax: 1-828-232-1331  
www.brooksea.comDate:  
12-15-2022

Revision Submission number within a triangle indicates changes made on this sheet

File Location: L:\2021\Projects\8-352\Rapier Falls Rich Mt. Due Diligence\DWG\Phase 3\CurveBase-543521\PHASE3.dwg

**Certificate Of Completion**

Envelope Id: 81AE4860D8A34EC28557150E11F833E2  
 Subject: Complete with DocuSign: 12-15-2022 Rich PH3 Planset.pdf  
 Source Envelope:  
 Document Pages: 23  
 Certificate Pages: 1  
 AutoNav: Enabled  
 Envelope Stamping: Enabled  
 Time Zone: (UTC-08:00) Pacific Time (US & Canada)

Status: Completed

Envelope Originator:  
 John Kinnaird  
 15 Arlington Street  
 nil  
 Asheville, NC 28801  
 jkinnaird@brooksea.com  
 IP Address: 68.115.175.82

**Record Tracking**

Status: Original 12/15/2022 10:10:36 AM	Holder: John Kinnaird jkinnaird@brooksea.com	Location: DocuSign
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**Signer Events**

John Kinnaird  
 jkinnaird@brooksea.com  
 Security Level: Email, Account Authentication  
 (None)

**Signature**

Signature Adoption: Pre-selected Style  
 Using IP Address: 68.115.175.82

**Timestamp**

Sent: 12/15/2022 10:14:32 AM  
 Viewed: 12/15/2022 10:16:00 AM  
 Signed: 12/15/2022 10:17:28 AM  
 Freeform Signing

**Electronic Record and Signature Disclosure:**

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In Person Signer Events	Signature	Timestamp
Editor Delivery Events	Status	Timestamp
Agent Delivery Events	Status	Timestamp
Intermediary Delivery Events	Status	Timestamp
Certified Delivery Events	Status	Timestamp
Carbon Copy Events	Status	Timestamp
Witness Events	Signature	Timestamp
Notary Events	Signature	Timestamp
Envelope Summary Events	Status	Timestamps
Envelope Sent	Hashed/Encrypted	12/15/2022 10:14:32 AM
Certified Delivered	Security Checked	12/15/2022 10:16:00 AM
Signing Complete	Security Checked	12/15/2022 10:17:28 AM
Completed	Security Checked	12/15/2022 10:17:28 AM
Payment Events	Status	Timestamps