




# HENDERSON COUNTY TOWER

## SITE ADDRESS (E-911 VERIFIED)

469 S FORGE CREST DR  
 MILLS RIVER, NC 28759  
 HENDERSON COUNTY  
 LATITUDE: 35° 21' 53.52" N  
 LONGITUDE: 82° 37' 12.10" W  
 TAX/PIN #: 9620-16-6829

**HENDERSON COUNTY SHERIFF'S OFFICE**  
 100 N GROVE ST  
 HENDERSONVILLE, NC 28792  
 PHONE: (828) 697-4596  
 ATTN.: CUSTOMER SERVICE

**MILLS RIVER VOLUNTEER FIRE**  
 121 SCHOOL HOUSE RD  
 MILLS RIVER, NC 28759  
 PHONE: (828) 891-7959  
 ATTN.: CUSTOMER SERVICE

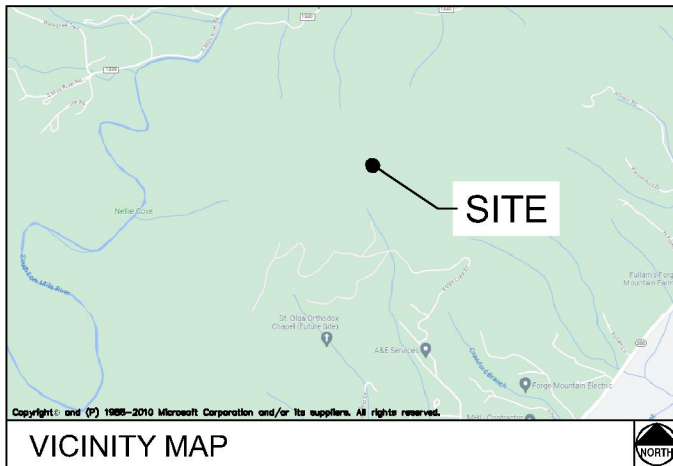

**JURISDICTION:**  
 HENDERSON COUNTY

**STATE:**  
 NORTH CAROLINA

**TOWER TYPE:**  
 MONOPOLE TOWER

**TOWER HEIGHT:**  
 150'

**NUMBER OF CARRIERS:**  
 1 EXISTING, 1 PROPOSED

**USE:**  
 EXISTING TELECOMMUNICATIONS TOWER  
 AND UNMANNED EQUIPMENT

**FLOOD INFO**  
 SITE IS LOCATED WITHIN FEMA FLOOD MAP  
 AREA 370096200J DATED 10/02/2008 WITHIN  
 FLOOD ZONE X.

PROJECT SUMMARY

**DEVELOPER**  
 HENDERSON COUNTY  
 2529 ASHEVILLE HIGHWAY  
 HENDERSONVILLE, NC 28791  
 PHONE: (828) 697-4728  
 FAX: (828) 698-6164  
 ATTN: JIMMY BRISSIE, DIRECTOR

**POWER COMPANY**  
 DUKE ENERGY PROGRESS  
 PHONE: (800) 653-5307  
 ATTN.: CUSTOMER SERVICE

**PROPERTY OWNER**  
 FULLAM FAMILY LIMITED PARTNERSHIP  
 40 FULLAM LN  
 MILLS RIVER, NC 28759  
 PHONE: N/A  
 ATTN.: CUSTOMER SERVICE

**CONSULTANT**  
 KIMLEY-HORN AND ASSOCIATES, INC.  
 11720 AMBER PARK DRIVE, SUITE 600  
 ALPHARETTA, GEORGIA 30009  
 PHONE: (678) 894-3618  
 ATTN.: CHRISTOPHER STRANGE

CONTACTS

| SHEET NO. | SHEET TITLE                          |
|-----------|--------------------------------------|
| T1        | COVER SHEET                          |
| T2        | APPENDIX B - BUILDING CODE SUMMARY   |
| --        | SITE SURVEY (SHEET 1 OF 1)           |
| N1        | GENERAL NOTES                        |
| C0        | OVERALL AERIAL PLAN                  |
| C1        | OVERALL PARCEL PLAN                  |
| C2        | EXISTING SITE PLAN                   |
| C3        | DEMO PLAN                            |
| C4        | SITE PLAN                            |
| C5        | EQUIPMENT PAD LAYOUT                 |
| C6        | CONCRETE PAD FOUNDATION DETAILS      |
| C7        | FENCE DETAILS                        |
| C8        | WAVEGUIDE BRIDGE DETAILS             |
| C9        | ANTENNA AND TOWER ELEVATION DETAILS  |
| C9.1      | TOWER EQUIPMENT SCHEDULE             |
| C9.2      | ANTENNA SPECS                        |
| C9.3      | ANTENNA SPECS                        |
| C10       | GRADING & EROSION CONTROL PLAN       |
| C10.1     | GRADING & EROSION CONTROL PLAN       |
| E1        | ELECTRICAL NOTES                     |
| E2        | OVERALL UTILITY SERVICE ROUTING PLAN |
| E2.1      | UTILITY SERVICE ROUTING PLAN         |
| E3        | ELECTRICAL DETAILS                   |
| E3.1      | METER RACK DETAILS                   |
| E4        | GROUNDING NOTES                      |
| E5        | GROUNDING PLAN                       |
| E6        | GROUNDING SINGLE LINE DIAGRAM        |
| E7        | GROUNDING DETAILS                    |
| E8        | GROUNDING DETAILS                    |

SHEET INDEX

HENDERSON COUNTY PLANNING DEPARTMENT  
 213 1ST AVE E  
 HENDERSONVILLE, NC 28792  
 PHONE: (828) 697-4819  
 ATTN.: CUSTOMER SERVICE

PERMIT INFORMATION



PROJECT INFORMATION:

SITE NAME:  
 HENDERSON COUNTY TOWER  
 SITE No.: 639642  
 PROJECT #: 20202154476  
 469 S FORGE CREST DR  
 MILLS RIVER, NC 28759  
 HENDERSON COUNTY

PLANS PREPARED BY:


**Kimley»Horn**

11720 AMBER PARK DRIVE, SUITE 600  
 ALPHARETTA, GA 30009  
 PHONE: 770-619-4280  
 WWW.KIMLEY-HORN.COM  
 NC License F-0102

REV: \_\_\_\_\_ DATE: \_\_\_\_\_ ISSUED FOR: \_\_\_\_\_ BY: \_\_\_\_\_

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| 0 | 01/10/24 | CONSTRUCTION | DRC |

LICENSER: \_\_\_\_\_

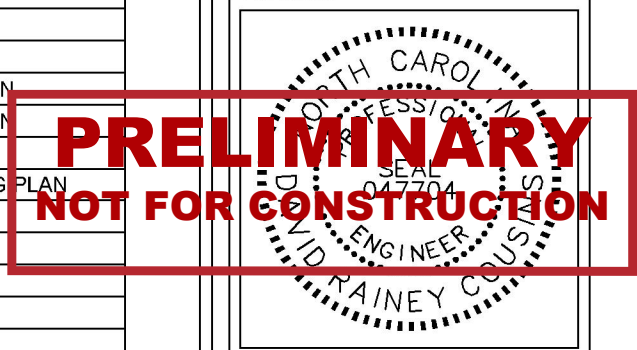

KHA PROJECT NUMBER:  
 017848000

DRAWN BY: \_\_\_\_\_ CHECKED BY: \_\_\_\_\_  
 XQD DMF

SHEET TITLE:  
 COVER SHEET

SHEET NUMBER:  
 T1

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2018 APPENDIX B
BUILDING CODE SUMMARY FOR ALL COMMERCIAL PROJECTS
(EXCEPT 1 AND 2-FAMILY DWELLINGS AND TOWNHOUSES)

Name of Project: HENDERSON COUNTY TOWER
Address: 469 S FORGE CREST DR, MILLS RIVER, NC
Owner/Authorized Agent: DAVID COUSINS

CONTACT: DAVID R. COUSINS, P.E. (#047704)
Table with columns: DESIGNER, FIRM, NAME, LICENSE #, TELEPHONE #, E-MAIL

2018 NC BUILDING CODE: [X] New Building [ ] Addition [ ] Renovation
2018 NC EXISTING BUILDING CODE: EXISTING: [ ] Prescriptive [ ] Repair [ ] Chapter 14

BASIC BUILDING DATA
Construction Type: [ ] I-A [ ] II-A [ ] III-A [ ] IV [ ] V-A
Sprinklers: [ ] No [ ] Partial [ ] Yes
Standpipes: [ ] No [ ] Yes Class [ ] I [ ] II [ ] III [ ] Wet [ ] Dry

Gross Building Area Table
Table with columns: FLOOR, EXISTING (SQ FT), NEW (SQ FT), SUB-TOTAL

ALLOWABLE AREA
Primary Occupancy Classification(s): Select one
Assembly [ ] A-1 [ ] A-2 [ ] A-3 [ ] A-4 [ ] A-5

Special Uses (Chapter 4 - List Code Sections):
Mixed Occupancy: [ ] No [ ] Yes
Non-Separated Use (508.3) - The required type of construction for the building shall be determined by applying the height and area limitations for each of the applicable occupancies to the entire building.

Table with columns: STORY NO., DESCRIPTION AND USE, (A) BLDG AREA PER STORY (ACTUAL), (B) TABLE 506.2 AREA, (C) AREA FOR FRONTAGE INCREASE<sup>1,5</sup>, (D) ALLOWABLE AREA PER STORY OR UNLIMITED<sup>2,3</sup>

Frontage area increases from Section 506.2 are computed thus:
a. Perimeter which fronts a public way or open space having 20 feet minimum width = (F)
b. Total Building Perimeter = (P)
c. Ratio (F/P) = (F/P)
d. W = Minimum width of public way = (W)
e. Percent of frontage increase I<sub>f</sub> = 100[(F/P) - 0.25] x W/30 = (%)

ALLOWABLE HEIGHT
Table with columns: ALLOWABLE, SHOWN ON PLANS, CODE REFERENCE

FIRE PROTECTION REQUIREMENTS

Table with columns: BUILDING ELEMENT, FIRE SEPARATION DISTANCE (FEET), RATING, DETAIL # AND SHEET #, DESIGN # FOR RATED ASSEMBLY, SHEET # FOR RATED PENETRATION, SHEET # FOR RATED JOINTS

PERCENTAGE OF WALL OPENING CALCULATIONS

Table with columns: FIRE SEPARATION DISTANCE (FEET) FROM PROPERTY LINES, DEGREE OF OPENINGS PROTECTION (TABLE 705.8), ALLOWABLE AREA (%), ACTUAL SHOWN ON PLANS (%)

LIFE SAFETY SYSTEM REQUIREMENTS

Emergency Lighting: [ ] No [ ] Yes
Exit Signs: [ ] No [ ] Yes
Fire Alarm: [ ] No [ ] Yes
Smoke Detection Systems: [ ] No [ ] Yes [ ] Partial

LIFE SAFETY PLAN REQUIREMENTS

Life Safety Plan Sheet #:
[ ] Fire and/or smoke rated wall locations (Chapter 4)
[ ] Assumed and real property line locations (if not on the site plan)
[ ] Exterior wall opening area with respect to distance to assumed property lines (705.8)

ACCESSIBLE DWELLING UNITS (SECTION 1107)

Table with columns: TOTAL UNITS, ACCESSIBLE UNITS REQUIRED, ACCESSIBLE UNITS PROVIDED, TYPE A UNITS REQUIRED, TYPE A UNITS PROVIDED, TYPE B UNITS REQUIRED, TYPE B UNITS PROVIDED, TOTAL ACCESSIBLE UNITS PROVIDED

ACCESSIBLE PARKING (SECTION 1106)

Table with columns: LOT OR PARKING AREA, TOTAL # OF PARKING SPACES REQUIRED, # OF ACCESSIBLE SPACES PROVIDED, TOTAL # ACCESSIBLE UNITS PROVIDED

PLUMBING FIXTURE REQUIREMENTS (TABLE 2902.1)

Table with columns: USE, WATERCLOSETS, URINALS, LAVATORIES, SHOWERS, DRINKING FOUNTAINS

SPECIAL APPROVALS

Special approval: Local Jurisdiction, Department of Insurance, OSC, DPI, DHHS, etc., describe below

ENERGY SUMMARY

The following data shall be considered minimum and any special attribute required to meet the energy code shall also be provided. Each Designer shall furnish the required portions of the project information for the plan data sheet.

Exempt Building: [ ] No [ ] Yes (Provide code or statutory reference):
Climate Zone: [ ] 3A [ ] 4A [ ] 5A
Method of Compliance: Energy Code [ ] Performance [ ] Prescriptive

THERMAL ENVELOPE (Prescriptive method only)

Roof/Ceiling Assembly (each assembly)
Description of assembly:
U-Value of total assembly:
R-Value of insulation:
Skylights in each assembly:
U-Value of skylight:
total square footage of skylights in each assembly:
Exterior Walls (each assembly)
Description of assembly:
U-Value of total assembly:
R-Value of insulation:
Openings (windows or doors with glazing)
U-Value of assembly:
Solar heat gain coefficient:
projection factor:
Door R-Values:

Walls below grade (each assembly)

Description of assembly:
U-Value of total assembly:
R-Value of insulation:

Floors over unconditioned space (each assembly)

Description of assembly:
U-Value of total assembly:
R-Value of insulation:

Floors slab on grade

Description of assembly:
U-Value of total assembly:
R-Value of insulation:
Horizontal/vertical requirement:
slab heated:

NOTE: SCOPE OF WORK INCLUDES INSTALLATION OF CAST IN PLACE CONCRETE PADS. NO NEW BUILDING BEING CONSTRUCTED.

2018 APPENDIX B BUILDING CODE SUMMARY FOR ALL COMMERCIAL PROJECTS STRUCTURAL DESIGN

DESIGN LOADS:
Importance Factors: Snow (ls) Seismic (I<sub>e</sub>)
Live Loads: Roof psf Mezzanine psf Floor psf

Ground Snow Load: psf
Wind Load: Basic Wind Speed mph (ASCE-7) Exposure Category

SEISMIC DESIGN CATEGORY: [ ] A [ ] B [ ] C [ ] D
Provide the following Seismic Design Parameters: Risk Category (Table 1604.5) [ ] I [ ] II [ ] III [ ] IV Spectral Response Acceleration S<sub>s</sub>, %g Site Classification (ASCE 7) [ ] A [ ] B [ ] C [ ] D [ ] E [ ] F

Basic structural system: [ ] Bearing Wall [ ] Dual w/Special Moment Frame [ ] Building Frame [ ] Dual w/Intermediate R/C or Special Steel [ ] Moment Frame [ ] Inverted Pendulum
Analysis Procedure: [ ] Simplified [ ] Equivalent Lateral Force [ ] Dynamic
Architectural, Mechanical, Components anchored? [ ] Yes [ ] No

LATERAL DESIGN CONTROL: Earthquake [ ] Wind [ ]

SOIL BEARING CAPACITIES:
Field Test (provide copy of test report) psf
Presumptive Bearing capacity psf
Pile size, type, and capacity

2018 APPENDIX B BUILDING CODE SUMMARY FOR ALL COMMERCIAL PROJECTS MECHANICAL DESIGN

MECHANICAL SUMMARY
MECHANICAL SYSTEMS, SERVICE SYSTEMS AND EQUIPMENT

Thermal Zone: winter dry bulb: summer dry bulb:

Interior design conditions: winter dry bulb: summer dry bulb: relative humidity:
Building heating load:
Building cooling load:

Mechanical Spacing Conditioning System
Unitary: description of unit: heating efficiency: cooling efficiency: size category of unit:
Boiler: Size category. If oversized, state reason:
Chiller: Size category. If oversized, state reason:
List equipment efficiencies:

2018 APPENDIX B BUILDING CODE SUMMARY FOR ALL COMMERCIAL PROJECTS ELECTRICAL DESIGN

ELECTRICAL SUMMARY
ELECTRICAL SYSTEM AND EQUIPMENT

Method of Compliance: Energy Code [ ] Performance [ ] Prescriptive ASHRAE 90.1 [ ] Performance [ ] Prescriptive

Lighting schedule (each fixture type)
lamp type required in fixture
number of lamps in fixture
ballast type used in the fixture
number of ballasts in fixture
total wattage per fixture
total interior wattage specified vs. allowed (whole building or space by space)
total exterior wattage specified vs. allowed


Additional Efficiency Package Options (When using the 2018 ASCEC; not required for ASHRAE 90.1)
[ ] C406.2 More Efficient HVAC Equipment Performance
[ ] C406.3 Reduced Lighting Power Density
[ ] C406.4 Enhanced Digital Lighting Controls
[ ] C406.5 On-Site Renewable Energy
[ ] C406.6 Dedicated Outdoor Air System
[ ] C406.7 Reduced Energy Use in Service Water Heating



PROJECT INFORMATION:
SITE NAME: HENDERSON COUNTY TOWER
SITE No.: 639642
PROJECT #: 20202154476
469 S FORGE CREST DR MILLS RIVER, NC 28759 HENDERSON COUNTY

PLANS PREPARED BY:
Kimley Horn
11720 AMBER PARK DRIVE, SUITE 600 ALPHARETTA, GA 30009 PHONE: 770-619-4280 WWW.KIMLEY-HORN.COM NC License F-0102

Table with columns: REV, DATE, ISSUED FOR
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0 01/10/24 CONSTRUCTION DRC

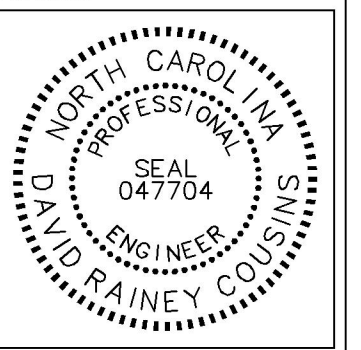

KHA PROJECT NUMBER: 017848000
DRAWN BY: XQD CHECKED BY: DMF

SHEET TITLE: APPENDIX B - BUILDING CODE SUMMARY

SHEET NUMBER: T2

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**1.00 GENERAL NOTES**

- 1.01 ALL MATERIALS AND WORKMANSHIP SHALL CONFORM TO THE DRAWINGS AND SPECIFICATIONS. ALL WORK SHALL BE DONE IN ACCORDANCE WITH THE LATEST EDITION OF THE STATE, LOCAL AND NATIONAL CODES, ORDINANCES AND OR REGULATIONS APPLICABLE TO THIS PROJECT.
- 1.02 THE CONTRACTOR SHALL BE RESPONSIBLE FOR COORDINATING THE WORK OF ALL TRADES AND SHALL CHECK ALL DIMENSIONS. ALL DISCREPANCIES SHALL BE CALLED TO THE ATTENTION OF THE PROJECT MANAGER AND/OR ENGINEER AND BE RESOLVED BEFORE PROCEEDING WITH WORK. WHERE THERE IS A CONFLICT BETWEEN DRAWING AND VERIZON SPECIFICATIONS, THE VERIZON PROJECT ENGINEER SHOULD BE CONTACTED FOR CLARIFICATION.
- 1.03 ALL INFORMATION SHOWN ON THE DRAWINGS RELATIVE TO EXISTING CONDITIONS IS GIVEN AS THE BEST PRESENT KNOWLEDGE, BUT WITHOUT GUARANTEE OF ACCURACY. WHERE ACTUAL CONDITIONS CONFLICT WITH THE DRAWINGS, THEY SHALL BE REPORTED TO THE PROJECT MANAGER AND/OR ENGINEER SO THAT PROPER REVISIONS MAY BE MADE. MODIFICATION OF DETAILS OF CONSTRUCTION SHALL NOT BE MADE WITHOUT WRITTEN APPROVAL OF THE PROJECT MANAGER AND/OR ENGINEER.
- 1.04 CONTRACTOR SHALL REVIEW AND BE FAMILIAR WITH SITE CONDITIONS AS SHOWN ON THE ATTACHED SITE PLAN AND/OR SURVEY DRAWINGS.
- 1.05 WAVEGUIDE BRIDGE AND EQUIPMENT CABINETS ARE SHOWN FOR REFERENCE ONLY. REFER TO SEPARATE DRAWINGS FOR SPECIFIC INFORMATION.
- 1.06 ALL FINISHED GRADES SHALL SLOPE MINIMUM 1/4 IN./FT. AWAY FROM EQUIPMENT IN ALL DIRECTIONS. CONTRACTOR SHALL SLOPE SWALES AS REQUIRED ALONG EXISTING TERRAIN TO DRAIN AWAY FROM COMPOUND AND ACCESS DRIVE.
- 1.07 THE EXISTING TOWER AND TOWER FOUNDATIONS WERE DESIGNED BY OTHERS. TOWER INFORMATION PROVIDED ON THESE PLANS ARE PROVIDED FOR REFERENCE PURPOSES ONLY. NOTIFY ENGINEER OR PROJECT MANAGER OF ANY CONFLICTS OR DISCREPANCIES. CONTRACTOR TO OBTAIN COPY OF STRUCTURAL ANALYSIS, IF AVAILABLE, FROM VERIZON PROJECT MANAGER TO CONFIRM COAX ROUTING AND ANTENNA MOUNT INFORMATION.
- 1.08 THE CONTRACTOR SHALL PROVIDE ADEQUATE EXCAVATION SLOPING, SHORING, BRACING, AND GUYS IN ACCORDANCE WITH ALL NATIONAL, STATE, AND LOCAL SAFETY ORDINANCES.
- 1.09 UPON COMPLETION OF CONSTRUCTION, CONTRACTOR IS RESPONSIBLE FOR REPAIRING ANY DAMAGE CAUSED BY CONSTRUCTION ACTIVITIES TO THE EXISTING ACCESS ROAD AND COMPOUND GRAVEL AREAS. ANY NEW FILL MATERIALS SHALL BE COMPACTED.
- 1.10 THE CONTRACTOR IS HEREBY NOTIFIED THAT PRIOR TO COMMENCING CONSTRUCTION, HE IS RESPONSIBLE FOR CONTACTING THE UTILITY COMPANIES INVOLVED AND SHALL REQUEST A VERIFICATION AT THE CONSTRUCTION SITE OF THE LOCATIONS OF THEIR UNDERGROUND UTILITIES AND WHERE THEY MAY POSSIBLY CONFLICT WITH THE PLACEMENT OF IMPROVEMENTS AS SHOWN ON THESE PLANS. THE CONTRACTOR OR ANY SUBCONTRACTOR FOR THIS CONTRACT WILL BE REQUIRED TO NOTIFY "NORTH CAROLINA 811" 48 HOURS IN ADVANCE OF PERFORMING ANY WORK BY CALLING THE TOLL FREE NUMBER (800) 632-4949 (OR 811). ANY UTILITIES DAMAGED BY CONSTRUCTION ACTIVITIES SHALL BE REPAIRED BY THE CONTRACTOR, AT NO EXPENSE TO THE OWNER.
- 1.11 CONTRACTOR SHALL TAKE EXTREME CAUTION WHEN CONSTRUCTING WAVEGUIDE FOOTINGS SO AS TO NOT DAMAGE THE EXISTING TOWER GROUNDING RING. IF THE EXISTING RING BECOMES DAMAGED DURING CONSTRUCTION, THE CONTRACTOR SHALL BE RESPONSIBLE FOR THE REPAIR AND/OR REPLACEMENT OF THE TOWER GROUNDING RING AS DEEMED APPROPRIATE BY VERIZON.
- 1.12 CONTRACTOR TO PROVIDE DUMPSTER AND PORTABLE TOILET FACILITY DURING CONSTRUCTION.

**2.00 EQUIPMENT FOUNDATION NOTES**

- 2.01 FOUNDATIONS ARE DESIGNED FOR A PRESUMPTIVE ALLOWABLE SOIL BEARING CAPACITY OF 2,000 PSF. CONTRACTOR SHALL VERIFY SOIL CONDITIONS AND BEARING CAPACITY PRIOR TO CONSTRUCTION.
- 2.02 EXCAVATE A MINIMUM 18" BELOW PROPOSED EQUIPMENT FOUNDATIONS OF EXPANSIVE, ORGANIC, UNCONSOLIDATED OR OTHERWISE UNACCEPTABLE MATERIAL AND REPLACE WITH WELL-COMPACTED MATERIAL ACCEPTABLE TO VERIZON.
- 2.03 CONTRACTOR SHALL BE RESPONSIBLE FOR LOCATING, PROTECTING, AND RELOCATING AS REQUIRED ALL SERVICE AND UTILITY LINES IN VICINITY OF THE WORK SITE. ALL EXCAVATIONS NEAR THESE LINES TO BE CARRIED OUT WITH EXTREME CAUTION. COORDINATE ALL RELOCATIONS WITH THE PROPERTY OWNER.
- 2.04 CONTRACTOR TO CUT/FILL EXISTING COMPOUND SUBSOIL TO PROVIDE AN AREA AS LEVEL AS POSSIBLE FOR THE EQUIPMENT FOUNDATIONS. ALL FILL AREAS ARE TO BE FILLED WITH SUITABLE MATERIALS. FILL MATERIALS ARE TO BE PLACED, COMPACTED, AND TESTED IN MAXIMUM LAYERS OF 8". COMPACTION OF ALL FILL MATERIAL SHALL ACHIEVE 95 PERCENT OF MAXIMUM DRY DENSITY AT OPTIMUM MOISTURE CONTENT IN ACCORDANCE WITH ASTM D 698. ALL TESTS MUST MEET THE MINIMUM SPECIFIED SOIL BEARING CAPACITY. COMPACTION TESTING IS BY THE GEOTECHNICAL TESTING COMPANY DESIGNATED FOR THE PROJECT. SCHEDULING AND COORDINATION IS THE RESPONSIBILITY OF THE GENERAL CONTRACTOR. REPORTS OF ALL TESTING ARE TO BE PROMPTLY DELIVERED OR FAXED TO THE VERIZON WIRELESS PROJECT MANAGER.
- 2.05 CONCRETE SHALL HAVE A MINIMUM COMPRESSIVE STRENGTH OF 4,000 PSI AT 28 DAYS AND SHALL BE INSTALLED IN ACCORDANCE WITH THE LATEST REVISION TO ACI-318 BUILDING CODE REQUIREMENTS FOR REINFORCED CONCRETE.
- 2.06 CONCRETE SHALL HAVE A SLUMP BETWEEN 3" AND 6".
- 2.07 FIBERS FOR CONCRETE SHALL BE FIBERMESH 650, 100 PERCENT VIRGIN POLYPROPYLENE FIBRILLATED FIBERS, e3 PATENTED TECHNOLOGY PATENTED TECHNOLOGY, CONTAINING NO REPROCESSED OLEFIN MATERIALS. THE FIBERS SHALL CONFORM TO ASTM C1116 TYPE III AND MANUFACTURED SPECIFICALLY FOR THE SECONDARY REINFORCEMENT OF CONCRETE.
- 2.08 THE FIBERS SHALL BE MANUFACTURED IN AN ISO 9001:2008 CERTIFIED MANUFACTURING FACILITY. UNLESS OTHERWISE STATED, FIBERMESH 650 MACRO-SYNTHETIC FIBERS SHALL BE ADDED TO THE CONCRETE AT THE BATCHING PLANT AT THE RECOMMENDED APPLICATION RATE OF 3 LBS/YD<sup>3</sup> AND MIXED FOR A SUFFICIENT TIME (MINIMUM 5 MINUTES AT FULL MIXING SPEED) TO ENSURE UNIFORM DISTRIBUTION OF THE FIBERS THROUGHOUT THE CONCRETE. FIBROUS CONCRETE REINFORCEMENT SHALL BE MANUFACTURED BY FIBERMESH, 4019 INDUSTRY DRIVE, CHATTANOOGA, TN 37416 USA, TEL: 800 621-1273, WEBSITE: WWW.FIBERMESH.COM
- 2.09 AT THE REQUEST OF THE VERIZON WIRELESS PROJECT MANAGER, TEST CYLINDERS SHALL BE MOLDED AND LABORATORY CURED IN ACCORDANCE WITH ASTM C31. THREE CYLINDERS SHALL BE TAKEN FOR EACH DAY'S CONCRETE PLACEMENT. CYLINDERS SHALL BE TESTED IN ACCORDANCE WITH THE LATEST REVISION TO ASTM C39.
- 2.10 CHAMFER ALL EXPOSED EXTERNAL CORNERS OF CONCRETE WITH 3/4" x 45° CHAMFER, UNLESS OTHERWISE NOTED.
- 2.11 CONCRETE FORMWORK IS TO BE STRIPPED WITHIN 48 HOURS. VIBRATION OF THE CONCRETE MUST ASSURE THAT HONEYCOMBING WILL BE AT A MINIMUM. MECHANICAL VIBRATION OF ALL CONCRETE IS REQUIRED UNLESS OTHERWISE DIRECTED BY VERIZON WIRELESS' PROJECT MANAGER. ABOVE GRADE CONCRETE IS TO BE RUBBED AND PATCHED TO ASSURE SMOOTH FINISH AT TIME OF FORMS REMOVAL. CONTRACTOR SHALL PROVIDE A BROOM FINISH ON THE TOP SURFACE OF THE EQUIPMENT FOUNDATION UNLESS OTHERWISE DIRECTED BY VERIZON WIRELESS' PROJECT MANAGER.
- 2.12 TOPS OF CONCRETE FOUNDATION MUST BE WITHIN 0.02' OF ELEVATION REQUIRED.
- 2.13 TOP OF FOUNDATION FINISH TO BE LEVEL ±1/8" IN 10'.
- 2.14 TOP OF FOUNDATION TO HAVE MEDIUM BROOM FINISH.
- 2.15 CONTRACTOR SHALL REFER TO DRAWINGS OF OTHER TRADES AND VENDOR DRAWINGS FOR EMBEDDED ITEMS AND RECESSES NOT SHOWN ON THE STRUCTURAL DRAWINGS. CONTRACTOR SHALL VERIFY PLACEMENT OF EQUIPMENT AND LOCATION OF CONDUIT FOR MANUFACTURER'S AND VENDORS SPECIFICATIONS. IT SHALL BE THE RESPONSIBILITY OF THE CONTRACTOR TO PROVIDE ALL OPENINGS AND SLEEVES FOR PROPER DISTRIBUTION OF ALL UTILITIES.




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 HENDERSON COUNTY

PLANS PREPARED BY:


**Kimley»Horn**

11720 AMBER PARK DRIVE, SUITE 600  
 ALPHARETTA, GA 30009  
 PHONE: 770-619-4280  
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| 0 | 01/10/24 | CONSTRUCTION | DRC |

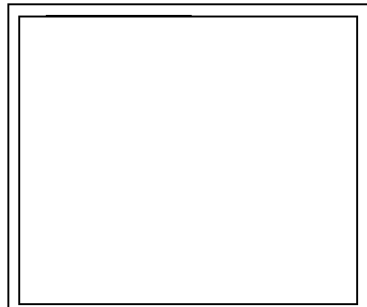

KHA PROJECT NUMBER:

017848000

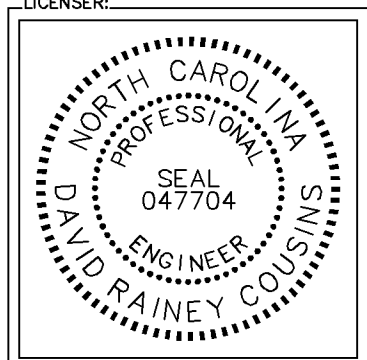DRAWN BY: \_\_\_\_\_ CHECKED BY: \_\_\_\_\_

XQD      DMF


SHEET TITLE:

**GENERAL NOTES**

SHEET NUMBER:

**N1**

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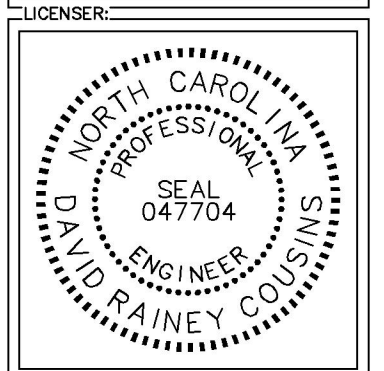
**1** OVERALL AERIAL PLAN  
**C0** SCALE: 1" = 1,500'

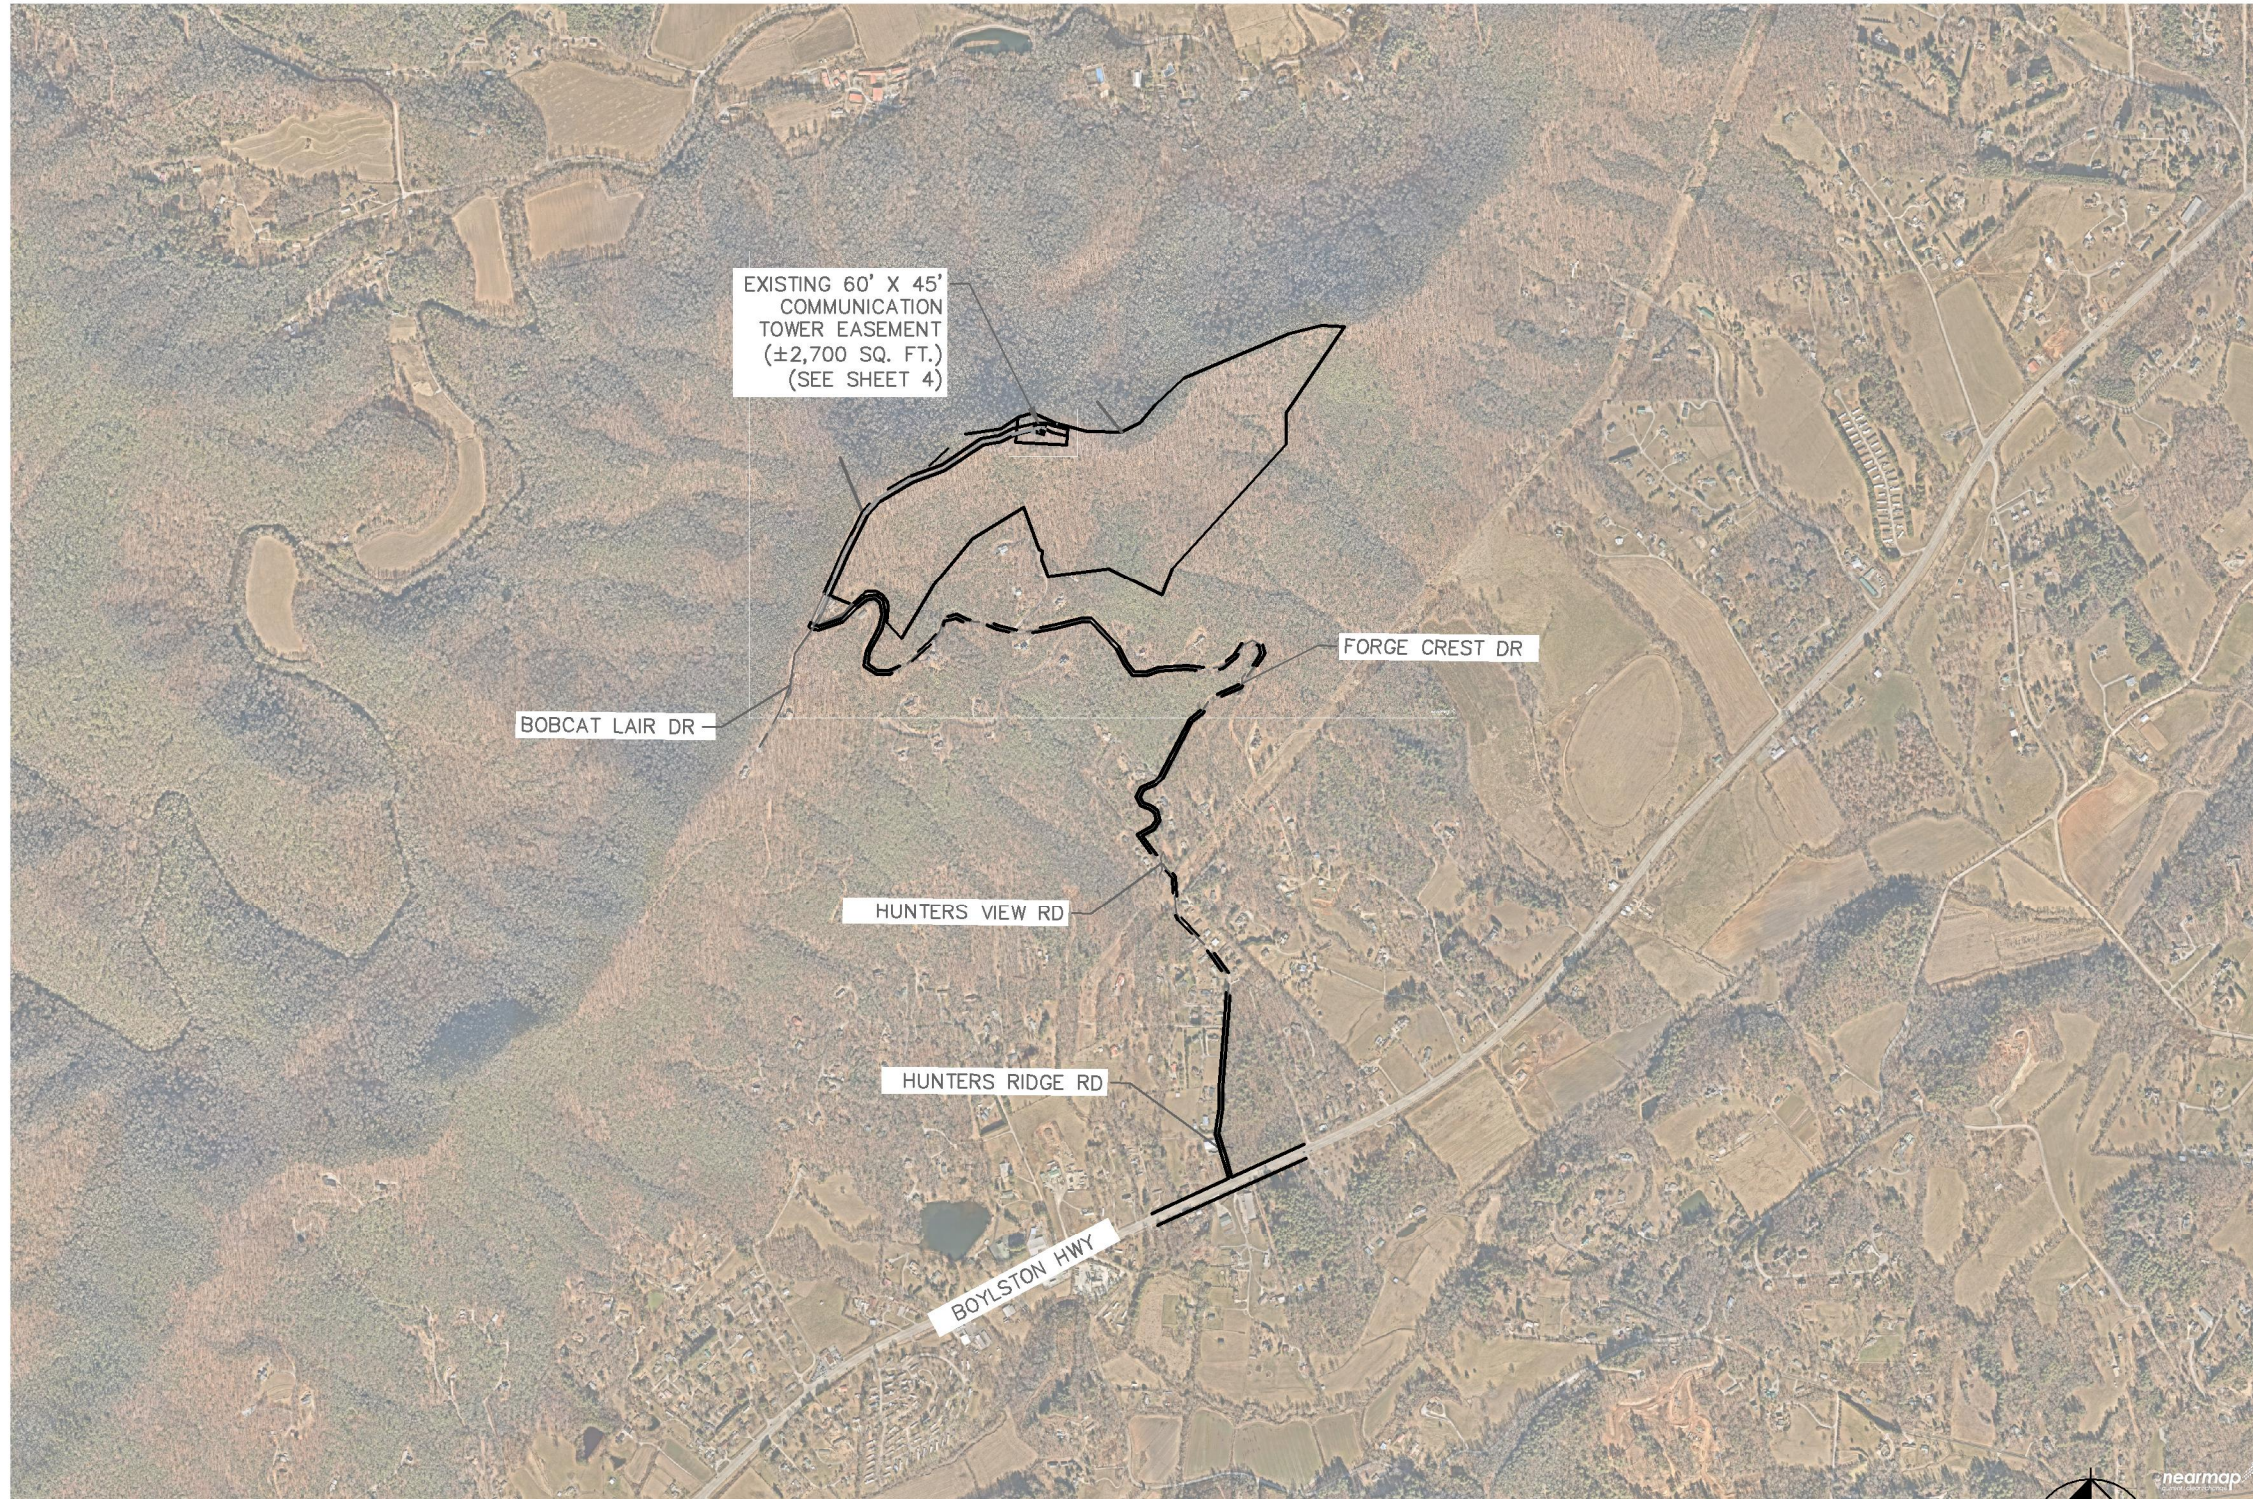

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 WWW.KIMLEY-HORN.COM  
 NC License F-0102

| REV. | DATE     | ISSUED FOR   | BY  |
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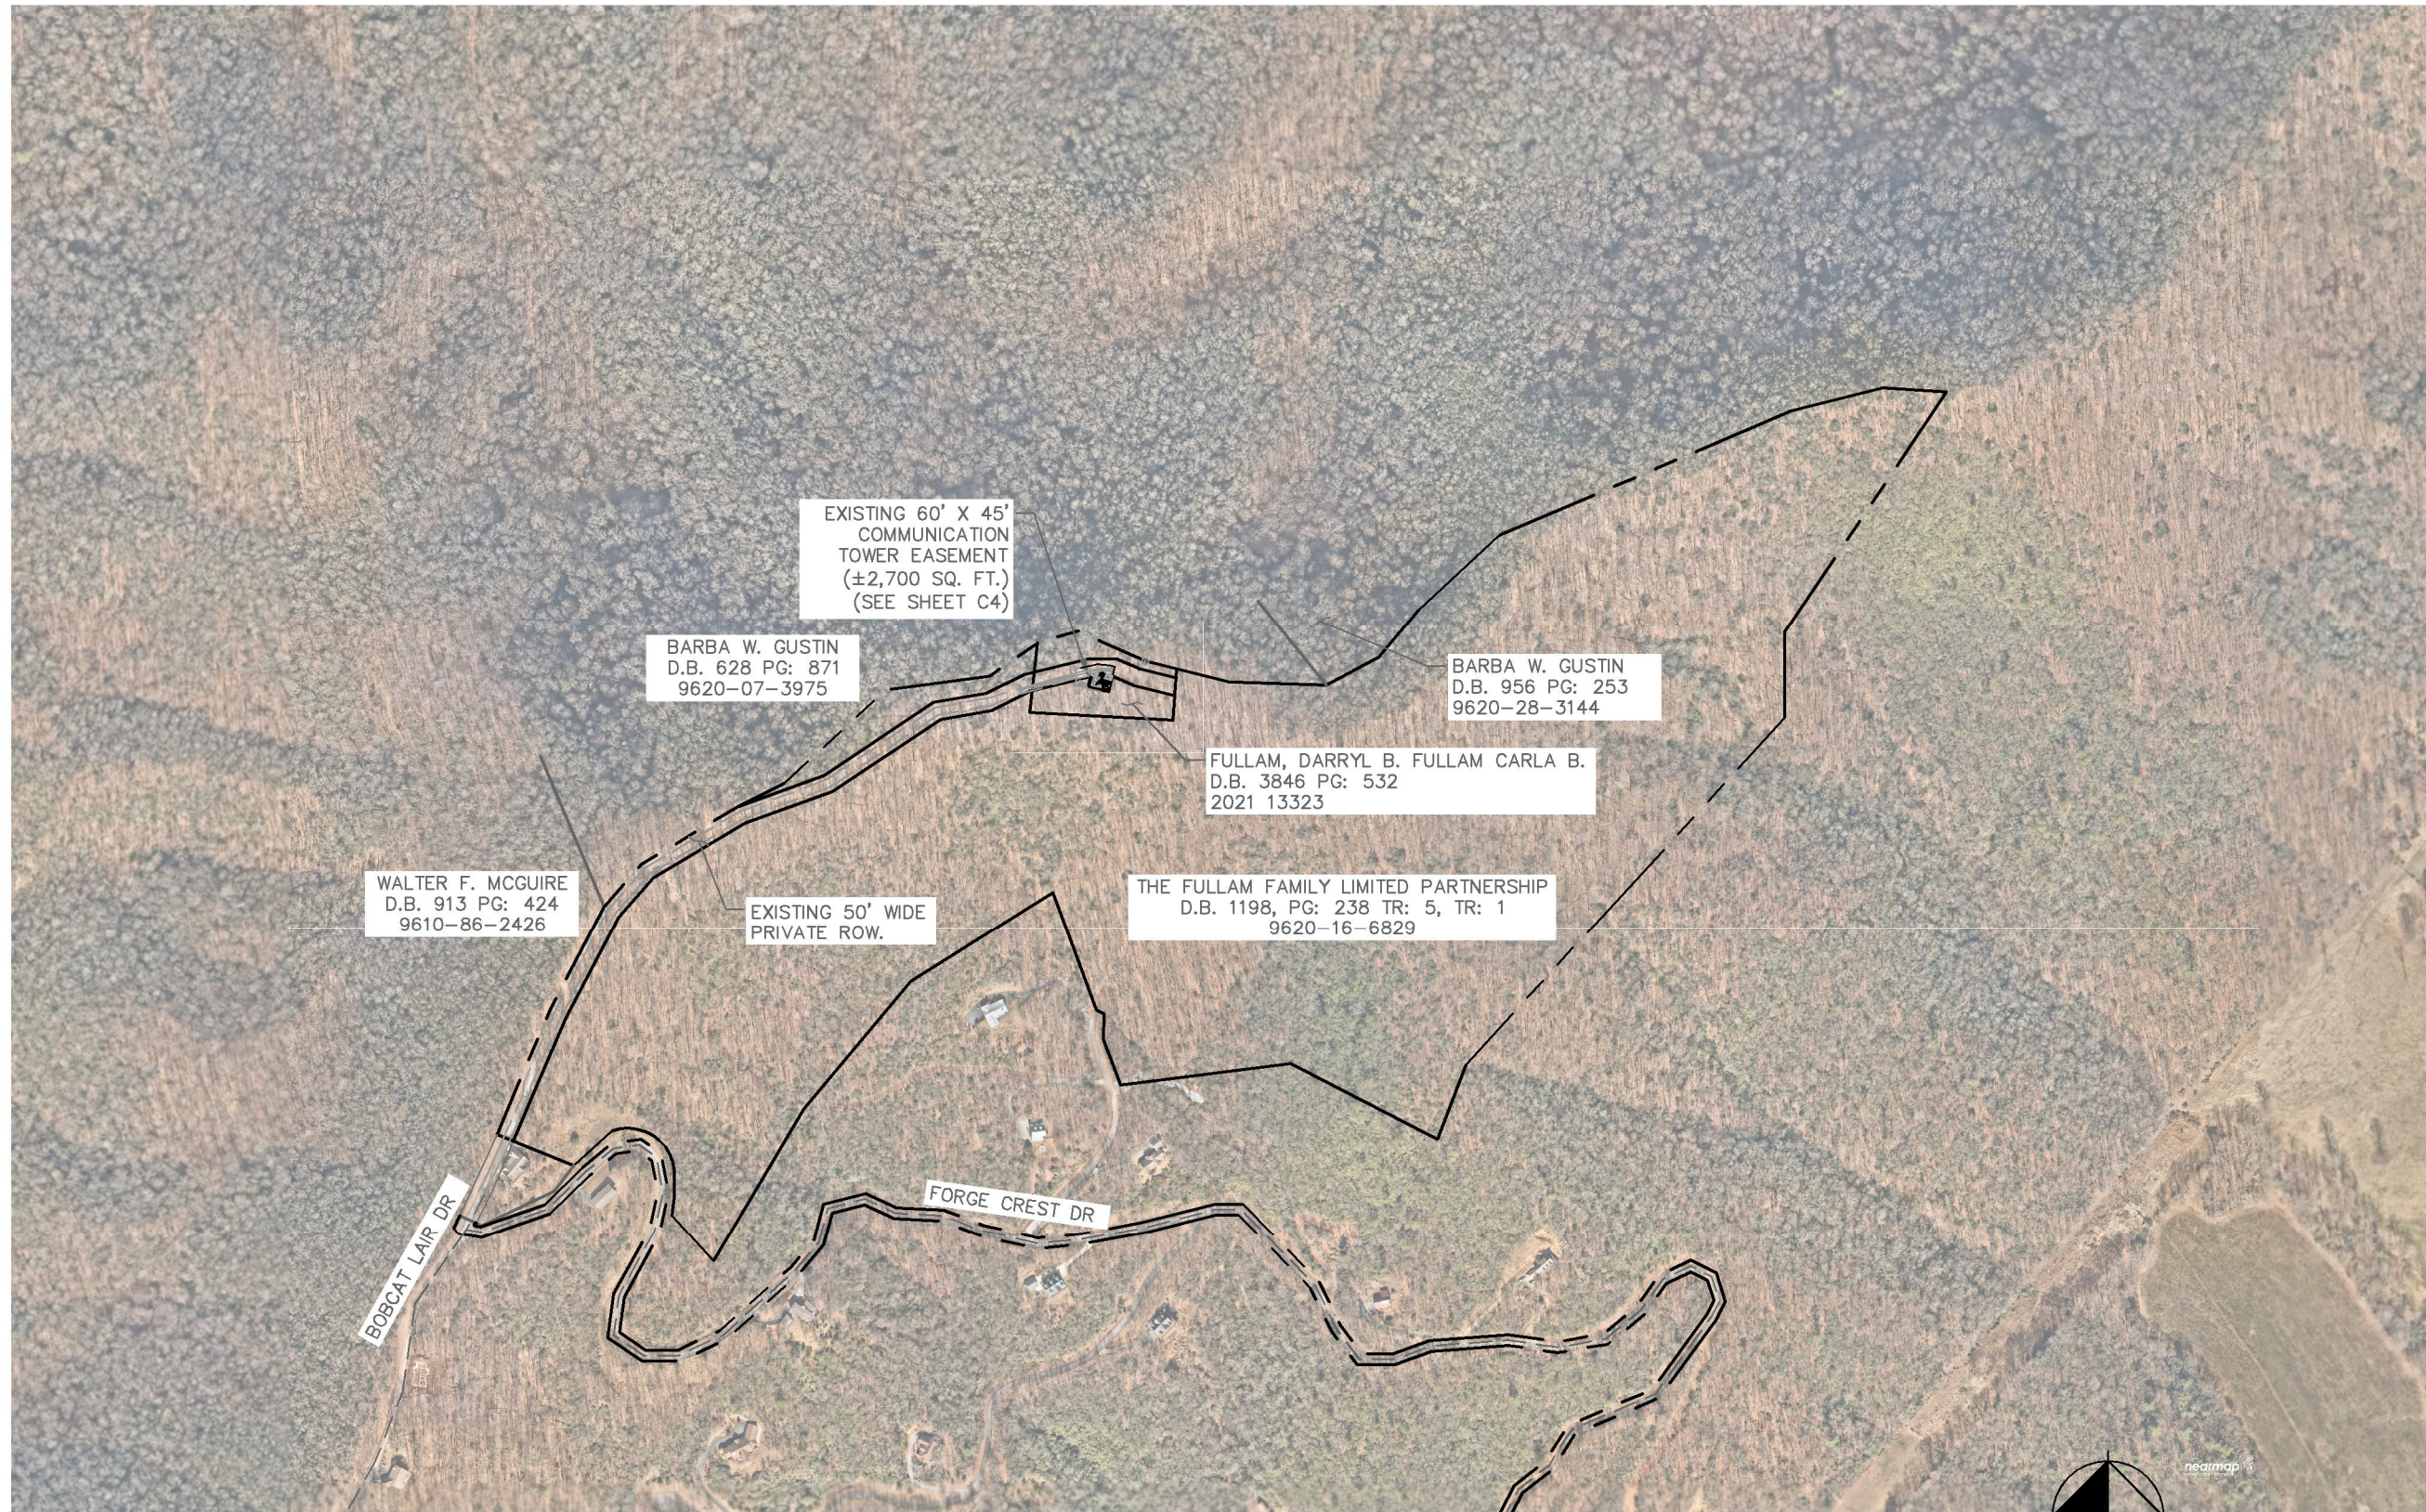
KHA PROJECT NUMBER:  
 017848000

DRAWN BY: XQD CHECKED BY: DMF

SHEET TITLE:  
**OVERALL AERIAL PLAN**

SHEET NUMBER:  
**C0**

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1 OVERALL PARCEL PLAN  
C1 SCALE: 1" = 500'




PROJECT INFORMATION:  
SITE NAME:  
HENDERSON COUNTY TOWER  
SITE No.: 639642  
PROJECT #: 20202154476  
469 S FORGE CREST DR  
MILLS RIVER, NC 28759  
HENDERSON COUNTY

PLANS PREPARED BY:  
**Kimley»Horn**  
11720 AMBER PARK DRIVE, SUITE 600  
ALPHARETTA, GA 30009  
PHONE: 770-619-4280  
WWW.KIMLEY-HORN.COM  
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REV: \_\_\_\_\_ DATE: \_\_\_\_\_ ISSUED FOR: \_\_\_\_\_ BY: \_\_\_\_\_

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| 0 | 01/10/24 | CONSTRUCTION | DRC |

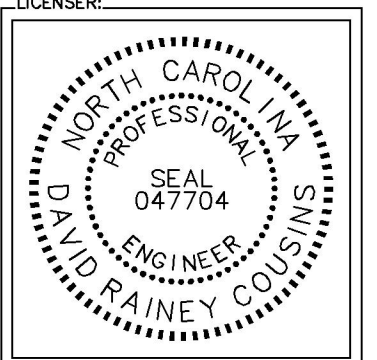

KHA PROJECT NUMBER:  
017848000  
DRAWN BY: XQD CHECKED BY: DMF

SHEET TITLE:  
**OVERALL PARCEL PLAN**

SHEET NUMBER:  
C1

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**1** EXISTING SITE PLAN  
**C2** SCALE: 1" = 50'




PROJECT INFORMATION:  
 SITE NAME:  
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 469 S FORGE CREST DR  
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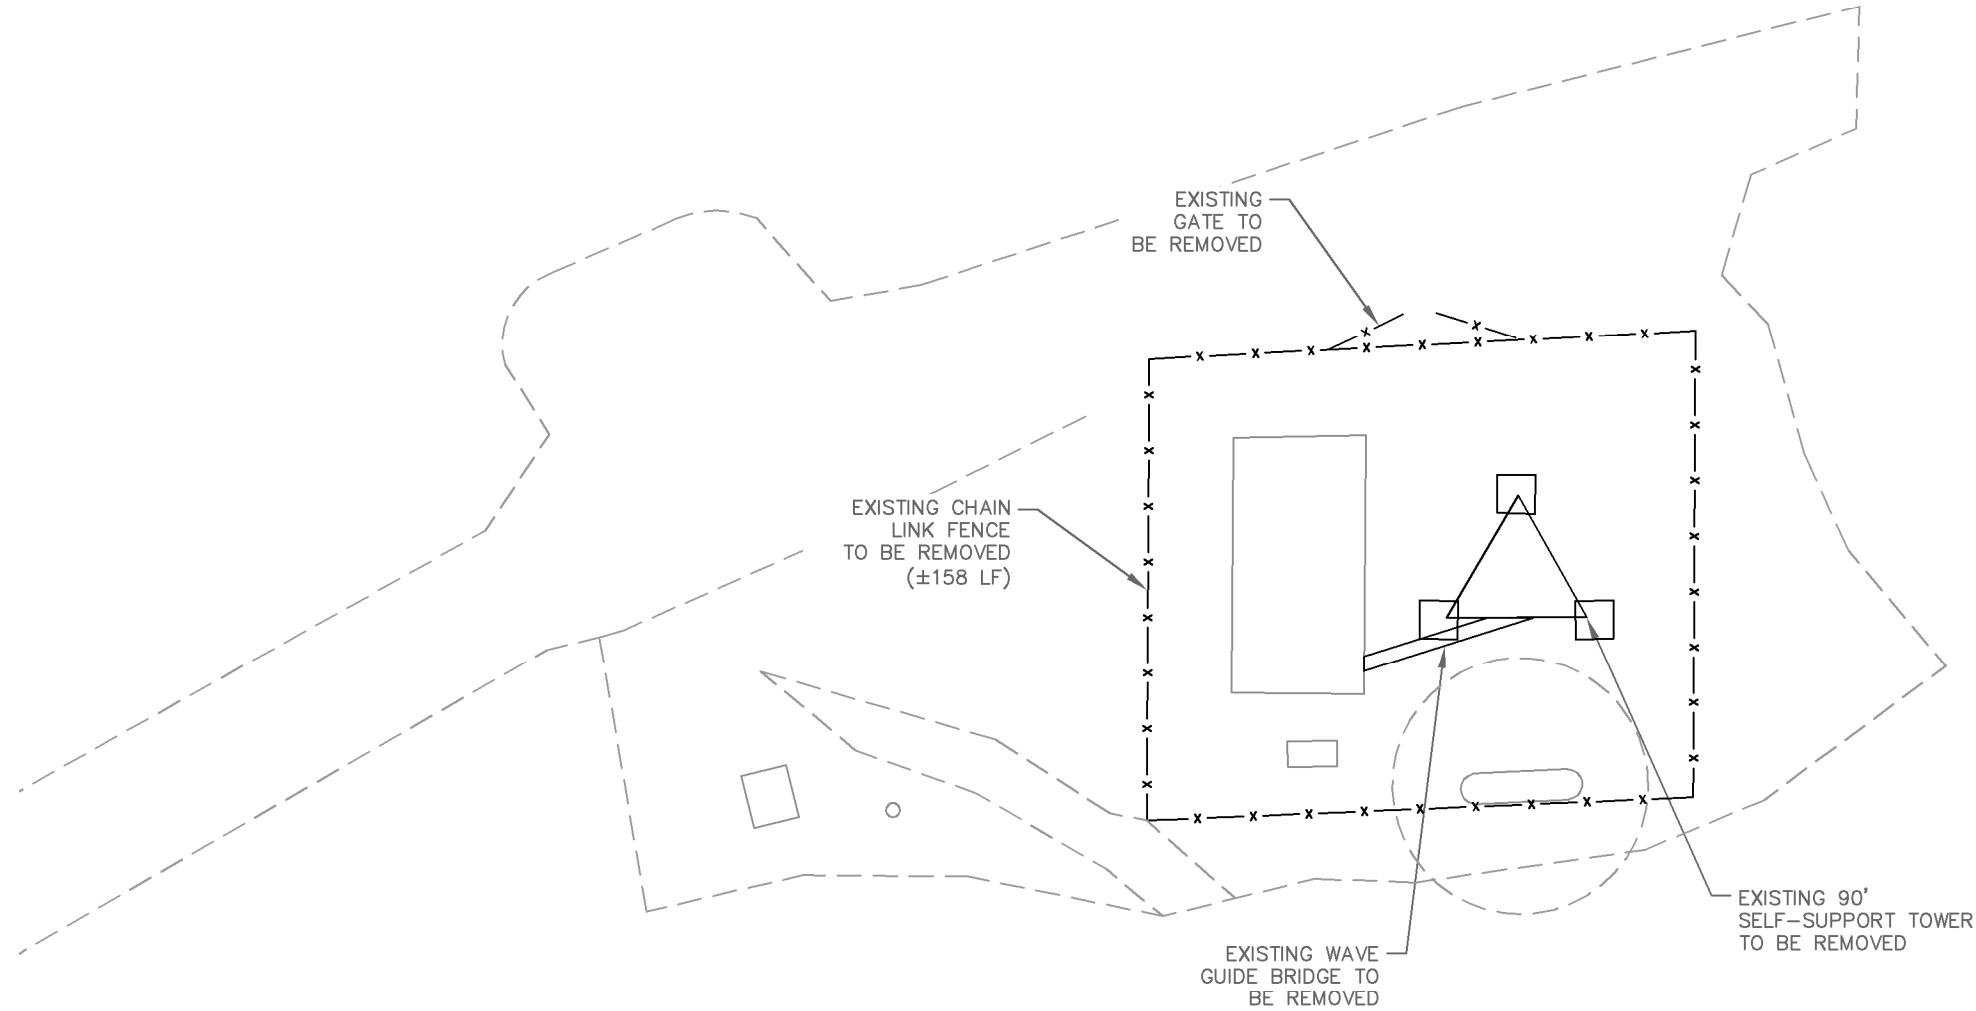


KHA PROJECT NUMBER:  
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 DRAWN BY: XQD CHECKED BY: DMF



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**EXISTING SITE PLAN**

SHEET NUMBER:  
**C2**
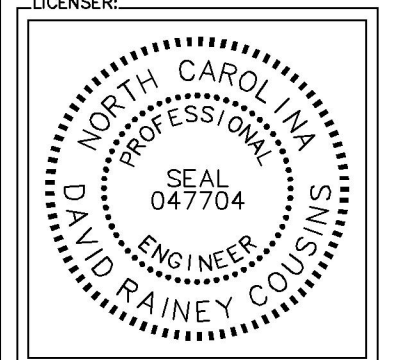
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1 DEMO PLAN  
C3 SCALE: 1" = 15'



PROJECT INFORMATION:
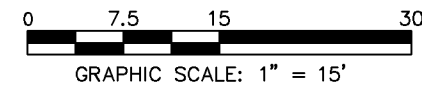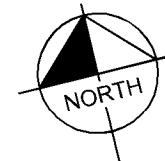
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HENDERSON COUNTY TOWER  
SITE No.: 639642  
PROJECT #: 20202154476  
469 S FORGE CREST DR  
MILLS RIVER, NC 28759  
HENDERSON COUNTY

PLANS PREPARED BY:


**Kimley»Horn**

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LICENSER:



KHA PROJECT NUMBER:

017848000

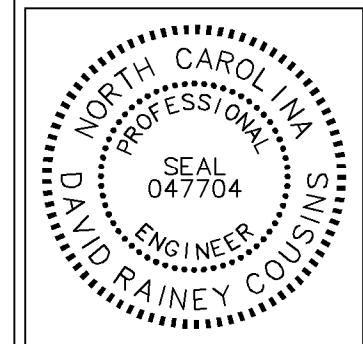DRAWN BY: CHECKED BY:

XQD

DMF


SHEET TITLE:

DEMO PLAN

SHEET NUMBER:

C3



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**1** SITE PLAN  
**C4** SCALE: 1" = 15'

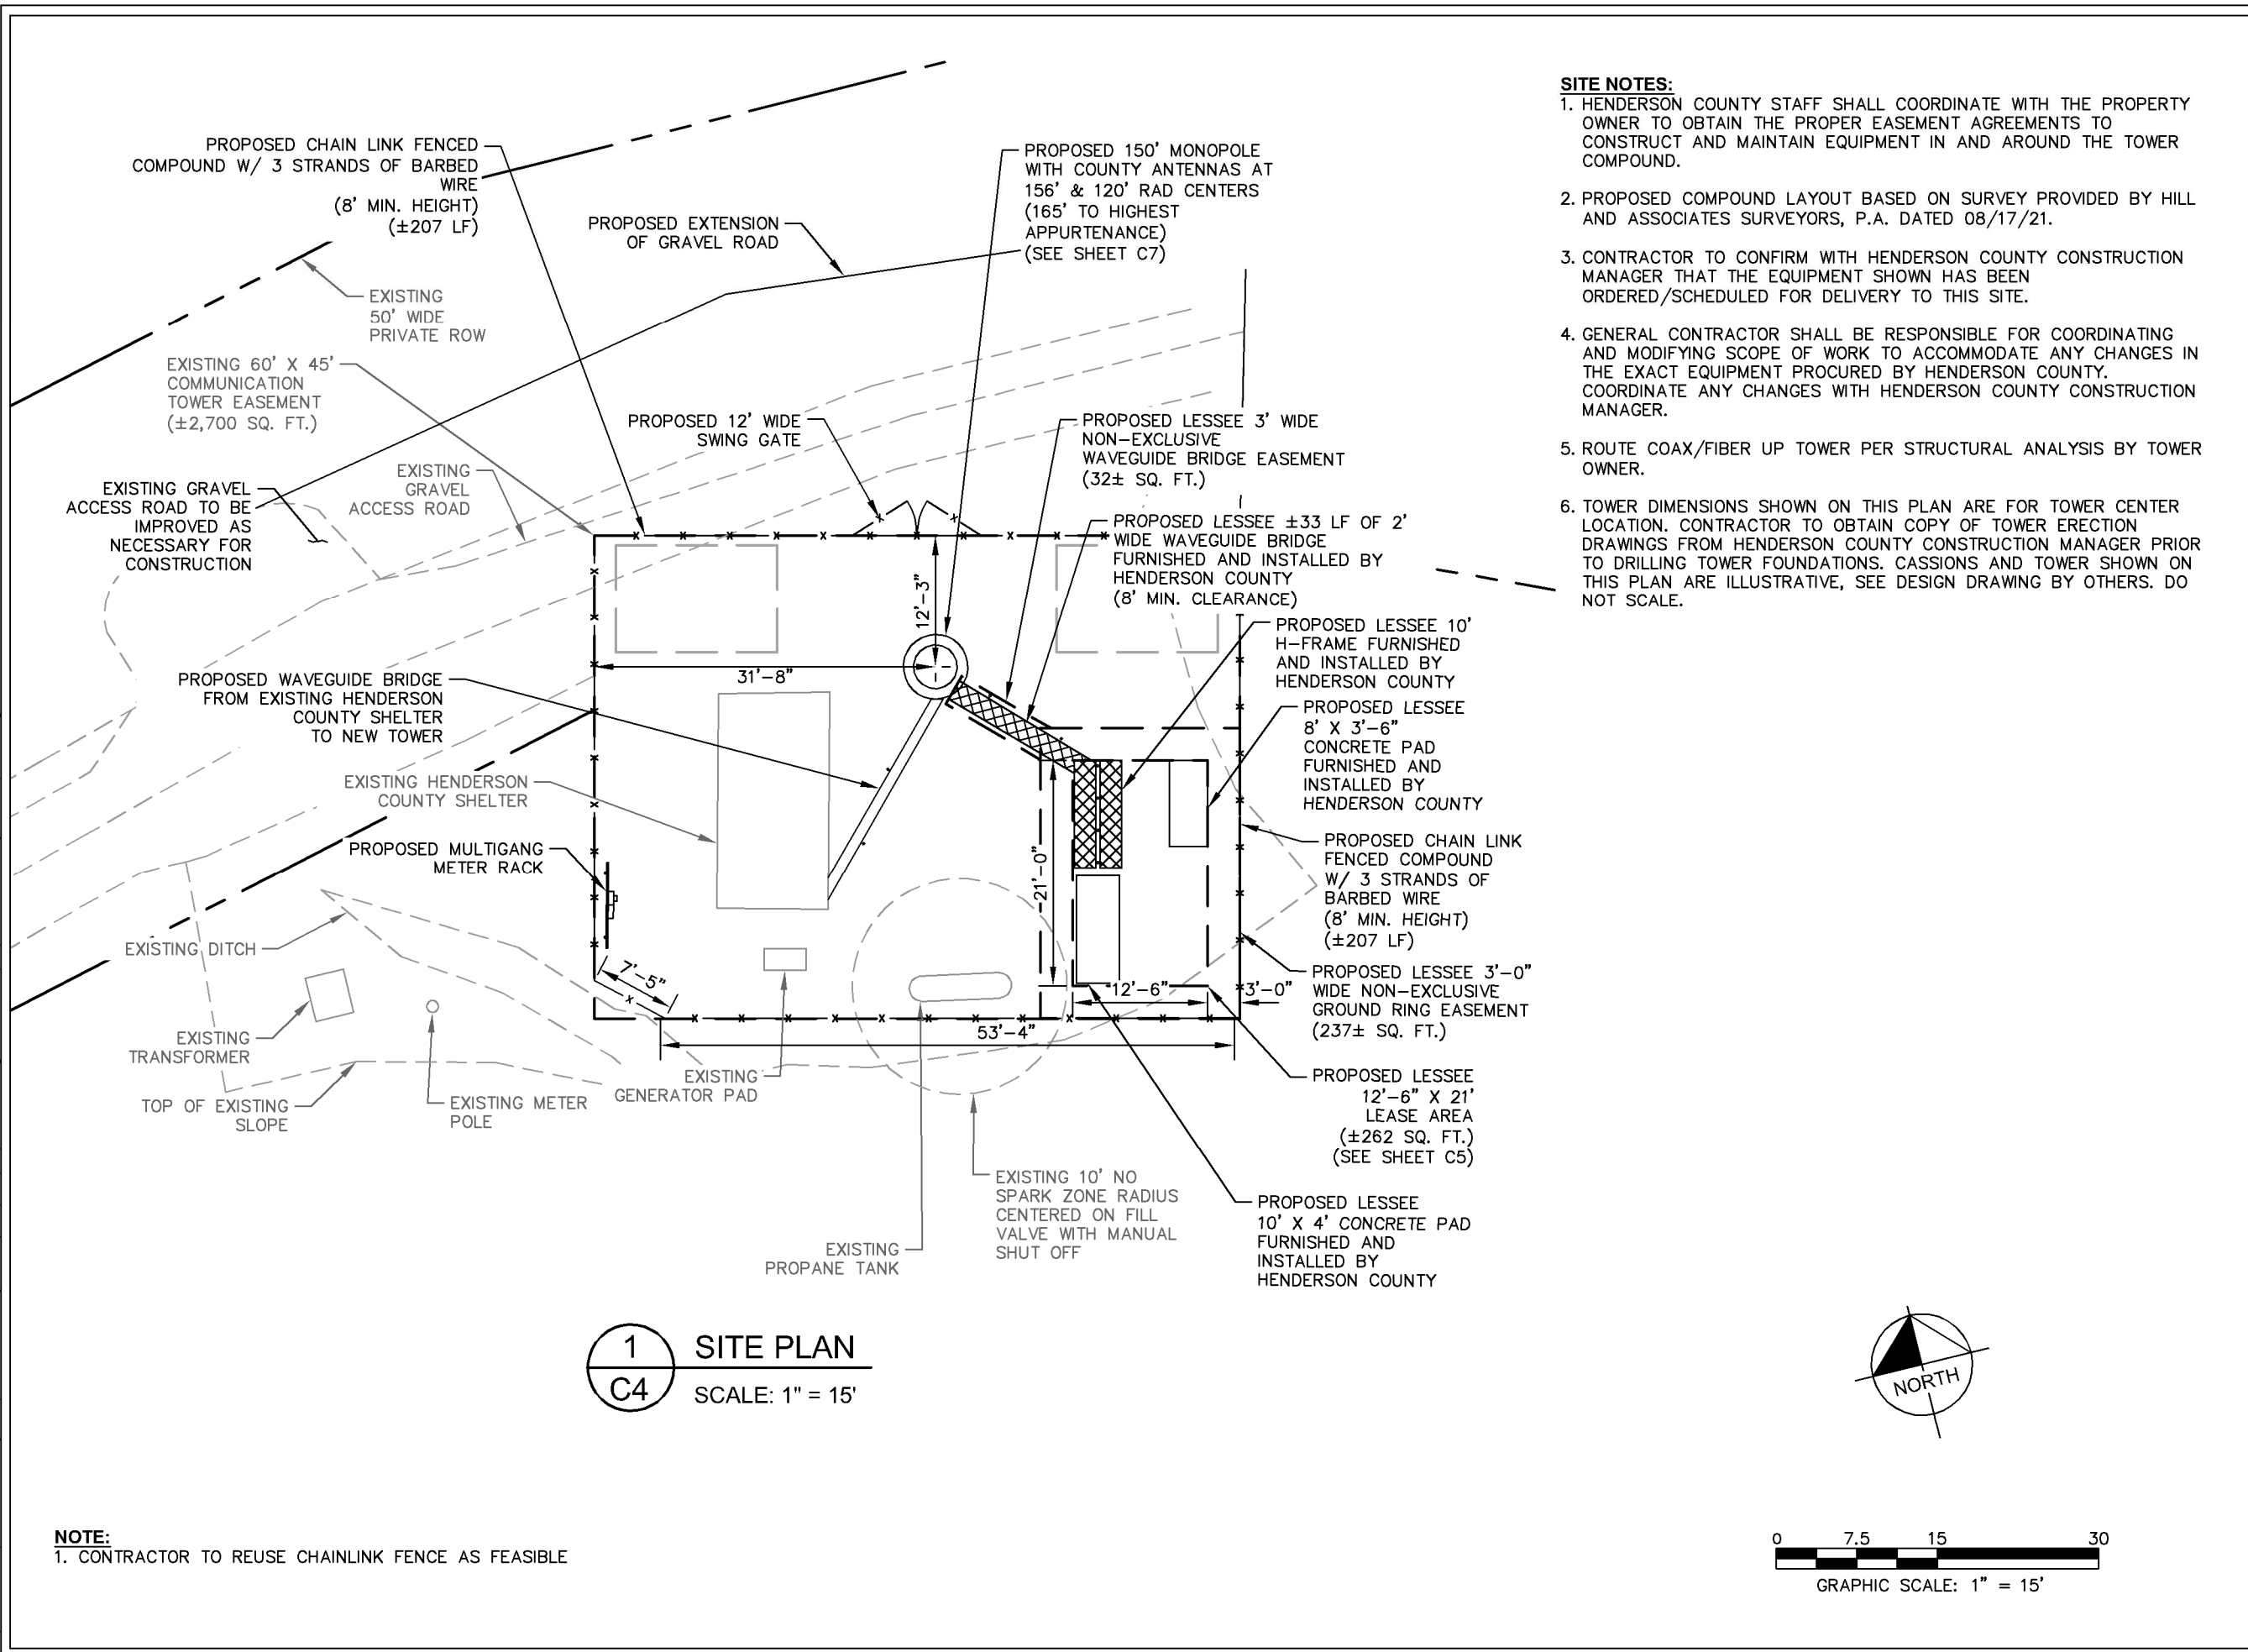**NOTE:**  
1. CONTRACTOR TO REUSE CHAINLINK FENCE AS FEASIBLE

- SITE NOTES:**
- HENDERSON COUNTY STAFF SHALL COORDINATE WITH THE PROPERTY OWNER TO OBTAIN THE PROPER EASEMENT AGREEMENTS TO CONSTRUCT AND MAINTAIN EQUIPMENT IN AND AROUND THE TOWER COMPOUND.
  - PROPOSED COMPOUND LAYOUT BASED ON SURVEY PROVIDED BY HILL AND ASSOCIATES SURVEYORS, P.A. DATED 08/17/21.
  - CONTRACTOR TO CONFIRM WITH HENDERSON COUNTY CONSTRUCTION MANAGER THAT THE EQUIPMENT SHOWN HAS BEEN ORDERED/SCHEDULED FOR DELIVERY TO THIS SITE.
  - GENERAL CONTRACTOR SHALL BE RESPONSIBLE FOR COORDINATING AND MODIFYING SCOPE OF WORK TO ACCOMMODATE ANY CHANGES IN THE EXACT EQUIPMENT PROCURED BY HENDERSON COUNTY. COORDINATE ANY CHANGES WITH HENDERSON COUNTY CONSTRUCTION MANAGER.
  - ROUTE COAX/FIBER UP TOWER PER STRUCTURAL ANALYSIS BY TOWER OWNER.
  - TOWER DIMENSIONS SHOWN ON THIS PLAN ARE FOR TOWER CENTER LOCATION. CONTRACTOR TO OBTAIN COPY OF TOWER ERECTION DRAWINGS FROM HENDERSON COUNTY CONSTRUCTION MANAGER PRIOR TO DRILLING TOWER FOUNDATIONS. CASSIONS AND TOWER SHOWN ON THIS PLAN ARE ILLUSTRATIVE, SEE DESIGN DRAWING BY OTHERS. DO NOT SCALE.




PROJECT INFORMATION:  
**SITE NAME:**  
 HENDERSON COUNTY TOWER  
 SITE No.: 639642  
 PROJECT #: 20202154476  
 469 S FORGE CREST DR  
 MILLS RIVER, NC 28759  
 HENDERSON COUNTY

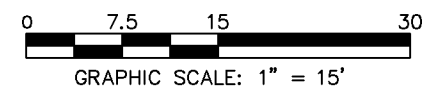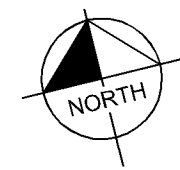PLANS PREPARED BY:  
**Kimley»Horn**  
 11720 AMBER PARK DRIVE, SUITE 600  
 ALPHARETTA, GA 30009  
 PHONE: 770-619-4280  
 WWW.KIMLEY-HORN.COM  
 NC License F-0102

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| 0 | 01/10/24 | CONSTRUCTION | DRC |

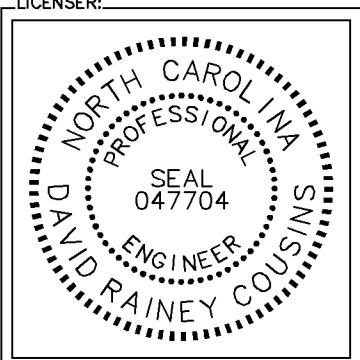

KHA PROJECT NUMBER:  
 017848000  
 DRAWN BY: XQD CHECKED BY: DMF

SHEET TITLE:  
**SITE PLAN**

SHEET NUMBER:  
**C4**






PROJECT INFORMATION:  
 SITE NAME:  
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LICENSER: \_\_\_\_\_



KHA PROJECT NUMBER:  
 017848000


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SHEET TITLE:

**EQUIPMENT PAD LAYOUT**

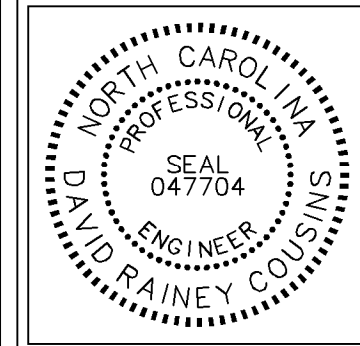SHEET NUMBER:


**C5**

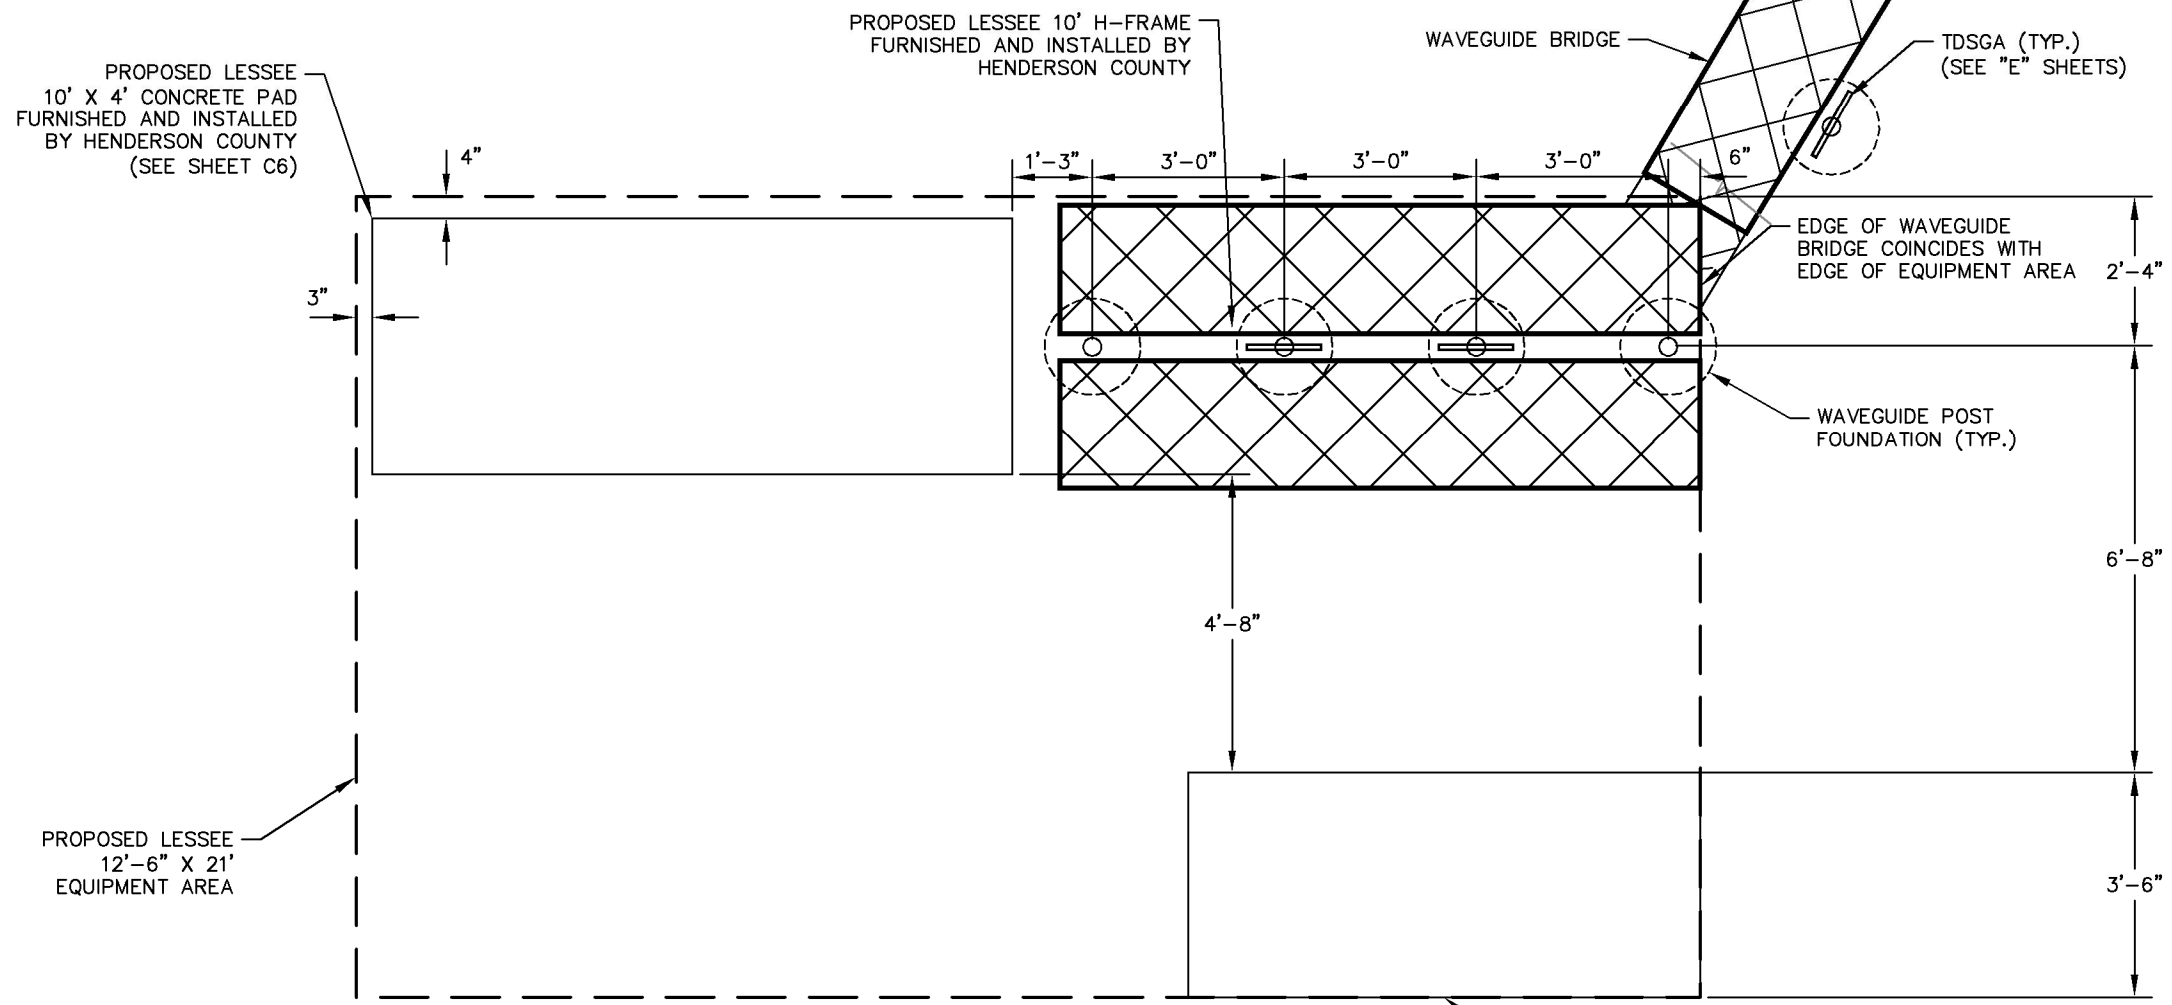

**1**  
**C5** **EQUIPMENT PAD LAYOUT**  
 SCALE: 1" = 3'

**EQUIPMENT PAD/ROUTING NOTES:**

- REFER TO THE SITE PLAN FOR EQUIPMENT PAD LOCATION AND ORIENTATION.
- RUN 2" FLEX TELCO CONDUIT FROM BOTTOM OF TELCO BOX TO SIDE OF RF CABINET WITH CHASE NIPPLE THROUGH FACTORY KNOCKOUT.
- RUN (2) 2" FLEX POWER CONDUIT AND (1) 1" ALARM CONDUIT FROM BOTTOM OF ILC TO SIDE OF RF CABINET WITH CHASE NIPPLES THROUGH FACTORY KNOCKOUTS.
- RUN 2" FLEX FIBER CONDUIT FROM BOTTOM OF OVP TO SIDE OF RF CABINET WITH CHASE NIPPLE THROUGH FACTORY KNOCKOUT.
- RUN (1) 1½" FLEX POWER CONDUIT FOR EVERY (6) RRU CIRCUITS FROM BOTTOM OF OVP TO SIDE OF RF CABINET WITH CHASE NIPPLE THROUGH FACTORY KNOCKOUT.
- SUPPORT FLEX CONDUIT ON HORIZONTAL H-FRAME RAILS OR ON VERTICAL SITE STRUT SNT10 RAILS ADDED TO H-FRAME FOR CONDUIT/CABLE MANAGEMENT.
- RUN HYBRID CABLE FOR TOWER MOUNTED RRU'S OVERHEAD ON TRAPEZE SUSPENDED FROM WAVE GUIDE BRIDGE. SWEEP DOWN ONTO H-FRAME RAILS, THEN LOOP UNDER OVP AND CONNECT TO BOTTOM OF OVP. ATTACH GROUND KITS TO HYBRID CABLE BEFORE LOOPING UNDER OVP, AND BOND TO TDSGA GROUND BAR AT BASE OF H-FRAME.
- RUN COAX CABLE FOR GROUND MOUNTED RRU'S (IF USED) OVERHEAD ON TRAPEZE SUSPENDED FROM WAVE GUIDE BRIDGE. TERMINATE COAX ON ICE BRIDGE AND TRANSITION TO JUMPERS JUST BEFORE REACHING H-FRAME. ATTACH GROUND KITS TO COAX CABLE ON TOWER SIDE OF LAST ICE BRIDGE POST AND BOND TO TDSGA GROUND BAR NEAR TOP OF POST.
- GPS ANTENNA TO BE MOUNTED TO STANDARD HEIGHT POST WITH EXTENDED MOUNTING PIPE, USING COMMSCOPE GPS-U MOUNTING KIT. MOUNT AS NEAR AS PRACTICAL TO RBA84 CABINET.
- BOLT CABINETS AND GENERATOR TO SLAB USING FASTENERS SPECIFIED BY EQUIPMENT MANUFACTURER IN FACTORY PROVIDED MOUNTING HOLES.

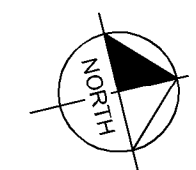


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| CONCRETE PAD SCHEDULE |        |       |     |                 |
|-----------------------|--------|-------|-----|-----------------|
| PAD TYPE              | "L"    | "W"   | "D" | REINFORCEMENT   |
| EQUIPMENT PAD         | 10'-0" | 4'-0" | 6"  | SEE DETAIL 2/C6 |
| GENERATOR PAD         | 8'-0"  | 3'-6" | 6"  | SEE DETAIL 2/C6 |



**1** CONCRETE PAD PLAN  
C6 NOT TO SCALE




**2** CONCRETE PAD FOUNDATION SECTION  
C6 NOT TO SCALE

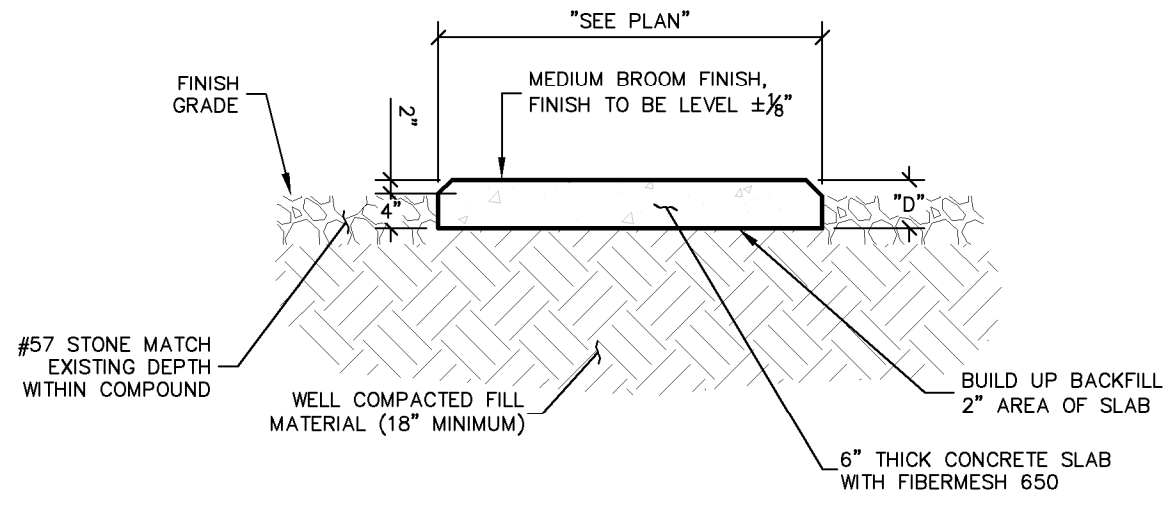

PROJECT INFORMATION:  
 SITE NAME:  
 HENDERSON COUNTY TOWER  
 SITE No.: 639642  
 PROJECT #: 20202154476  
 469 S FORGE CREST DR  
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 HENDERSON COUNTY

PLANS PREPARED BY:  
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| 0    | 01/10/24 | CONSTRUCTION | DRC |

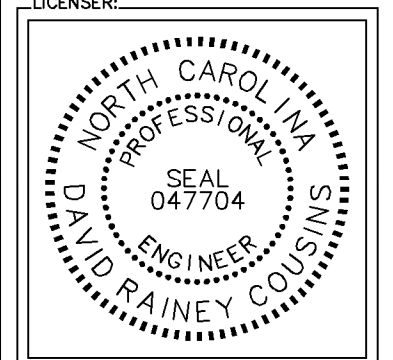

LICENSER:  
 KHA PROJECT NUMBER:  
 017848000  
 DRAWN BY: XQD CHECKED BY: DMF

SHEET TITLE:  
**CONCRETE PAD FOUNDATION DETAILS**


SHEET NUMBER:  
 C6



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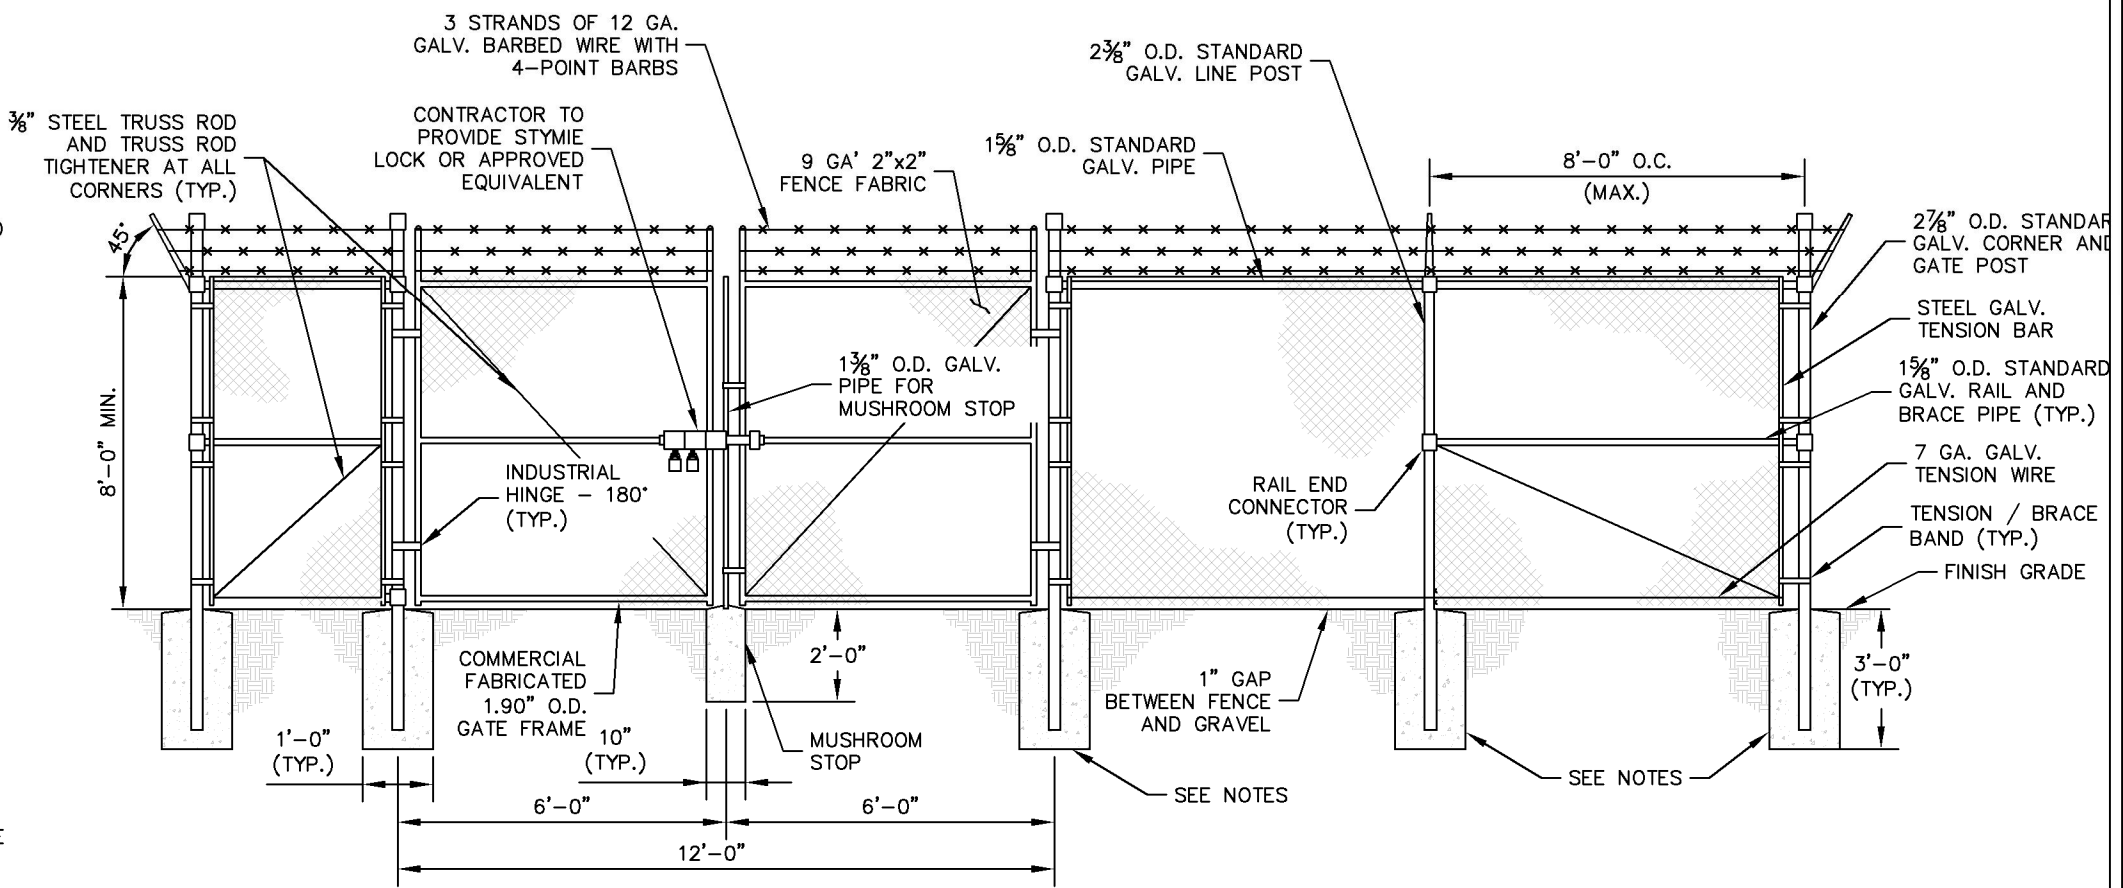
SHEET TITLE:

**FENCE DETAILS**


SHEET NUMBER:  
**C7**

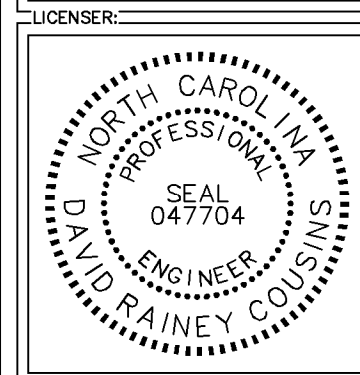**FENCE NOTES:**


- USE 3,000-PSI CONCRETE, FULLY CONSOLIDATED AROUND THE POST.
- WHERE THE POST IS SET IN ROCK OR CONCRETE, CORE A HOLE 12" DEEP AND 1" LARGER IN DIAMETER THAN THE POST. SET THE POST AND GROUT IN PLACE USING NON-SHRINK GROUT.
- ALL POSTS MUST BE PLUMB AND ALIGNED WITH ONE ANOTHER IN BOTH HORIZONTAL AND VERTICAL PLANES.
- CORNERS AND GATEPOSTS FOR CHAIN LINK FENCES SHALL EXTEND ABOVE THE TOP STRAND OF BARBED WIRE TO PROVIDE TENSIONING FOR THE BARBED WIRE.
- PROVIDE MIDRAILS AND BRACING AT ALL CORNER POSTS WHERE THE FENCE CHANGES DIRECTION BY MORE THAN 30 DEGREES.
- THE GRADE OF THE SITE AND INSTALLATION OF THE FENCE SHALL PROVIDE FOR NO MORE THAN A 1" GAP BETWEEN THE BOTTOM OF THE FENCE MATERIAL AND FINISH GRADE.
- CONTRACTOR SHALL PROVIDE HOLD OPEN DEVICES FOR ALL GATES AT THE SPECIFIED OPEN POSITIONS, DRIVEN PIPE TYPE RECEIVERS ARE NOT AUTHORIZED.
- CONTRACTOR SHALL ALSO PROVIDE A MUSHROOM TYPE RECEIVER AT THE CLOSE POSITION.




**1 CHAIN LINK FENCE AND GATE ELEVATION**  
 C7 NOT TO SCALE

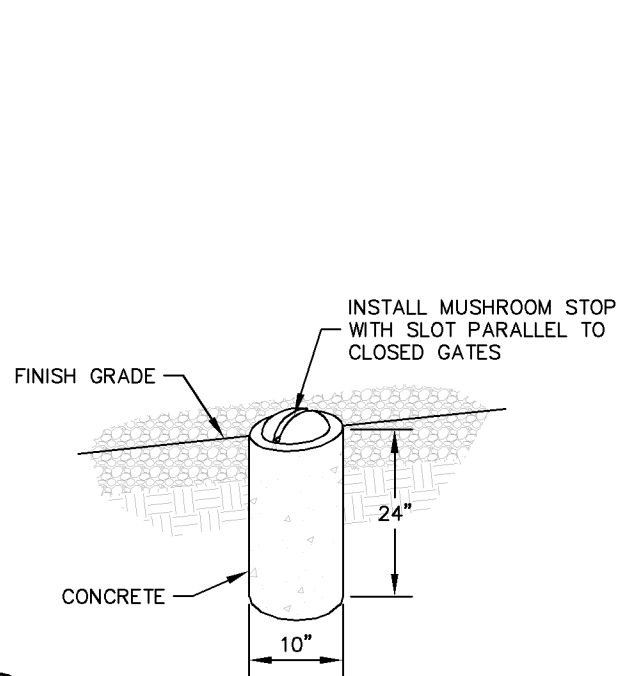

**2 MUSHROOM STOP**  
 C7 NOT TO SCALE

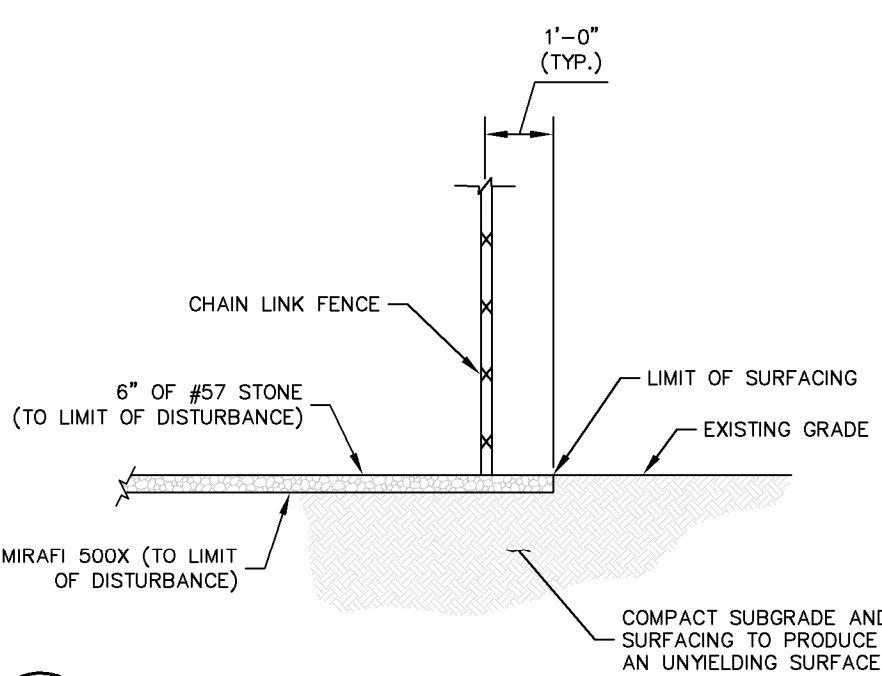

**3 SITE COMPOUND SURFACE DETAIL**  
 C7 NOT TO SCALE

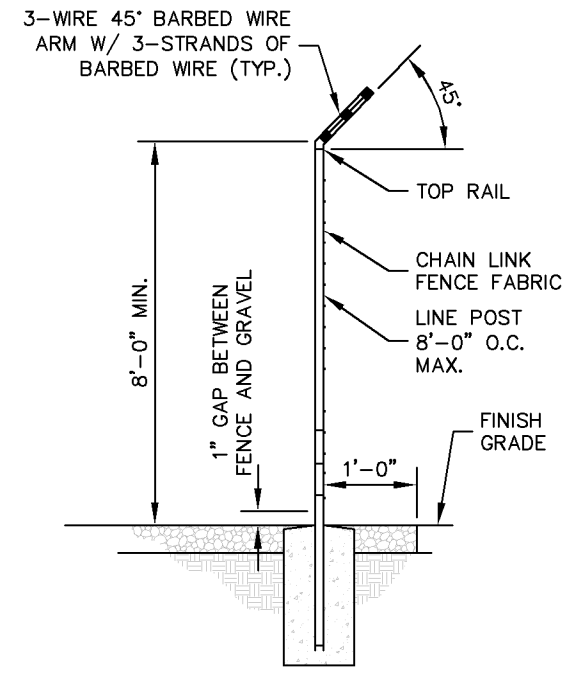

**4 SECTION AT FENCE**  
 C7 NOT TO SCALE

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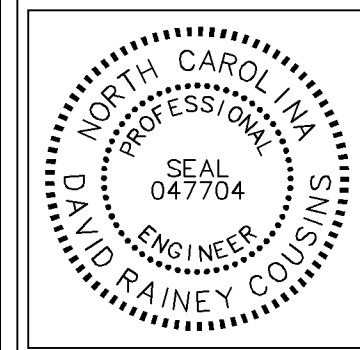
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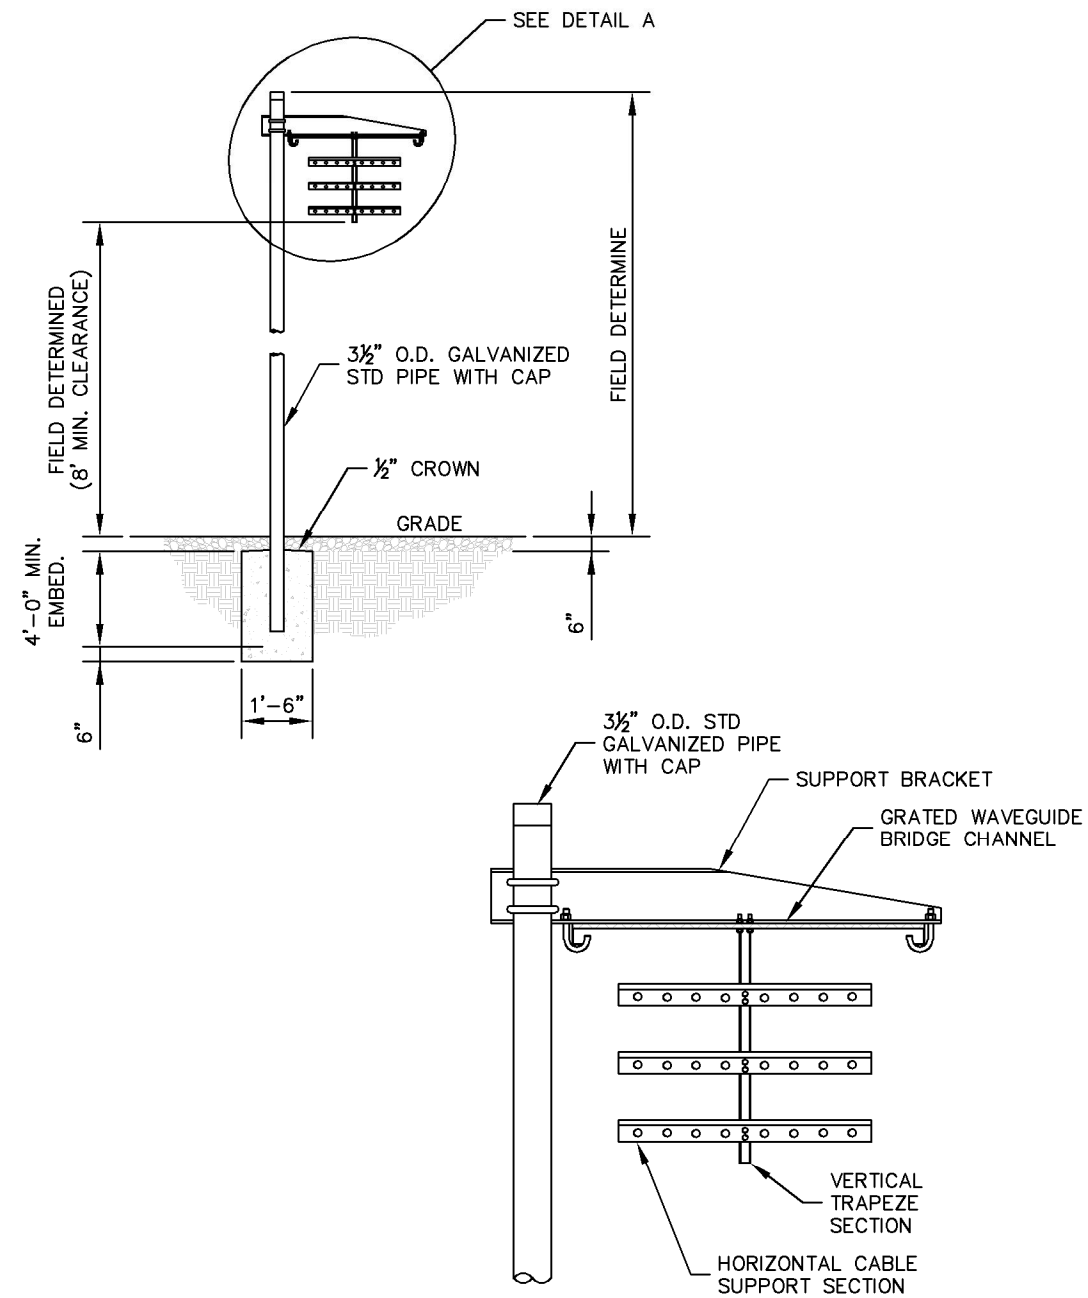
KHA PROJECT NUMBER:  
 017848000

DRAWN BY: XQD CHECKED BY: DMF

SHEET TITLE:

**WAVEGUIDE BRIDGE DETAILS**

SHEET NUMBER:  
 C8




**DETAIL A**

ANDREW 1 POST WAVEGUIDE BRIDGE KIT (PART #: WB-K210-B15, OR APPROVED EQUIVALENT)

NOTE:

1. ALL MATERIALS FURNISHED BY CONTRACTOR UNLESS OTHERWISE NOTED.

**1** WAVEGUIDE BRIDGE DETAIL  
 C8 NOT TO SCALE

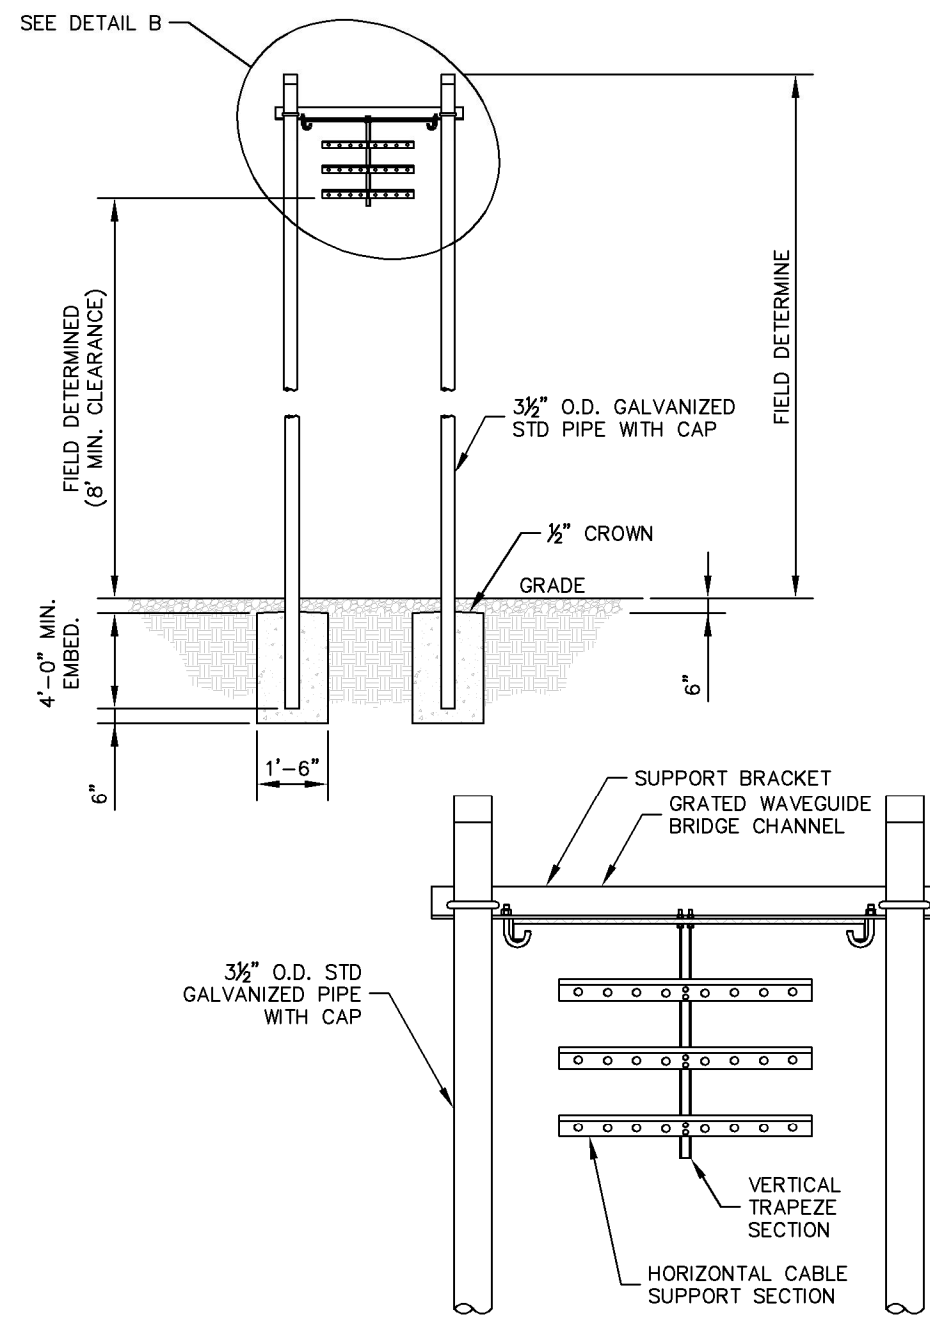

**DETAIL B**


ANDREW 2 POST WAVEGUIDE BRIDGE KIT (PART #: WB-K410-B15, OR APPROVED EQUIVALENT)

NOTE:

1. ALL MATERIALS FURNISHED BY CONTRACTOR UNLESS OTHERWISE NOTED.

**2** WAVEGUIDE BRIDGE DETAIL (ALT DESIGN - 2 PIPE COLUMNS)  
 C8 NOT TO SCALE

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TOP OF LIGHTNING ROD  
EL. 165' A.G.L.

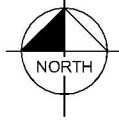TOP OF TOWER  
EL. 150' A.G.L.

TOP OF HENDERSON COUNTY VHF ANTENNA  
EL. 162' A.G.L.

PROPOSED HENDERSON COUNTY VHF ANTENNA  
EL. 156' A.G.L.

FUTURE ANTENNAS  
EL. 140' A.G.L.

FUTURE ANTENNAS  
EL. 130' A.G.L.

PROPOSED HENDERSON COUNTY ANTENNAS  
EL. 120' A.G.L.

FUTURE ANTENNAS  
EL. 110' A.G.L.

PROPOSED 150' MONOPOLE TOWER

EXISTING CHAIN LINK SECURITY FENCE

EXISTING GRADE  
(±0' A.G.L.)

## 2 MONOPOLE TOWER ELEVATION

C9 NOT TO SCALE

**NOTES:**

1. ALL EXISTING ATTACHMENTS TO TOWER BASED ON STRUCTURAL ANALYSIS BY OTHERS (SEE GENERAL NOTE 1.07, SHEET N1).
2. THE TOWER ELEVATION SHOWN ABOVE IS FOR REFERENCE ONLY.
3. COAX/FIBER CABLE LENGTHS ARE APPROXIMATE. CONTRACTOR TO VERIFY CORRECT LENGTH IN FIELD AT TIME OF CONSTRUCTION.
4. FOR CLARITY, EXISTING STRUCTURES NOT SHOWN.
5. PROPOSED ANTENNAS WILL BE LIGHT GRAY IN COLOR.

**NOTES:**

1. ALL INFORMATION ON THIS PAGE IS PROVIDED BY HENDERSON COUNTY AND/OR OTHERS AND IS SHOWN FOR ILLUSTRATIVE PURPOSES ONLY. CONTRACTOR SHALL CONTACT THE HENDERSON COUNTY CONSTRUCTION MANAGER PRIOR TO CONSTRUCTION FOR ALL DETAILED ANTENNA, AND COAX CABLE INFORMATION.
2. REFER TO STRUCTURAL ANALYSIS BY TOWER OWNER FOR ANALYSIS OF PROPOSED TOWER.
3. IT IS UNDERSTOOD THAT KIMLEY-HORN MAKES NO WARRANTY, EITHER EXPRESSED OR IMPLIED, FINDINGS, DESIGNS, RECOMMENDATIONS, SPECIFICATIONS, OPINION, OR PROFESSIONAL ADVICE RELATING TO THE STRUCTURAL ADEQUACY OF THE PROPOSED TOWER OR ATTACHMENT OF ANTENNAS OR OTHER APPURTENANCES.



PROJECT INFORMATION:  
 SITE NAME:  
 HENDERSON COUNTY TOWER  
 SITE No.: 639642  
 PROJECT #: 20202154476  
 469 S FORGE CREST DR  
 MILLS RIVER, NC 28759  
 HENDERSON COUNTY

PLANS PREPARED BY:  
**Kimley»Horn**  
 11720 AMBER PARK DRIVE, SUITE 600  
 ALPHARETTA, GA 30009  
 PHONE: 770-619-4280  
 WWW.KIMLEY-HORN.COM  
 NC License F-0102

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LICENSER:  
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KHA PROJECT NUMBER:  
 017848000  
 DRAWN BY: XQD CHECKED BY: DMF

SHEET TITLE:  
**ANTENNA AND TOWER ELEVATION DETAILS**


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PROJECT INFORMATION:  
 SITE NAME:  
 HENDERSON COUNTY TOWER  
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REV: \_\_\_\_\_ DATE: \_\_\_\_\_ ISSUED FOR: \_\_\_\_\_ BY: \_\_\_\_\_

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 NO SIGNATURE  
 REQUIRED

KHA PROJECT NUMBER:  
 017848000

DRAWN BY: \_\_\_\_\_ CHECKED BY: \_\_\_\_\_  
 XQD DMF

SHEET TITLE: \_\_\_\_\_

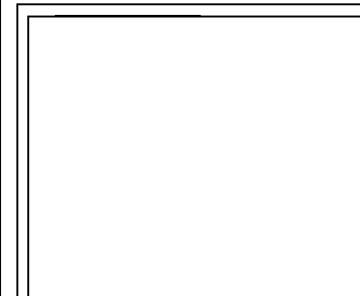**TOWER  
 EQUIPMENT  
 SCHEDULE**

SHEET NUMBER:  
 C9.1

| EQUIPMENT REPLACEMENT SUMMARY SCHEDULE |          |                                  |
|--|----------|----------------------------------|
| EQUIPMENT                              | QUANTITY | DESCRIPTION                      |
| EXISTING EQUIPMENT                     |          |                                  |
| ANTENNAS                               | 2        | 4' MW DISH ANTENNA               |
|  | 2        | VHF TRANSMIT ANTENNA             |
| FEEDLINES                              | 4        | ANDREW 7/8" HELIAX               |
|  | -        | -                                |
| OTHER EQUIPMENT                        | -        | -                                |
|  | -        | -                                |
| EQUIPMENT TO BE RELOCATED              |          |                                  |
| ANTENNAS                               | 2        | 4' MW DISH ANTENNA               |
| FEEDLINES                              | -        | -                                |
| OTHER EQUIPMENT                        | -        | -                                |
| EQUIPMENT TO BE INSTALLED              |          |                                  |
| ANTENNAS                               | 1        | DB-224                           |
|  | 4        | DB-222                           |
|  | 2        | HPD4-4.7                         |
|  | 1        | HPD6-11                          |
| FEEDLINES                              | 10       | ANDREW 7/8" HELIAX               |
| OTHER EQUIPMENT                        | 4        | 3' SIDE ARMS FOR DB-222 ANTENNAS |
|  | -        | -                                |
|  | -        | -                                |
|  | -        | -                                |
| FINAL CONFIGURATION                    |          |                                  |
| ANTENNAS                               | 2        | 4' MW DISH ANTENNA               |
|  | 1        | DB-224                           |
|  | 4        | DB-222                           |
|  | 2        | HPD4-4.7                         |
|  | 1        | HPD6-11                          |
|  | -        | -                                |
| FEEDLINES                              | 10       | ANDREW 7/8" HELIAX               |
|  | -        | -                                |
| OTHER EQUIPMENT                        | 4        | 3' SIDE ARMS FOR DB-222 ANTENNAS |
|  | -        | -                                |
|  | -        | -                                |

**1** SCOPE OF WORK SUMMARY  
**C9.1** NOT TO SCALE

1. THE PROPOSED DB-224 ANTENNA IS TO BE INSTALLED AT 156' AGL. THE DB-222 ANTENNAS ARE TO BE INSTALLED AT 120' AGL. ALL DB-222 MUST BE MOUNTED ON 3-FOOT SIDE ARMS AWAY FROM THE TOWER.
2. ALL ANTENNAS SHOULD BE PROVIDED WITH ANDREW 7/8" HELIAX WITH APPROPRIATE HOISTING GRIPS AND "N" STYLE CONNECTORS.
3. RELOCATED ANTENNAS SHOULD BE PROVIDED NEW COAX AND CONNECTORS (SPECIFICATIONS TO BE PROVIDED BY HENDERSON COUNTY. CONTRACTOR TO COORDINATE WITH HENDERSON COUNTY PM)

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1.8 m | 6 ft High Performance Parabolic Reflector Antenna, Single-polarized, 10.7-11.7GHz

HP6-11



The HP High Performance Series by RadioWaves offers a full line of high performance parabolic antennas engineered to provide ETSI class 2/3 radiation pattern performance as well as excellent gain. RadioWaves field-proven pre-assembled antennas and robust pole-mounts ensure "set and forget" installation with minimal post-installation maintenance. The included radome ensures robust and reliable performance under the most challenging conditions. If it's rugged, it must be RadioWaves!

**FEATURES AND BENEFITS**

- High Performance ETSI Class 2/3 Parabolic Antennas – Excellent performance for a wide range of applications
- Fully Preassembled at the Factory – Simplifies installation on site and guarantees "factory-tested" quality

\*ETSI Class depends on frequency band

**SPECIFICATIONS**

**General**

|               |  |                              |                                    |
|---------------|--|------------------------------|------------------------------------|
| Antenna Type  | High Performance Parabolic Reflector Antenna | Standard RF Connector Type   | CPR50G                             |
| Size, nominal | 6 ft   1.8 m                                 | Standard RF Connector Suffix | RS (append suffix to model number) |
| Polarization  | Single                                       |                              |                                    |

**Electrical**

|                                   |                 |                      |          |
|-----------------------------------|-----------------|----------------------|----------|
| Operating Frequency Band          | 10.7 - 11.7 GHz | Gain, Low Frequency  | 43.1 dBi |
| Half Power Beamwidth, Horizontal  | 1.1 degrees     | Gain, Mid Frequency  | 43.4 dBi |
| Half Power Beamwidth, Vertical    | 1.1 degrees     | Gain, High Frequency | 43.8 dBi |
| Cross-Polarization Discrimination | 30 dB           | VSWR                 | 1.37:1   |
| Front to Back Ratio (F/B)         | 88 dB           | Return Loss          | -15.1 dB |

**Mechanical**

|                               |                     |  |                       |
|-------------------------------|---------------------|--|-----------------------|
| Fine Azimuth Adjustment       | +/- 10 degrees      | Mechanical Configuration                     | HP6                   |
| Fine Elevation Adjustment     | +/- 10 degrees      | Axial Force (FA)                             | 1680 lbs   7473 N     |
| Mounting Pipe Diameter, Min   | 4.5 inch   114.4 cm | Side Force (FS)                              | 832 lbs   3700 N      |
| Mounting Pipe Diameter, Max   | 4.5 inch   114.4 cm | Twisting Moment (MT)                         | 2100 ft-lbs   2847 Nm |
| Net Weight                    | 251 lbs   113 kg    | Operating Temperature Range                  | -40 to +60 C          |
| Wind Velocity Operational     | 90 mph   145 km/h   | Max Pressure, PSIG, (if waveguide interface) | 5                     |
| Wind Velocity Survival Rating | 125 mph   201 km/h  |  |                       |

**Regulatory Compliance**


|                            |                 |                |              |
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| FCC                        | Part 101 Cat. A | ETSI           | 302217 R1 C2 |
| Industry Canada Compliance | SRSP310.7 B     | RoHS-compliant | Yes          |

**Shipping Information**

|              |                    |                       |                                     |
|--------------|--------------------|-----------------------|-------------------------------------|
| Package Type | Wood Crate         | Dimensions, L x W x H | 77 x 35 x 80 in   195 x 89 x 203 cm |
| Gross Weight | 401 lbs   181.6 kg | Shipping Volume       | 124.77 cu ft   3.53 cu m            |

\*Additional OEM interfaces and adapters may be available. Contact RadioWaves for a complete and current list of available adapters.

**TECHNICAL DRAWINGS**

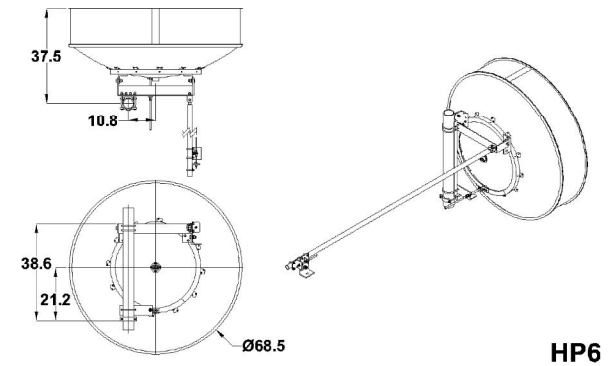

HP6

1.2 m | 4 ft High Performance Parabolic Reflector Antenna, Dual-polarized, 4.4-5GHz

HPD4-4.7



The HP High Performance Series by RadioWaves offers a full line of high performance parabolic antennas engineered to provide ETSI class 2/3 radiation pattern performance as well as excellent gain. RadioWaves field-proven pre-assembled antennas and robust pole-mounts ensure "set and forget" installation with minimal post-installation maintenance. The included radome ensures robust and reliable performance under the most challenging conditions. If it's rugged, it must be RadioWaves!

**FEATURES AND BENEFITS**

- High Performance ETSI Class 2/3 Parabolic Antennas – Excellent performance for a wide range of applications
- Fully Preassembled at the Factory – Simplifies installation on site and guarantees "factory-tested" quality

\*ETSI Class depends on frequency band

**SPECIFICATIONS**

**General**

|               |  |                              |                                    |
|---------------|--|------------------------------|------------------------------------|
| Antenna Type  | High Performance Parabolic Reflector Antenna | Standard RF Connector Type   | N-Female                           |
| Size, nominal | 4 ft   1.2 m                                 | Standard RF Connector Suffix | NS (append suffix to model number) |
| Polarization  | Dual   |                              |                                    |

**Electrical**

|                                   |             |                      |          |
|-----------------------------------|-------------|----------------------|----------|
| Operating Frequency Band          | 4.4 - 5 GHz | Gain, Low Frequency  | 31.8 dBi |
| Half Power Beamwidth, Horizontal  | 3.6 degrees | Gain, Mid Frequency  | 32.4 dBi |
| Half Power Beamwidth, Vertical    | 3.6 degrees | Gain, High Frequency | 32.9 dBi |
| Cross-Polarization Discrimination | 30 dB       | VSWR                 | 1.5:1    |
| Front to Back Ratio (F/B)         | 54 dB       | Return Loss          | -14 dB   |

**Mechanical**

|                               |                     |  |                      |
|-------------------------------|---------------------|--|----------------------|
| Fine Azimuth Adjustment       | +/- 10 degrees      | Mechanical Configuration                     | HP4-LoFreq           |
| Fine Elevation Adjustment     | +/- 25 degrees      | Axial Force (FA)                             | 737 lbs   3278 N     |
| Mounting Pipe Diameter, Min   | 4.5 inch   114.4 cm | Side Force (FS)                              | 365 lbs   1623 N     |
| Mounting Pipe Diameter, Max   | 4.5 inch   114.4 cm | Twisting Moment (MT)                         | 784 ft-lbs   1063 Nm |
| Net Weight                    | 85 lbs   38.3 kg    | Operating Temperature Range                  | -40 to +60 C         |
| Wind Velocity Operational     | 90 mph   145 km/h   | Max Pressure, PSIG, (if waveguide interface) | 5                    |
| Wind Velocity Survival Rating | 125 mph   201 km/h  |  |                      |

**Regulatory Compliance**


|                            |            |                |            |
|----------------------------|------------|----------------|------------|
| FCC                        | undeclared | ETSI           | undeclared |
| Industry Canada Compliance | undeclared | RoHS-compliant | Yes        |

**Shipping Information**

|              |                   |                       |                                     |
|--------------|-------------------|-----------------------|-------------------------------------|
| Package Type | Wood Crate        | Dimensions, L x W x H | 59 x 35 x 60 in   180 x 89 x 152 cm |
| Gross Weight | 196 lbs   88.9 kg | Shipping Volume       | 71.7 cu ft   2.03 cu m              |

\*Additional OEM interfaces and adapters may be available. Contact RadioWaves for a complete and current list of available adapters.

**TECHNICAL DRAWINGS**

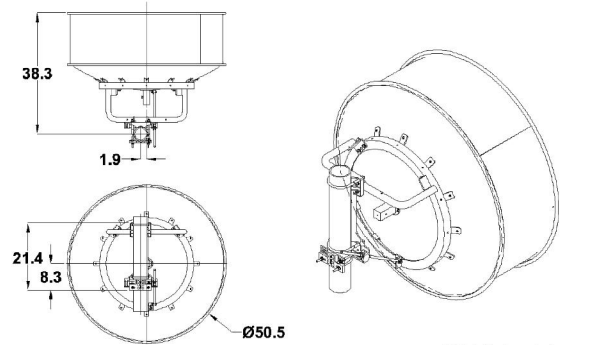

HP4-LoFreq



**PROJECT INFORMATION:**

**SITE NAME:**  
HENDERSON COUNTY TOWER  
SITE No.: 639642  
**PROJECT #:** 20202154476  
469 S FORGE CREST DR  
MILLS RIVER, NC 28759  
HENDERSON COUNTY

**PLANS PREPARED BY:**

**Kimley»Horn**

11720 AMBER PARK DRIVE, SUITE 600  
ALPHARETTA, GA 30009  
PHONE: 770-619-4280  
WWW.KIMLEY-HORN.COM  
NC License F-0102

**REV: DATE: ISSUED FOR:**

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**LICENSER:**

**FOR ILLUSTRATIVE PURPOSES ONLY- NO SIGNATURE REQUIRED**

**KHA PROJECT NUMBER:**

017848000

**DRAWN BY: CHECKED BY:**

XQD DMF

**SHEET TITLE:**

**ANTENNA SPECS**

**SHEET NUMBER:**


C9.2

1 ANTENNA SPECS  
C9.2 NOT TO SCALE



PROJECT INFORMATION:  
 SITE NAME:  
 HENDERSON COUNTY TOWER  
 SITE No.: 639642  
 PROJECT #: 20202154476  
 469 S FORGE CREST DR  
 MILLS RIVER, NC 28759  
 HENDERSON COUNTY

PLANS PREPARED BY:  
**Kimley»Horn**  
 11720 AMBER PARK DRIVE, SUITE 600  
 ALPHARETTA, GA 30009  
 PHONE: 770-619-4280  
 WWW.KIMLEY-HORN.COM  
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KHA PROJECT NUMBER: \_\_\_\_\_
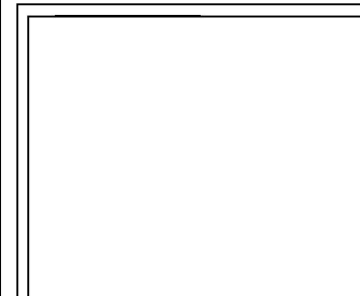
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DRAWN BY: \_\_\_\_\_ CHECKED BY: \_\_\_\_\_

XQD DMF

SHEET TITLE: \_\_\_\_\_

ANTENNA SPECS

SHEET NUMBER: \_\_\_\_\_

C9.3

### DB222-A



1-port omni exposed dipole antenna, 150-158 MHz, 360° HPBW, fixed electrical tilt

- Broad response
- Weather resistant

**General Specifications**

Antenna Type: Omni  
 Band: Single band  
 Color: Silver  
 Grounding Type: RF connector inner conductor and body grounded to reflector and mounting bracket  
 Performance Note: Outdoor usage  
 Radiator Material: Aluminum  
 RF Connector Interface: N Male  
 RF Connector Location: Bottom  
 RF Connector Quantity, low band: 1  
 RF Connector Quantity, total: 1

**Dimensions**

Length: 3,225.8 mm | 127 in  
 Net Weight, without mounting kit: 7.2 kg | 15.873 lb

**Electrical Specifications**

Impedance: 50 ohm  
 Operating Frequency Band: 150 - 158 MHz  
 Polarization: Vertical

**Electrical Specifications**

Frequency Band, MHz: 150-158  
 Gain, dBi: 5.1  
 Beamwidth, Horizontal, degrees: 360  
 Beamwidth, Vertical, degrees: 36

Page 1 of 2

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COMMSCOPE

### DB222-A

Beam Tilt, degrees: 0  
 VSWR | Return loss, dB: 1.5 | 14.0  
 Input Power per Port, maximum, watts: 500

**Mechanical Specifications**

Wind Loading @ Velocity, maximum: 284.7 N @ 100 mph (64.0 lbf @ 100 mph)  
 Wind Speed, maximum: 201 km/h | 124.896 mph

**Regulatory Compliance/Certifications**

Agency: ISO 9001:2015  
 Classification: Designed, manufactured and/or distributed under this quality management system

**Included Products**

DB365-OS - Pipe Mounting Kit that consists of two clamps for mounting antennas to round members 1.25-3.5 in (35-89 mm) OD round members.

**\*Footnotes**

Performance Note: Severe environmental conditions may degrade optimum performance

Page 2 of 2

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COMMSCOPE

### DB365-OS

Pipe Mounting Kit that consists of two clamps for mounting antennas to round members 1.25 - 3.5 in (35 - 89 mm) OD round members.

**Product Classification**

Product Type: Pipe mount kit

**General Specifications**

Application: Outdoor  
 Color: Silver

**Dimensions**

Compatible Diameter, maximum: 88.9 mm | 3.5 in  
 Compatible Diameter, minimum: 33 mm | 1.299 in  
 Weight, net: 3.2 kg | 7.055 lb

**Material Specifications**

Material Type: Galvanized steel

**Packaging and Weights**

Included: Brackets | Hardware  
 Packaging quantity: 2  
 Weight, gross: 3.6 kg | 7.937 lb

**Regulatory Compliance/Certifications**

Agency: CE  
 Classification: Compliant with the relevant CE product directives  
 CE: Compliant with the relevant CE product directives  
 LHMNA-RH-015: Below maximum concentration value  
 ISO 9001:2015: Designed, manufactured and/or distributed under this quality management system  
 REACH-SVHC: Compliant as per SVHC revision on www.commscope.com/ProductCompliance  
 ROHS: Compliant

**Included Products**

DB365-OS - Pipe Mounting Kit that consists of two clamps for mounting antennas to round members 1.25-3.5 in (35-89 mm) OD round members.

**\*Footnotes**

Performance Note: Severe environmental conditions may degrade optimum performance

Page 1 of 1

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COMMSCOPE

### DB224-A



1-port omni exposed dipole antenna, 150-160 MHz, 360° HPBW, fixed electrical tilt

- Broad response
- Two-piece mast for ease of shipping

**General Specifications**

Antenna Type: Omni  
 Band: Single band  
 Color: Silver  
 Grounding Type: RF connector inner conductor and body grounded to reflector and mounting bracket  
 Performance Note: Outdoor usage  
 Radiator Material: Aluminum  
 RF Connector Interface: N Male  
 RF Connector Location: Bottom  
 RF Connector Quantity, low band: 1  
 RF Connector Quantity, total: 1

**Dimensions**

Length: 6,477 mm | 255 in  
 Net Weight, without mounting kit: 15.9 kg | 35.053 lb

**Electrical Specifications**

Impedance: 50 ohm  
 Operating Frequency Band: 150 - 160 MHz  
 Polarization: Vertical

**Electrical Specifications**

Frequency Band, MHz: 150-160  
 Gain, dBi: 8.1  
 Beamwidth, Horizontal, degrees: 360  
 Beamwidth, Vertical, degrees: 16

Page 1 of 2

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COMMSCOPE

### DB224-A

Beam Tilt, degrees: 0  
 VSWR | Return loss, dB: 1.5 | 14.0  
 Input Power per Port, maximum, watts: 500

**Mechanical Specifications**

Wind Loading @ Velocity, maximum: 560.5 N @ 100 mph (126.0 lbf @ 100 mph)  
 Wind Speed, maximum: 130 km/h | 80.778 mph

**Regulatory Compliance/Certifications**

Agency: ISO 9001:2015  
 Classification: Designed, manufactured and/or distributed under this quality management system

**Included Products**

DB365-OS - Pipe Mounting Kit that consists of two clamps for mounting antennas to round members 1.25-3.5 in (35-89 mm) OD round members.

**\*Footnotes**

Performance Note: Severe environmental conditions may degrade optimum performance

Page 2 of 2

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COMMSCOPE

1 ANTENNA SPECS  
 C9.3 NOT TO SCALE

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**NOTE:**  
CURRENT DESIGN ANTICIPATES APPROXIMATELY XXXXX± SQ. FT. (0.XX ACRES) OF CLEARING AND GRADING FOR THE PROPOSED PROJECT. IF ADDITIONAL CLEARING IS REQUIRED BEYOND WHAT IS SHOWN IN THE PLANS THE CONTRACTOR SHALL NOTIFY THE ENGINEER AND/OR PROJECT MANAGER. IF DURING THE BID WALK OR CONSTRUCTION IT IS DETERMINED THAT MORE THAN (1) ACRE OF LAND IS TO BE DISTURBED FOR CONSTRUCTION AN EROSION AND SEDIMENTATION CONTROL PLAN MUST BE FILED 30 DAYS PRIOR TO CONSTRUCTION.


**GRADING NOTES:**

1. THE CONTRACTOR SHALL CLEAR AND GRUB THE SITE AND PLACE, COMPACT, AND MOISTURE CONDITION ALL FILL PER THE PROJECT GEOTECHNICAL ENGINEERS SPECIFICATIONS. FILL MATERIAL SHALL BE APPROVED BY THE GEOTECHNICAL ENGINEER PRIOR TO PLACEMENT.
2. ALL PROPOSED CONTOURS AND SPOT ELEVATIONS REFLECT FINISHED GRADES.
3. CONTRACTOR SHALL BLEND EARTHWORK SMOOTHLY TO TRANSITION BACK TO EXISTING GRADE.
4. PORTIONS OF THE SITE NOT SPECIFICALLY MENTIONED WITHIN THE GEOTECHNICAL REPORT SHALL BE COMPACTED TO 95 PERCENT OF THE MATERIALS MAXIMUM DRY DENSITY WITHIN 3 PERCENT OF OPTIMUM MOISTURE CONTENT.
5. FILL SHALL BE PLACED IN MAXIMUM 8 INCH LOOSE LIFTS.
6. UNDISTURBED AREAS WITHIN 30' INGRESS/EGRESS EASEMENT NOT NEEDED FOR UTILITY ROUTING TO BE LEFT UNDISTURBED.
7. GROUND WATER SHOULD BE REASONABLY EXPECTED. ANY DE-WATERING OR MOISTURE CONDITIONING IS THE RESPONSIBILITY OF THE CONTRACTOR AND SHOULD BE INCLUDED IN THE CONTRACT PRICE.
8. SEED ALL DISTURBED AREAS NOT TOPPED WITH GRAVEL PER SEEDING SCHEDULE ON DETAIL ON SHEET C9.
9. MAXIMUM CUT SLOPE = 2H:1V UNLESS OTHERWISE NOTED.
10. MAXIMUM FILL SLOPE = 3H:1V UNLESS OTHERWISE NOTED.


**LEGEND**

- EXISTING CONTOURS -----
- PROPOSED CONTOURS \_\_\_\_\_
- LOD/SILT FENCE --- LOD --- ///
- TPF \_\_\_\_\_ TPF \_\_\_\_\_ TPF \_\_\_\_\_
- EXISTING SPOT ELEVATION    x    XXX
- PROPOSED SPOT ELEVATION    ●    XXX

| CUT/ FILL TABLE |                 |
|-----------------|-----------------|
| CUT VOLUME:     | XX.XX CU YD.    |
| FILL VOLUME:    | XX.XX CU. YD.   |
| NET VOLUME:     | X.XX YD. (FILL) |

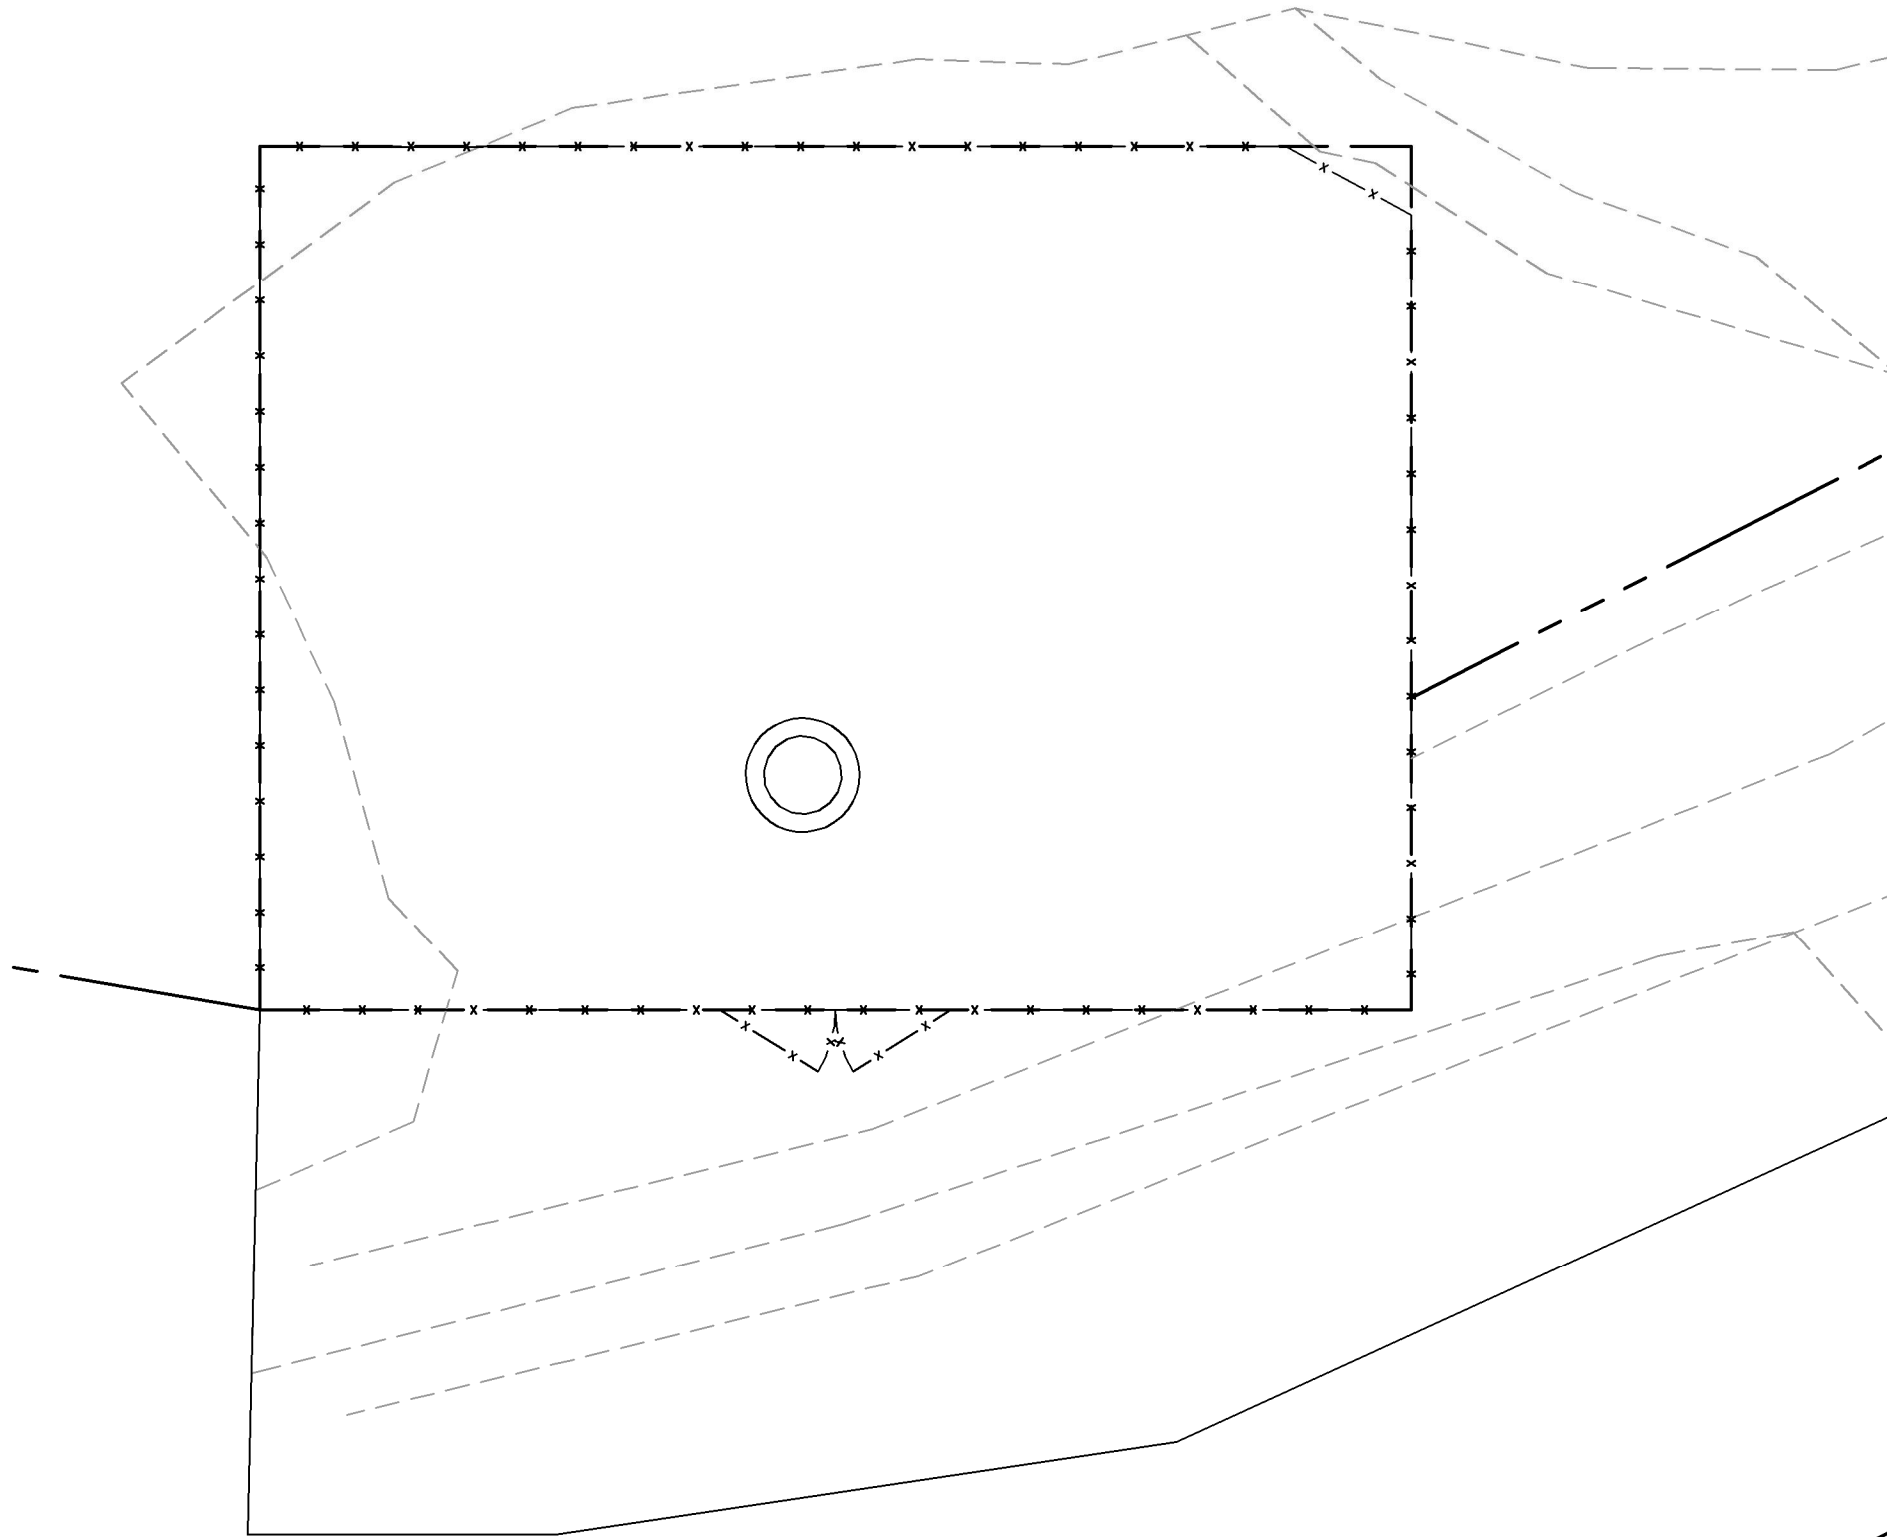

**1 GRADING & EROSION CONTROL PLAN**  
**C10** SCALE: 1" = 10'

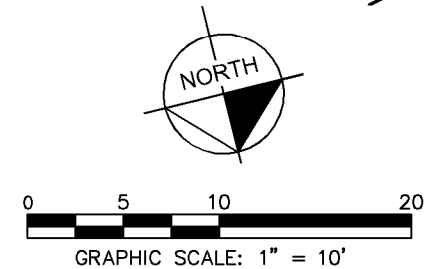


PROJECT INFORMATION:  
SITE NAME:  
HENDERSON COUNTY TOWER  
SITE No.: 639642  
PROJECT #: 20202154476  
469 S FORGE CREST DR  
MILLS RIVER, NC 28759  
HENDERSON COUNTY

PLANS PREPARED BY:  
**Kimley»Horn**  
11720 AMBER PARK DRIVE, SUITE 600  
ALPHARETTA, GA 30009  
PHONE: 770-619-4280  
WWW.KIMLEY-HORN.COM  
NC License F-0102

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KHA PROJECT NUMBER:  
017848000

DRAWN BY: \_\_\_\_\_ CHECKED BY: \_\_\_\_\_  
XQD                      DMF

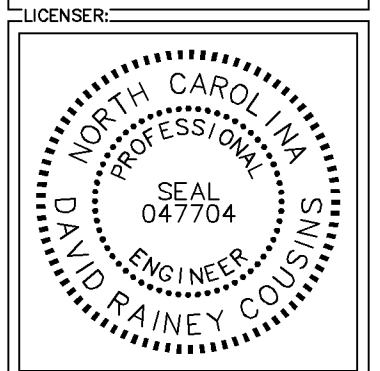
SHEET TITLE:  
**GRADING & EROSION CONTROL PLAN**

SHEET NUMBER:  
**C10**



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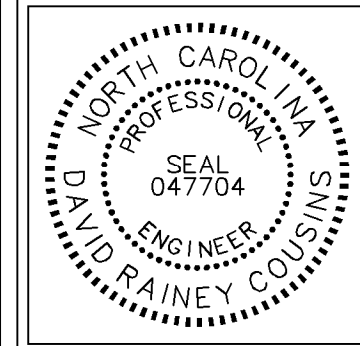
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| 0 | 01/10/24 | CONSTRUCTION | DRC |

LICENSER:

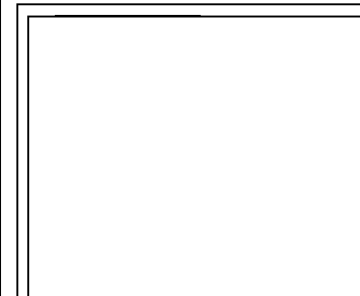

KHA PROJECT NUMBER:  
017848000

DRAWN BY: XQD CHECKED BY: DMF

SHEET TITLE:

**GRADING & EROSION CONTROL PLAN**

SHEET NUMBER:

C10.1

**EROSION CONTROL NOTES:**

1. EROSION CONTROLS SHALL BE INSTALLED PRIOR TO CONSTRUCTION AND SHALL BE ADEQUATE TO MAINTAIN SEDIMENT ON SITE.
2. ALL EXCAVATED SOILS NOT NEEDED ON SITE FOR BACKFILL OPERATIONS SHALL BECOME PROPERTY OF THE CONTRACTOR AND SHALL BE TAKEN OFF SITE AND LEGALLY DISPOSED OF.
3. SOIL REMAINING ON SITE SHALL HAVE SILT FENCE TIGHTLY PLACED AROUND THE ENTIRE CIRCUMFERENCE OF THE PILE.
4. PROVIDE EROSION CONTROLS AS NECESSARY TO PREVENT EXISTING SOILS FROM DRAINING OFF SITE OR INTO EXISTING DRAINAGE STRUCTURES.
5. ERECTION OF EROSION CONTROLS SHALL BE IN ACCORDANCE WITH STATE AND LOCAL EROSION CONTROL REGULATIONS.

**SEEDING SCHEDULE FOR WINTER / SPRING CONSTRUCTION ACTIVITIES**

**SEEDING MIXTURE**

| Species  | Rate (lb/acre) |
|--|----------------|
| Rye (grain)  | 120            |
| Annual lespedeza (Kobe in Piedmont and Coastal Plain, Korean in Mountains) | 50             |

Omit annual lespedeza when duration of temporary cover is not to extend beyond June.

**SEEDING DATES**

|                                 |                 |
|---------------------------------|-----------------|
| Mountains-- Above 2500 ft:      | Feb 15 - May 15 |
| Below 2500 ft.:                 | Feb. 1 - May 1  |
| Piedmont--Jan. 1 - May 1        |                 |
| Coastal Plain--Dec. 1 - Apr. 15 |                 |

**SOIL AMENDMENTS**  
 Follow recommendations of soil tests or apply 2,000 lb/acre ground agricultural limestone and 750 lb/acre 10-10-10 fertilizer.

**MULCH**  
 Apply 4,000 lb/acre straw. Anchor straw by tacking with asphalt, netting, or a mulch anchoring tool. A disk with blades set nearly straight can be used as a mulch anchoring tool.

**MAINTENANCE**  
 Refertilize if growth is not fully adequate. Reseed, refertilize and mulch immediately following erosion or other damage.

**SEEDING SCHEDULE FOR SUMMER CONSTRUCTION ACTIVITIES**

**SEEDING MIXTURE**


| Species             | Rate (lb/acre)              |
|---------------------|-----------------------------|
| Common Bermudagrass | 40-80 (1-2 lb/1,000 sq.ft.) |

**SEEDING DATES**  
 Coastal Plain--Apr. 1 - July  
 Piedmont--Apr. 15 - June 30


**SOIL AMENDMENTS**  
 Apply lime and fertilizer according to soil tests, or apply 3,000 lb/acre ground agricultural limestone and 500 lb/acre 10-10-10 fertilizer.

**MULCH**  
 Use jute, excelsior matting, or other effective channel lining material to cover the bottom of channels and ditches. The lining should extend above the highest calculated depth of flow. On channel side slopes above this height, and in drainages not requiring temporary lining, apply 4,000 lb/acre grain straw and anchor straw by stapling netting over the top.

**MAINTENANCE**  
 A minimum of 3 weeks is required for establishment. Inspect and repair mulch frequently. Refertilize the following Apr. with 50 lb/acre nitrogen.

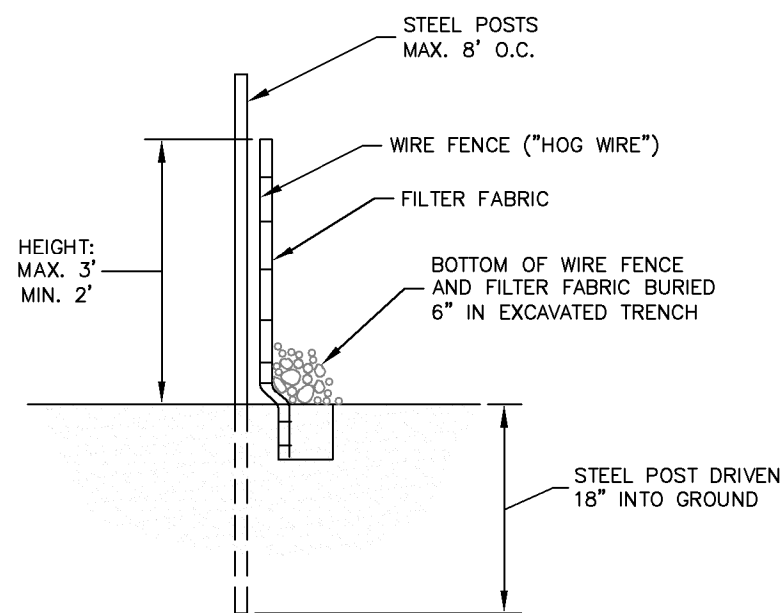

**SECTION 1**  
**SEDIMENT FENCE (SILT FENCE)**  
 C10.1 NOT TO SCALE

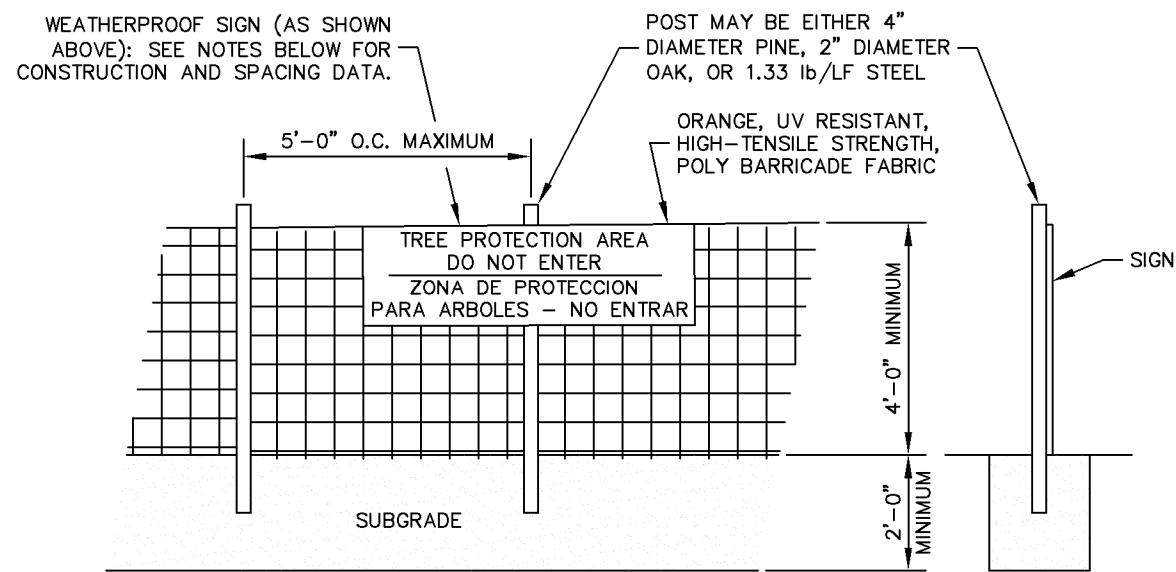

**NOTES**  
 INSTALL TREE PROTECTION FENCE AND SIGNAGE PRIOR TO CALLING FOR SITE INSPECTION. MAINTAIN TREE PROTECTION FENCE THROUGHOUT DURATION OF PROJECT. ADDITIONAL SIGNS MAY BE REQUIRED BASED ON ACTUAL FIELD CONDITIONS.

**SECTION 2**  
**TREE PROTECTION FENCE**  
 C10.1 NOT TO SCALE

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# ELECTRICAL NOTES

## 1.00 CODES, STANDARDS, & SPECIFICATIONS

- 1.01 IT IS THE CONTRACTOR'S RESPONSIBILITY TO ENSURE THAT ALL MATERIALS AND LABOR RELATED DIRECTLY OR INDIRECTLY TO ALL ELECTRICAL WORK DOCUMENTED IN THESE DRAWINGS SHALL BE PROVIDED AND PERFORMED IN CONFORMANCE WITH ALL CURRENT GOVERNING CODES, STANDARDS, AND PROFESSIONAL STANDARD OF CARE TO INCLUDE THE AMERICAN SOCIETY FOR TESTING AND MATERIALS (ASTM), UNDERWRITERS LABORATORY (UL), NATIONAL ELECTRICAL MANUFACTURERS ASSOCIATION (NEMA), AMERICAN STANDARDS ASSOCIATION (ASA), NATIONAL FIRE PROTECTION ASSOCIATION (NFPA), AND THE NATIONAL ELECTRICAL CODE (NEC).
- 1.02 MATERIALS SHALL BE NEW AND SHALL CONFORM TO ALL APPLICABLE CURRENT GOVERNING STANDARDS ESTABLISHED FOR EACH ITEM BY ASTM, UL, NEMA, ASA, AND NFPA.
- 1.03 ALL ELECTRICAL WORK SHALL COMPLY WITH ALL APPLICABLE STATE, COUNTY, AND MUNICIPAL CODES AND ORDINANCES, AS WELL AS ALL CURRENT GOVERNING STANDARDS AND PRACTICES AS REQUIRED BY NEC, NEMA, ANSI, NFPA, UBC, UL, IEEE, AND THE LOCAL UTILITY COMPANY.
- 1.04 ALL ELECTRICAL GROUNDING SHALL COMPLY WITH THE CURRENT EDITION OF THE NEC.
- 1.05 CONTRACTOR SHALL MAINTAIN UL LISTED FIRE RATINGS AT ALL WALL PENETRATIONS.
- 1.06 CONTRACTOR SHALL MAINTAIN A MINIMUM CLEARANCE OF 36" IN FRONT OF ALL ELECTRICAL EQUIPMENT AS REQUIRED BY NEC. MINIMUM CLEARANCE SHALL BE OBSERVED FOR BOTH THE FRONT AND THE REAR OF THE METER H-FRAME RACK AND THE EQUIPMENT H-FRAME RACK.

## 2.00 GENERAL

- 2.01 CONTRACTOR SHALL BE RESPONSIBLE FOR ALL PERMITS AND ASSOCIATED FEES RELATED TO THE PROJECT AND SHALL DELIVER A COPY OF ALL PERMITS TO THE VERIZON REPRESENTATIVE.
- 2.02 CONTRACTOR SHALL SCHEDULE AND SHOULD ATTEND ALL INSPECTIONS REQUIRED BY THE JURISDICTION HAVING AUTHORITY.
- 2.03 CONTRACTOR SHALL FURNISH ALL LABOR, MATERIALS, TOOLS, ACCESSORIES, ETC., FOR A COMPLETE WORKING ELECTRICAL INSTALLATION.
- 2.04 ALL WORK SHALL BE PERFORMED IN STRICT ACCORDANCE WITH APPLICABLE BUILDING CODES AND LOCAL ORDINANCES, INSTALLED IN A NEAT MANNER, AND SHALL BE SUBJECT TO APPROVAL BY THE ENGINEER.
- 2.05 CONTRACTOR SHALL PROTECT ADJACENT EQUIPMENT AND FINISHES FROM DAMAGE AND SHALL REPAIR TO ORIGINAL CONDITION ANY ITEMS DAMAGED AS A RESULT OF THE WORK.
- 2.06 CONTRACTOR SHALL REPAIR ANY LANDSCAPING DISTURBED DURING CONSTRUCTION.
- 2.07 IF CONDUIT RUNS HAVE MORE THAN THREE (3) CONSECUTIVE 90 DEGREE TURNS, THE CONTRACTOR SHALL INSTALL PULL BOXES AS REQUIRED BY NEC.
- 2.08 CONTRACTOR SHALL INDICATE THE LOCATION OF ALL CAPPED UNDERGROUND SPARE CONDUIT ON THE RECORD DRAWINGS SUBMITTED TO THE OWNER.
- 2.09 CONTRACTOR SHALL COORDINATE EXACT ROUTING OF CONDUIT WITH OWNER. ALL CONDUIT SHALL BE ROUTED WITHIN 3 FEET, EITHER SIDE, OF PERIMETER FENCING.

## 3.00 MATERIALS

- 3.01 ALL EQUIPMENT AND MATERIALS SHOWN SHALL BE CONSIDERED NEW UNLESS SPECIFICALLY NOTED OTHERWISE ON THE DRAWINGS.
- 3.02 FINAL CONNECTIONS OF EQUIPMENT SHALL BE PER MANUFACTURER'S APPROVED WIRING DIAGRAMS, DETAILS, AND INSTRUCTIONS. THE ELECTRICAL CONTRACTOR SHALL PROVIDE MATERIALS AND EQUIPMENT COMPATIBLE WITH EQUIPMENT SUPPLIED BY VERIZON.
- 3.03 CONTRACTOR SHALL PROVIDE AN UPDATED PANELBOARD DIRECTORY FOR THE PANEL FROM WHICH THE NEW VERIZON EQUIPMENT CIRCUIT WILL BE CONNECTED. CONTRACTOR SHALL SUBMIT UPDATED DIRECTORY IN A PLASTIC COVER TO THE BUILDING OWNER FOR APPROVAL PRIOR TO INSTALLATION.
- 3.04 CONTRACTOR SHALL FIELD DETERMINE ACTUAL CONDUIT ROUTING AND SHALL OBTAIN APPROVAL FROM THE TOWER OWNER OF THE PROPOSED ROUTING PRIOR TO CONDUIT INSTALLATION.
- 3.05 ALL CONDUCTORS SHALL BE COPPER WITH THWN INSULATION AND ALL TERMINATIONS SHALL BE RATED FOR AT LEAST 75 DEGREES CELSIUS.
- 3.06 ALL NEUTRAL CONDUCTORS SHALL HAVE WHITE INSULATION. ALL GROUND CONDUCTORS SHALL HAVE GREEN INSULATION. COLOR TAPE IDENTIFICATION OF THESE CONDUCTORS IS NOT PERMITTED.
- 3.07 CONTRACTOR SHALL SEAL ALL CONDUITS ENTERING AN ENCLOSURE WITH CONDUIT SEALANT THAT IS COMPATIBLE WITH THE INSULATION OF THE CONDUCTORS IN THE CONDUIT.
- 3.08 CONDUIT RUNS SHALL HAVE A CONTINUOUS DOWNWARD SLOPE AWAY FROM ALL EQUIPMENT TO PREVENT WATER INFILTRATION.
- 3.09 ALL CONDUIT SHALL BE SCHEDULE 40 PVC UNLESS NOTED OTHERWISE ON THE PLANS. WHEN CONDUIT IS ROUTED UNDER A ROADWAY, SCHEDULE 80 PVC CONDUIT SHALL BE UTILIZED. MANUFACTURED BEND RADII SHALL BE PER NEC.
- 3.10 CONTRACTOR SHALL PROVIDE TWO (2) 200 POUND TEST POLYETHYLENE PULL CORDS IN ALL CONDUITS AND ALL INNERDUCTS. PULL CORDS SHALL BE SECURED AT EACH END OF CONDUIT RUNS. ALL SPARE CONDUIT ENDS SHALL BE CAPPED WITH MANUFACTURED PVC FITTINGS.
- 3.11 CONTRACTOR SHALL BOND EACH METALLIC CONDUIT ENTERING A METALLIC ENCLOSURE WITH A #8 MIN AWG INSULATED COPPER BONDING JUMPER PER NEC. CONTRACTOR SHALL BOND ALL ELECTRICAL EQUIPMENT TO THE H-FRAME RACK ON WHICH EQUIPMENT IS MOUNTED WITH #8 MIN AWG INSULATED COPPER BONDING JUMPERS PER NEC.
- 3.12 CONTRACTOR SHALL IDENTIFY THE END OF ALL SPARE UNDERGROUND CONDUITS AND PROVIDE AND INSTALL 90 DEGREE ELBOWS WITH VERTICAL CONDUIT EXTENSIONS TO EXTEND 3" ABOVE FINISHED CRUSHED AGGREGATE GRADE. CONTRACTOR SHALL TERMINATE CONDUITS WITH MANUFACTURED CONDUIT CAPS THAT THE CONTRACTOR HAS PAINTED ORANGE.
- 3.13 CONTRACTOR SHALL PROVIDE AND INSTALL AN ENGRAVED PHENOLIC PLATE ON THE FRONT OF THE INTEGRATED LOAD CENTER. THE WORDING ON THE PLATE SHALL READ AS FOLLOWS: "MAXIMUM DRAW OF ALL RECTIFIERS AND EQUIPMENT ON THE LOAD CENTER CANNOT EXCEED 50kW. IF ADDITIONAL POWER IS REQUIRED, THE EXISTING 50kW GENERATOR MUST BE REPLACED."


## 4.00 PRE-CONSTRUCTION COORDINATION

- 4.01 CONTRACTOR SHALL VISIT THE SITE PRIOR TO BID AND NOTE EXISTING CONDITIONS THAT MIGHT AFFECT THEIR WORK. ALL SUCH CONDITIONS SHALL BE REPORTED TO THE ENGINEER PRIOR TO BID.
- 4.02 THE CONTRACTOR SHALL PROVIDE A UTILITY LOCATOR AND SHALL VERIFY THE ACTUAL LOCATION OF ALL UTILITIES PRIOR TO CONSTRUCTION. THE CONTRACTOR SHALL BE RESPONSIBLE FOR PROTECTING ALL EXISTING UTILITIES. ANY DAMAGE TO EXISTING UTILITIES SHALL BE REPAIRED AT THE CONTRACTOR'S EXPENSE.
- 4.03 CONTRACTOR SHALL VERIFY, PRIOR TO ROUGH-IN, THAT SITE CONDITIONS ALLOW FOR THE PLACEMENT OF THE ELECTRICAL EQUIPMENT AS SHOWN ON THE PLANS.
- 4.04 CONTRACTOR SHALL COORDINATE WITH LOCAL ELECTRICAL UTILITY REGARDING THE EXACT LOCATION OF THE TRANSFORMER, ALL METERING REQUIREMENTS, AND CONDUIT ROUTING BETWEEN TRANSFORMER AND METER.
- 4.05 CONTRACTOR SHALL COORDINATE WITH LOCAL TELCO UTILITY REGARDING THE EXACT LOCATION OF THE TELCO SERVICE ENTRY POINT.
- 4.06 CONTRACTOR SHALL COORDINATE WITH AUTHORITY HAVING JURISDICTION REGARDING LOCAL FROST LINE REQUIREMENTS FOR RACEWAY MATERIAL SELECTION AND INSTALLATION.
- 4.07 CONTRACTOR SHALL PERFORM AN ARC FLASH ANALYSIS AT THE INTEGRATED LOAD CENTER AND PROVIDE ARC FLASH LABEL PER NEC.
- 4.08 ALL CIRCUIT BREAKERS AND EQUIPMENT SHALL HAVE A MINIMUM AIC RATING OF 10,000 AMPS. IF THE RATING OF THE UTILITY TRANSFORMER PROVIDING THE ELECTRICAL SERVICE IS GREATER THAN 75 kVA, THE CONTRACTOR SHALL PERFORM A SHORT CIRCUIT ANALYSIS TO DETERMINE THE REQUIRED AIC RATING FOR THE CIRCUIT BREAKERS AND EQUIPMENT. PRIOR TO PURCHASING EQUIPMENT, THE CONTRACTOR SHALL CONTACT THE ELECTRIC UTILITY AND OBTAIN IN WRITING THE MAXIMUM AVAILABLE FAULT CURRENT (AFC) AT THE UTILITY SERVICE POINT. PROVIDE MAX. AFC SIGNAGE AS REQUIRED PER NEC 110.24. THE CONTRACTOR SHALL ENSURE ALL ELECTRICAL EQUIPMENT, CIRCUIT BREAKERS, DISCONNECTS, FUSES, AND PANELBOARDS HAVE A FAULT CURRENT INTERRUPTING RATING GREATER THAN THE AVAILABLE FAULT CURRENT.




PROJECT INFORMATION:  
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 HENDERSON COUNTY TOWER  
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PLANS PREPARED BY:  
  
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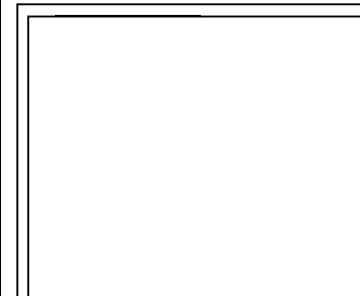
SHEET TITLE:  
**ELECTRICAL NOTES**

SHEET NUMBER:  
 E1

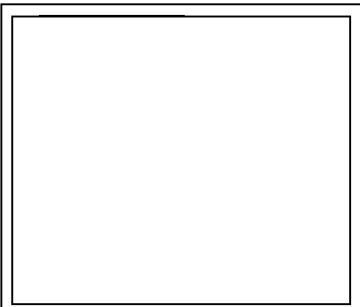

PROJECT INFORMATION:  
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 HENDERSON COUNTY TOWER  
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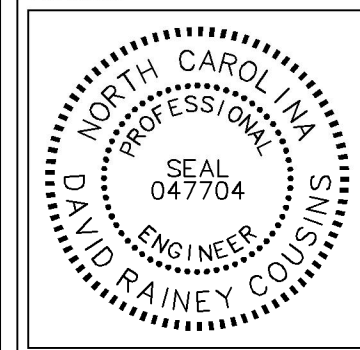
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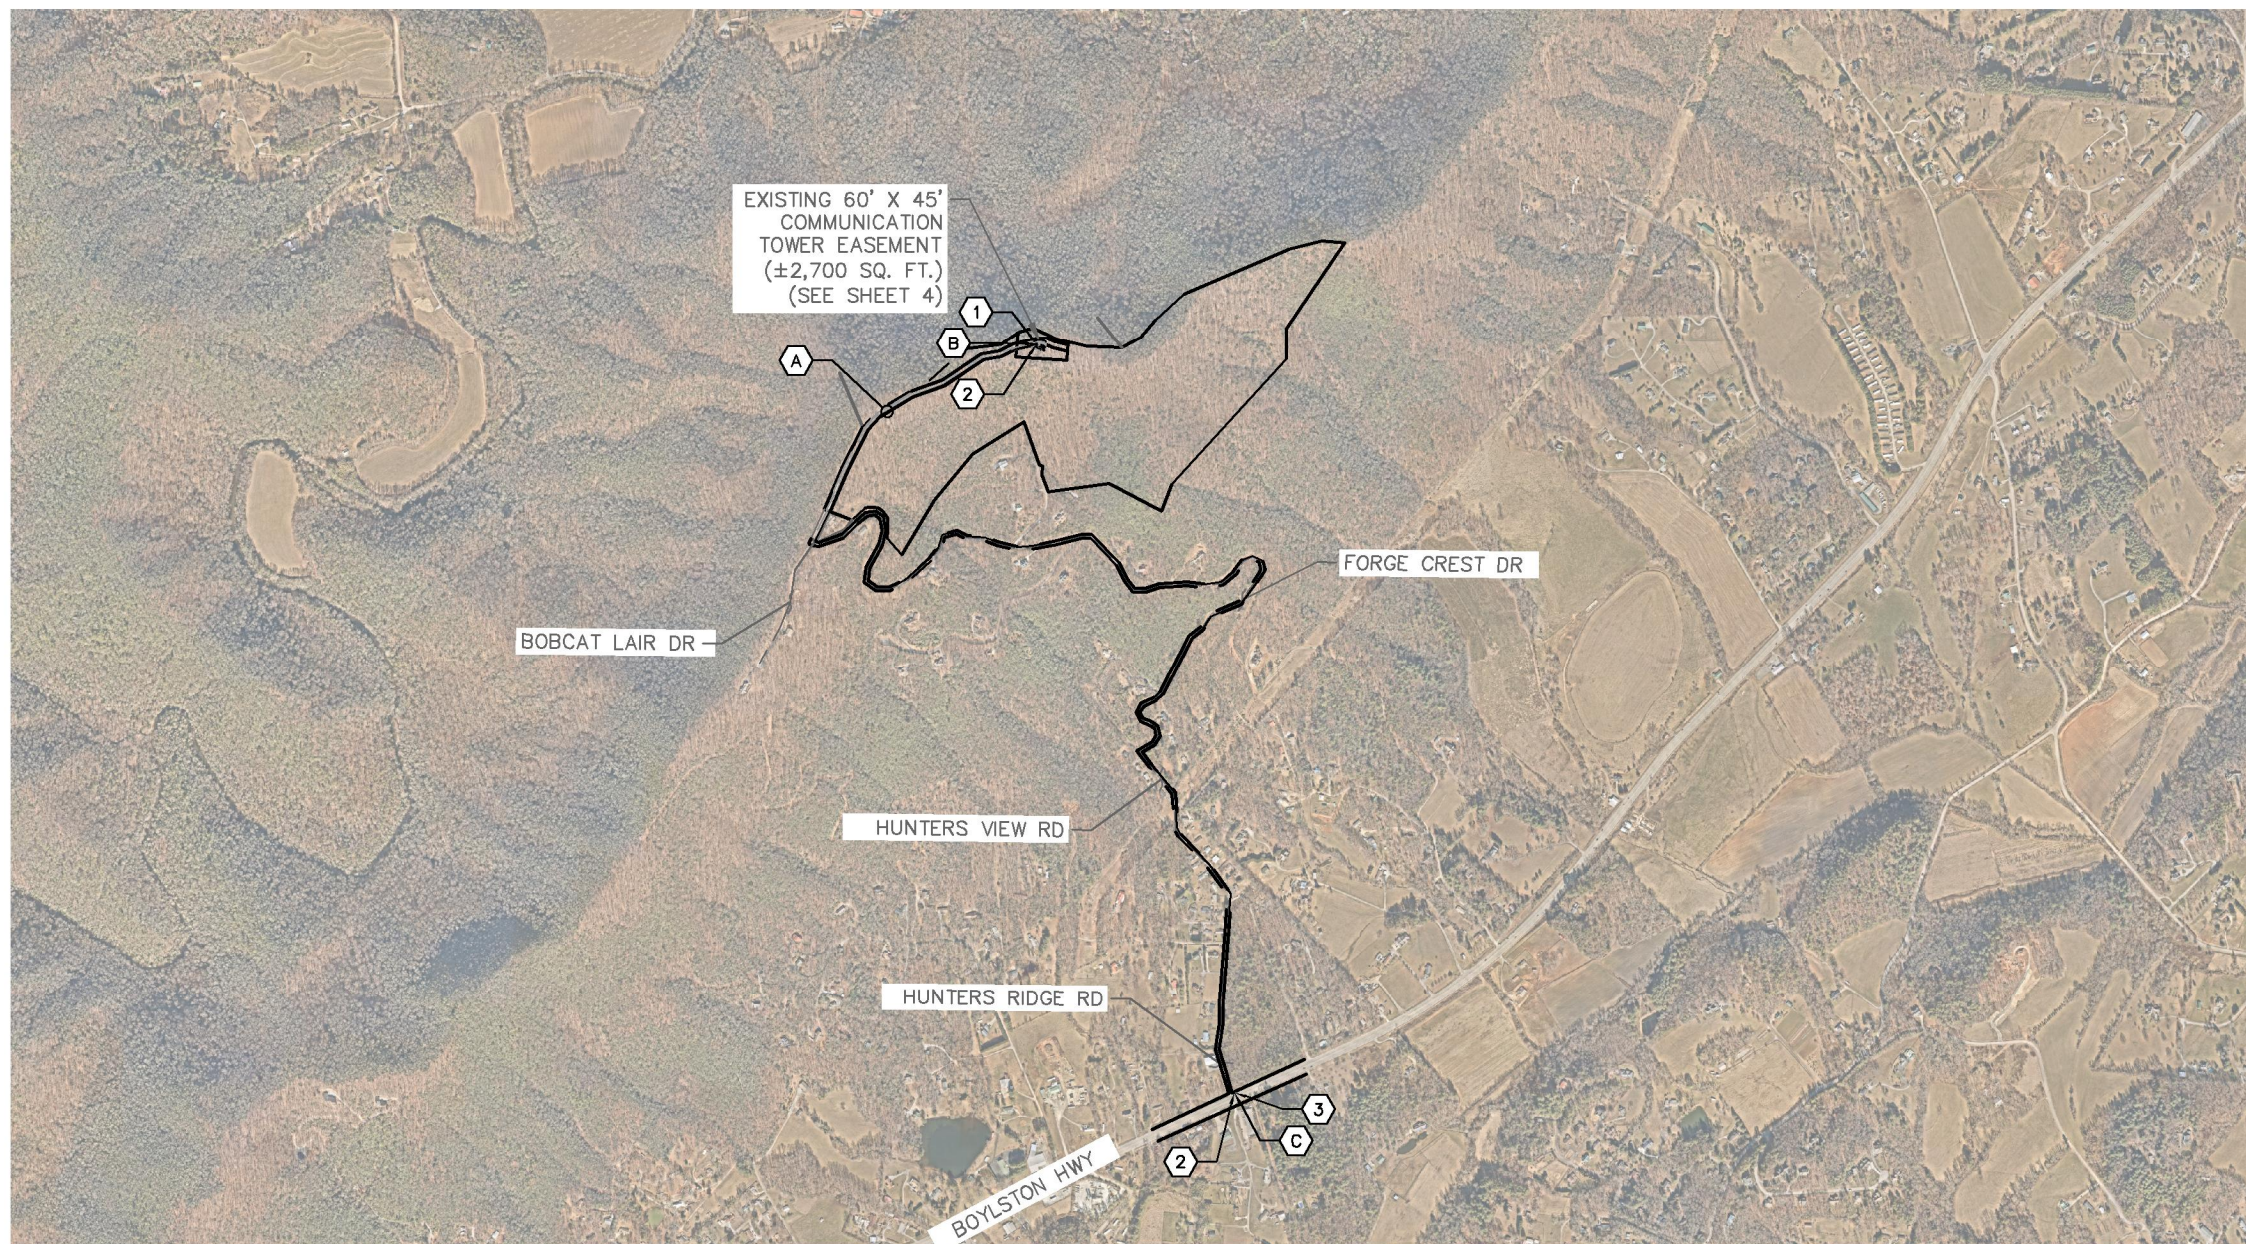
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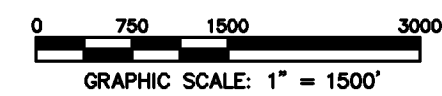
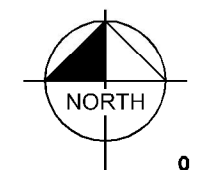
**OVERALL UTILITY SERVICE ROUTING PLAN**

SHEET NUMBER:

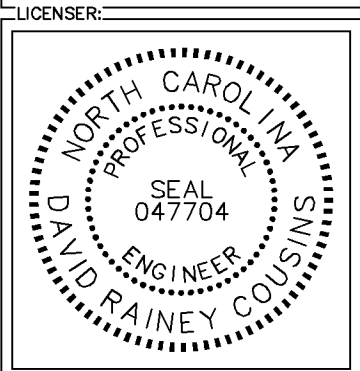E2



**1 OVERALL UTILITY SERVICE ROUTING PLAN**  
 E2 SCALE: 1" = 1,500'



**KEY NOTES - ELECTRICAL EQUIPMENT**

- ① EXISTING LIT-FIBER HANDHOLE/PEDESTAL.
- ② TRAFFIC RATED TELCO VAULT LABELED "VZW FIBER". (SPACED EVERY 500', AT MAJOR TRANSITIONS, AND AS NEEDED TO ALLOW DARK FIBER TO BE PULLED)(SEE NOTE 4.05 ON SHEET E1)
- ③ EXISTING ONE FIBER HANDHOLE (CONTRACTOR TO CONFIRM EXISTENCE AND LOCATION)

**KEY NOTES - CONDUIT, CONDUCTORS, & MISC.**

- A TWO (2) 2" PVC CONDUIT FOR "VZW FIBER" WITH TWO (2) PULL ROPES. (SEE DETAIL 2/E3); (APPROXIMATELY 12,274± LF); GENERAL CONTRACTOR TO CONFIRM NEED FOR CONDUITS TO RIGHT OF WAY AND HANDHOLE AT RIGHT OF WAY WITH VERIZON CONSTRUCTION MANAGER.
- B 4" PVC BRIDGE FIBER CONDUIT. (IF NO EXISTING LIT FIBER HANDHOLE/PEDESTAL IS PRESENT CONTRACTOR TO PROVIDER A 5' LONG CAPPED STUB BRIDGE CONDUIT).
- C 4" PVC BRIDGE FIBER CONDUIT. (IF NO EXISTING ONE FIBER HANDHOLE IS PRESENT, BRIDGE CONDUIT WILL BE BY OTHERS)

**NOTES:**

GENERAL CONTRACTOR IS TO CONFIRM WITH VERIZON CONSTRUCTION MANAGER WHETHER INSTALLATION OF THE TWO (2) 2" CONDUITS WILL BE PART OF THE INITIAL CONSTRUCTION.  
 PROPOSED VERIZON TELCO VAULT WITHIN RIGHT OF WAY LOCATED APPROXIMATELY 35' 20" 56.50"N, 82' 36" 51.30"W BASED ON GOOGLE EARTH IMAGERY.

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PLANS PREPARED BY:


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LICENSER:



KHA PROJECT NUMBER:

017848000

DRAWN BY: CHECKED BY:

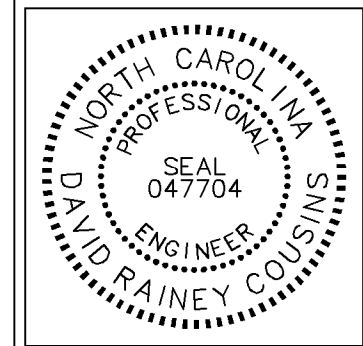XQD

DMF

SHEET TITLE:

UTILITY SERVICE  
 ROUTING PLAN

SHEET NUMBER:

E2.1

**KEY NOTES - ELECTRICAL EQUIPMENT**


- ① EXISTING LIT FIBER HANDHOLE/PEDESTAL. (CONTRACTOR TO CONFIRM EXISTENCE AND LOCATION).
- ② TRAFFIC RATED TELCO VAULT LABELED "VZW FIBER". (SEE NOTE 4.05 ON SHEET E1)
- ③ PROPOSED METER RACK (SEE SHEET E3.1)
- ④ VERIZON CONCRETE EQUIPMENT PAD (SEE SHEET C6).
- ⑤ VERIZON CONCRETE GENERATOR PAD (SEE SHEET C6).

**KEY NOTES - CONDUIT, CONDUCTORS, & MISC.**



- Ⓐ 4" PVC BRIDGE FIBER CONDUIT. (IF NO EXISTING LIT FIBER HANDHOLE/PEDESTAL IS PRESENT CONTRACTOR TO PROVIDE A 5' LONG CAPPED STUB BRIDGE CONDUIT).
- Ⓑ TWO (2) 2" PVC TELCO CONDUIT, WITH TWO (2) PULL ROPES. CONDUIT TO BE STUBBED UP 36" AND CAPPED AT EQUIPMENT RACK (SEE TRENCH DETAIL 2/E5).
- Ⓒ 2" PVC POWER CONDUIT FROM NEW METER RACK TO EQUIPMENT RACK. CONDUIT TO BE STUBBED UP 36" AND CAPPED. (SEE TRENCH DETAIL 2/E5).
- Ⓓ 2" PVC CONDUIT FOR ROUTING POWER CONDUCTOR TO THE GENERATOR. CONDUIT TO BE STUBBED UP 18" AND CAPPED. (SEE TRENCH DETAIL 2/E5).
- Ⓔ 1" PVC CONDUIT FOR ROUTING GENERATOR CONTROL AND ALARM SIGNAL CABLES TO THE GENERATOR. CONDUIT TO BE STUBBED UP 18" AND CAPPED. (SEE TRENCH DETAIL 2/E5).
- Ⓕ 1" PVC CONDUIT FOR ROUTING POWER CONDUCTOR TO THE GENERATOR BATTERY CHARGER AND THE GENERATOR BLOCK HEATER. CONDUIT TO BE STUBBED UP 18" AND CAPPED. (SEE TRENCH DETAIL 2/E5).
- Ⓖ TWO (2) 2" PVC CONDUITS FROM RIGHT OF WAY W/TWO (2) PULL ROPES (SEE TRENCH DETAIL 2/E5 AND SHEET E2).

**NOTES:**

GENERAL CONTRACTOR IS TO CONFIRM WITH VERIZON CONSTRUCTION MANAGER WHETHER INSTALLATION OF THE TWO (2) 2" CONDUITS TO THE RIGHT OF WAY WILL BE PART OF THE INITIAL CONSTRUCTION.

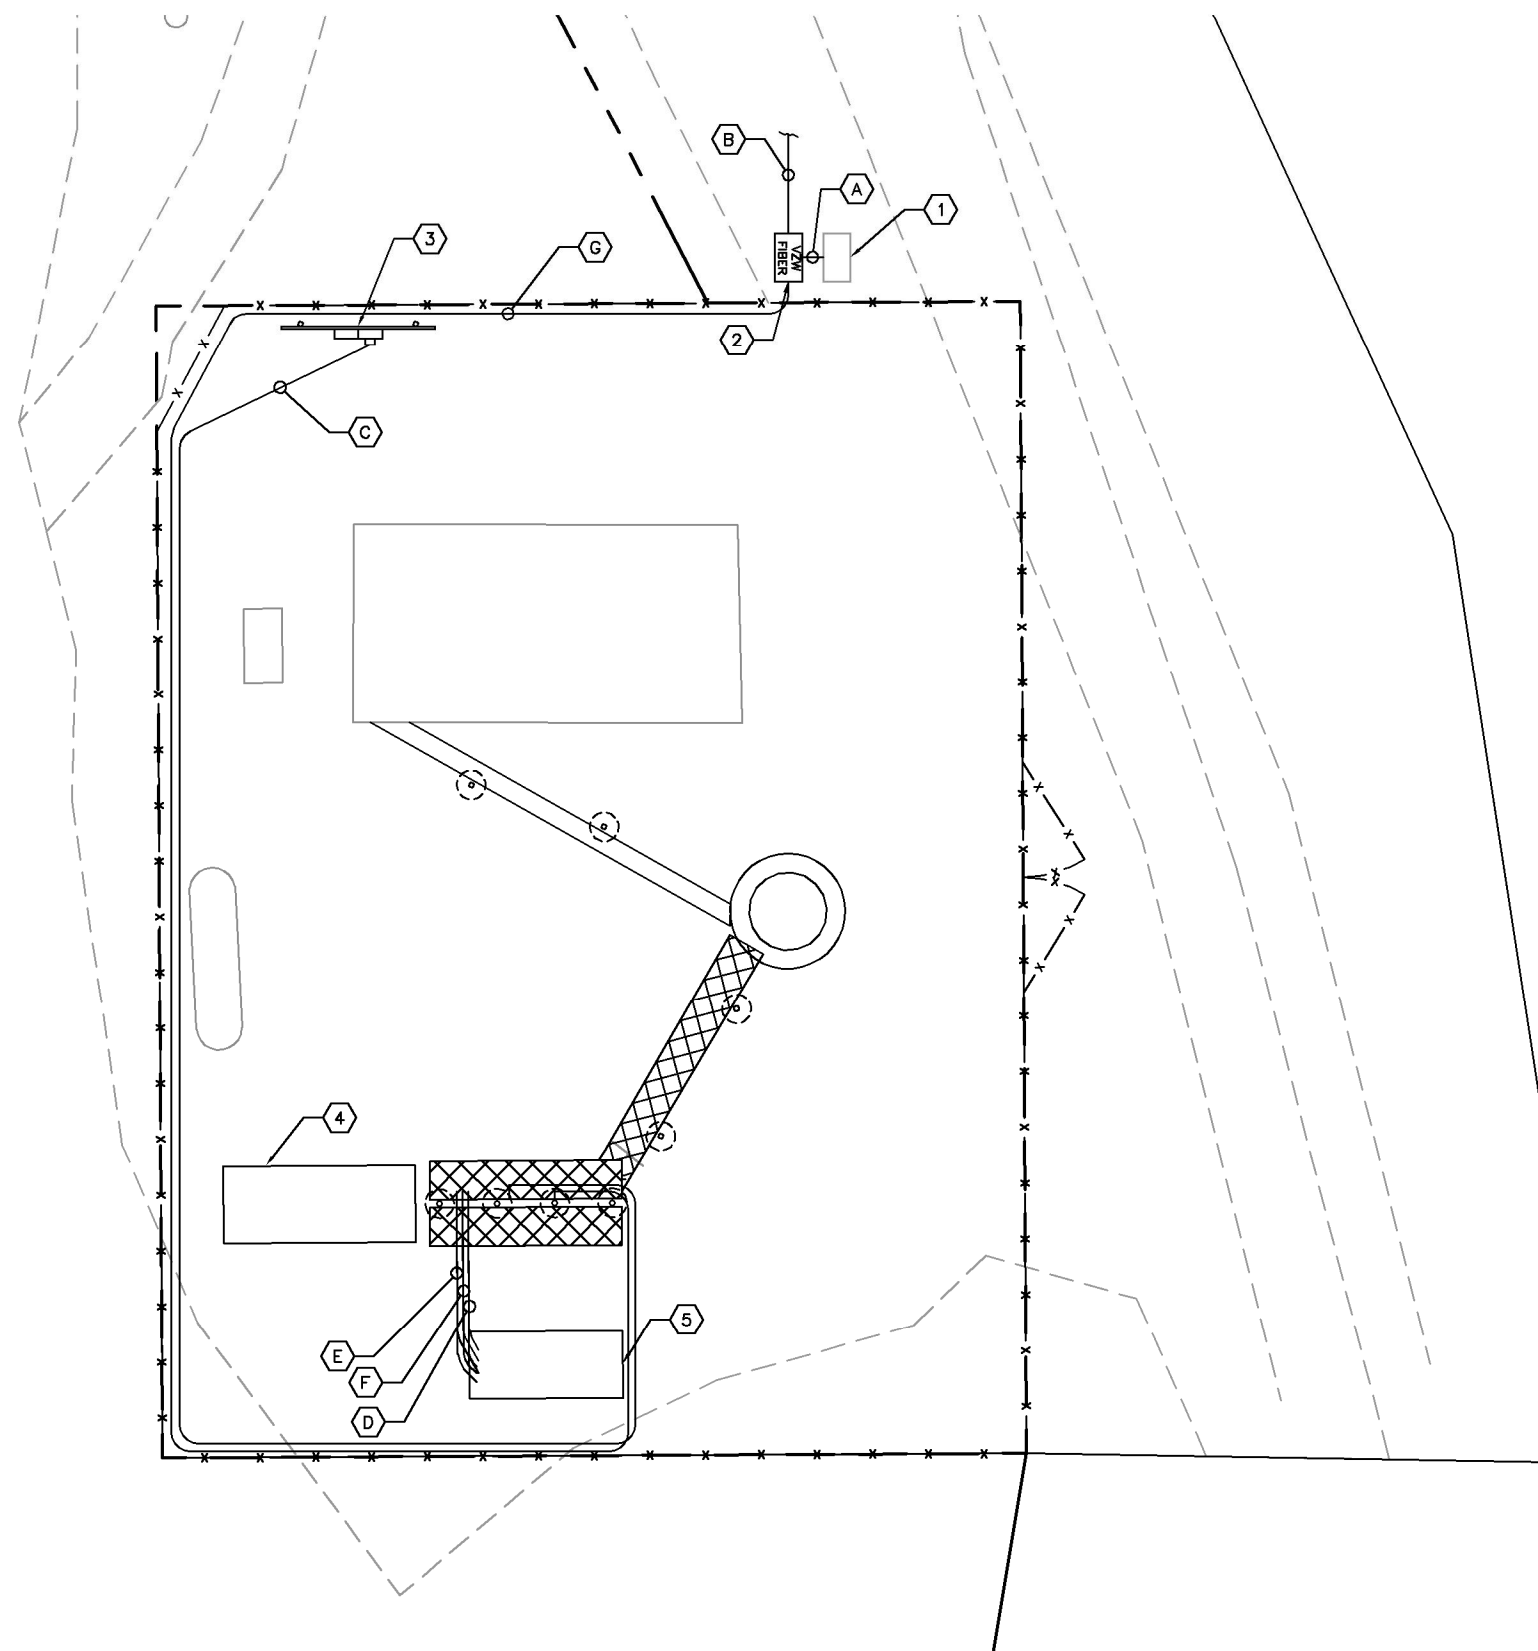

**1** UTILITY SERVICE ROUTING PLAN  
 E2.1 SCALE: 1" = 10'

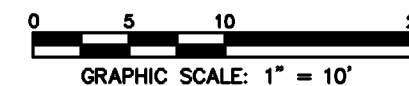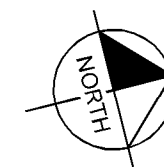

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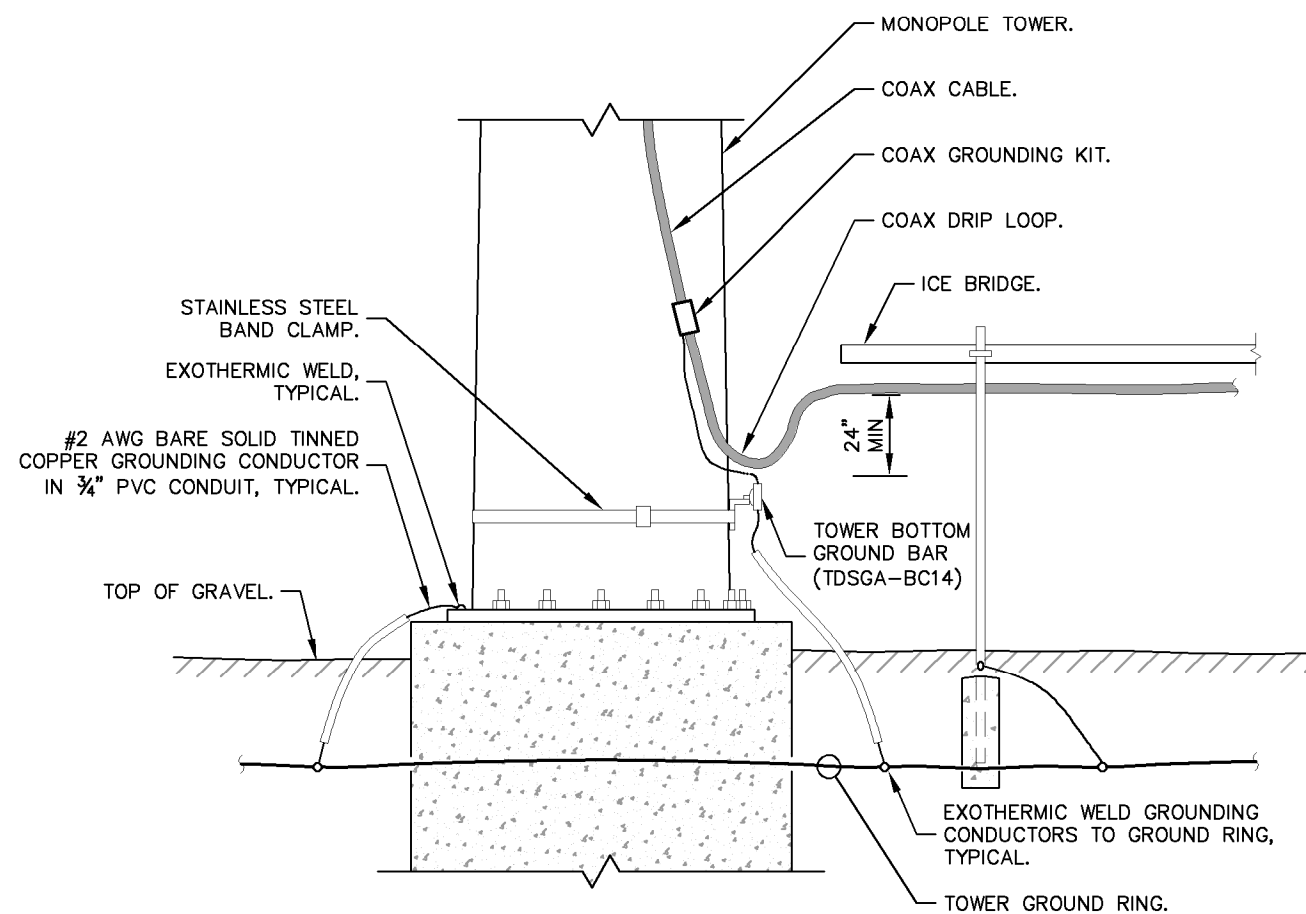
PROJECT INFORMATION:

SITE NAME:  
 HENDERSON COUNTY TOWER  
 SITE No.: 639642  
 PROJECT #: 20202154476  
 469 S FORGE CREST DR  
 MILLS RIVER, NC 28759  
 HENDERSON COUNTY


PLANS PREPARED BY:

**Kimley»Horn**

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**1** DRIP LOOP DETAIL  
 E3 NOT TO SCALE




- NOTES:
1. IF GROUND SURFACE IS OTHER THAN NEWLY GRAVELED AREA. CONTRACTOR IS TO RESTORE TO ORIGINAL CONDITION.
  2. PROVIDE PVC CONDUIT BELOW GRADE EXCEPT AS NOTED BELOW.
  3. PROVIDE SCHEDULE 40 OR SCHEDULE 80 PVC CONDUIT & ELBOWS AT STUB UP LOCATIONS (I.E. POLES, EQUIPMENT, ETC.)
  4. PROVIDE SCHEDULE 80 PVC CONDUIT BELOW PARKING LOTS AND ROADWAYS.

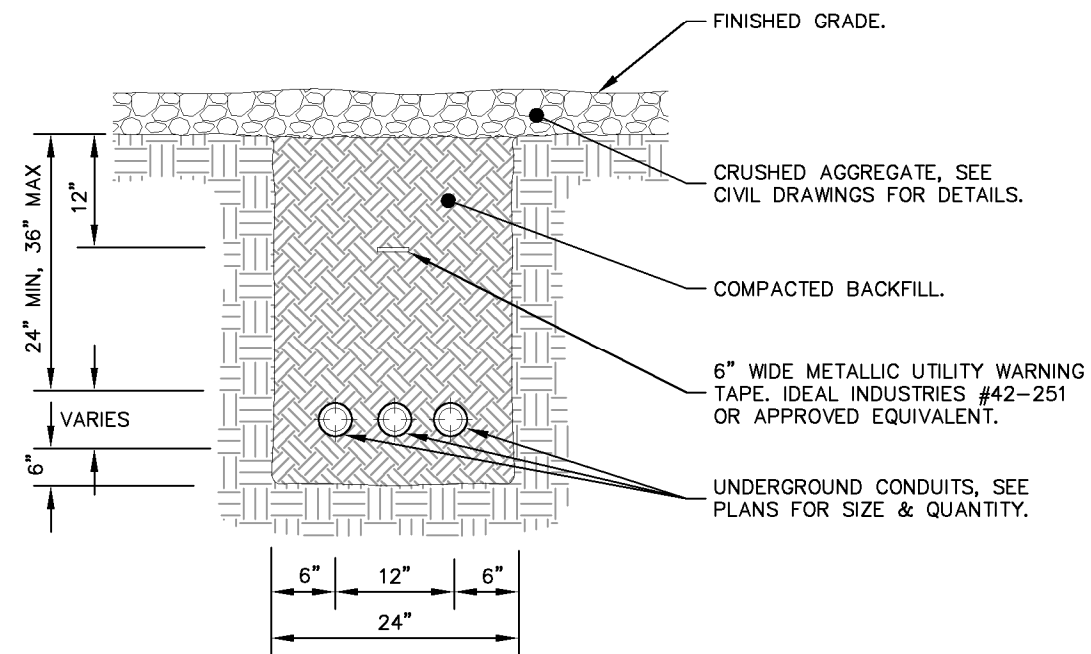**2** TYPICAL TRENCH DETAIL  
 E3 NOT TO SCALE

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LICENSER:



KHA PROJECT NUMBER:

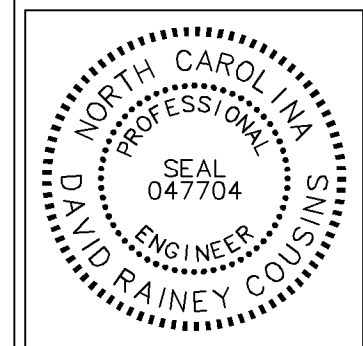017848000

DRAWN BY: \_\_\_\_\_ CHECKED BY: \_\_\_\_\_

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SHEET TITLE:

**ELECTRICAL  
 DETAILS**


SHEET NUMBER:

**E3**



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 HENDERSON COUNTY TOWER  
 SITE No.: 639642  
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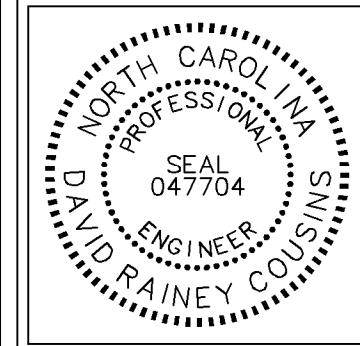
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LICENSER: \_\_\_\_\_

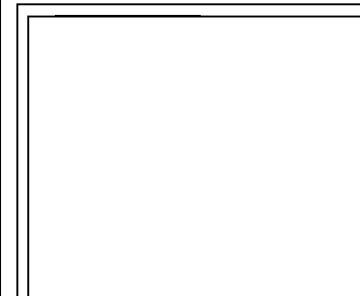

KHA PROJECT NUMBER:  
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DRAWN BY: XQD CHECKED BY: DMF

SHEET TITLE:

**METER RACK  
 DETAILS**


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**KEY NOTES - CONDUIT, CONDUCTORS, & MISC**

- (A) GALVANIZED RIGID STEEL CAP, TYPICAL.
- (B) 3" GALVANIZED RIGID STEEL PIPE, TYPICAL.
- (C) 1 5/8" x 1 5/8" GALVANIZED STEEL CHANNEL (UNISTRUT #P1000 OR APPROVED EQUIVALENT) WITH PLASTIC END CAP (UNISTRUT #P2860), TYPICAL.
- (D) ONE (1) #2 AWG BARE SOLID TINNED COPPER BONDING CONDUCTORS (BC) FROM H-FRAME VERTICAL PIPE TO GROUND RING, EXOTHERMIC WELD BOTH ENDS.
- (E) 4" PVC CONDUIT FOR INCOMING SERVICE LATERALS FROM LOCAL UTILITY, TYPICAL OF 2.
- (F) KEYNOTE NOT USED.
- (G) 2" PVC CONDUIT FOR ROUTING FEEDERS TO NON-FUSED DISCONNECT SWITCH.
- (H) 3/4" PVC CONDUIT WITH ONE (1) - 2/0 BARE STRANDED TINNED COPPER GROUNDING ELECTRODE CONDUCTOR (GEC) FROM GROUNDING LUG TO GROUND ROD, EXOTHERMIC WELD GEC TO GROUND ROD.
- (J) GROUND RING (SEE "E" SHEETS).
- (K) GROUND ROD, EXOTHERMIC WELD TO GROUND RING. (SEE "E" SHEETS).
- (L) CONCRETE FOUNDATION FOR H-FRAME VERTICAL PIPE. CONCRETE SHALL HAVE A 28 DAY COMPRESSIVE STRENGTH OF 4,000 PSI. AND INCLUDE FIBERMESH 650-3E.

**KEY NOTES - ELECTRICAL EQUIPMENT**

- (1) 200 AMP METER SOCKET IN NEMA 3R ENCLOSURE, TYPICAL OF 4. ONLY TOP SOCKET WILL RECEIVE METER UNDER THIS CONTRACT.
- (2) 800 AMP, 22KAIC, 4 GANG, SERVICE ENTRANCE RATED METER CENTER IN NEMA 3R ENCLOSURE. BOND TO RACK PER NEC.
- (3) 200 AMP, 2 POLE (22KAIC) DISCONNECT CIRCUIT BREAKER FOR TOP METER ONLY. CONTRACTOR SHALL MOUNT THE METER CENTER SUCH THAT THE TOP CIRCUIT BREAKER IS NO MORE THAN 6' ABOVE GRADE.

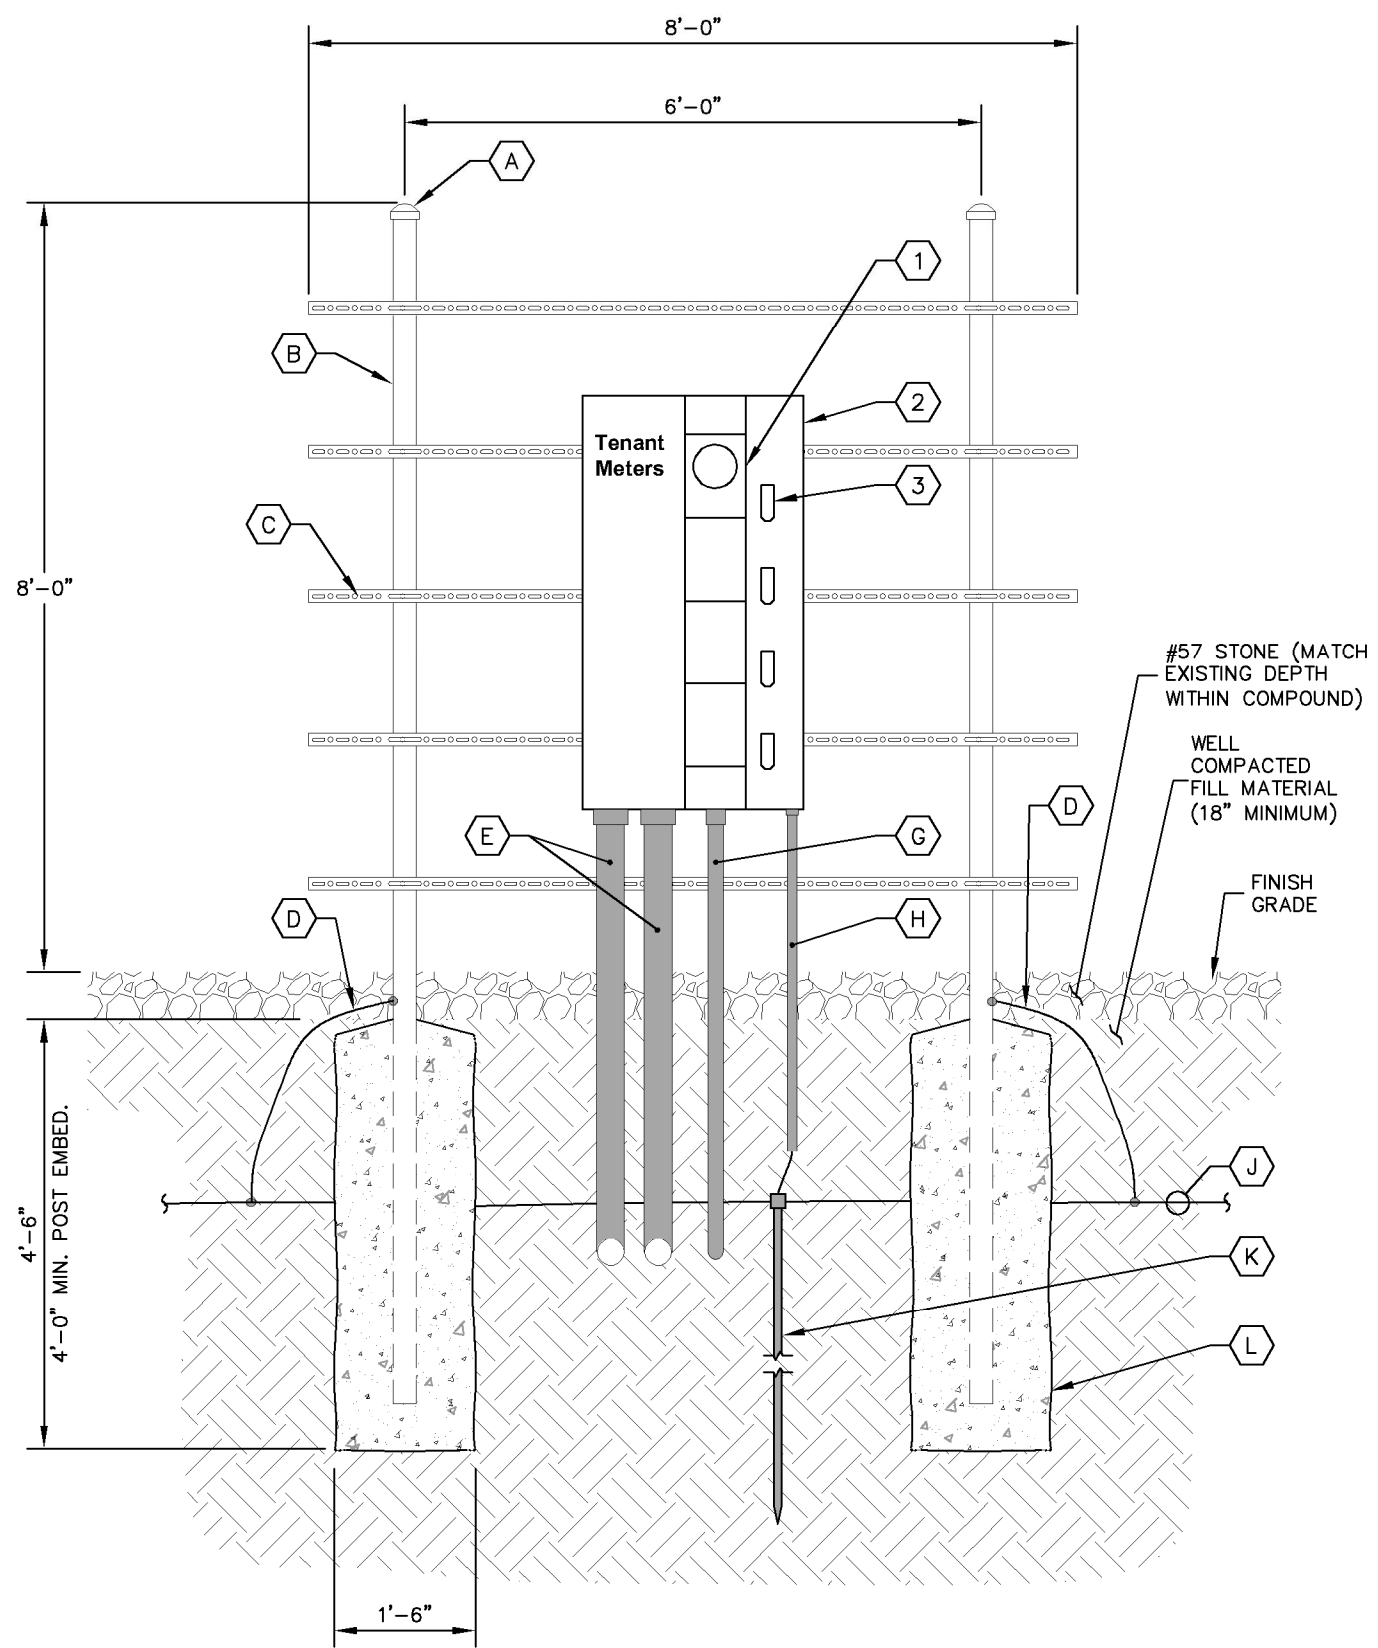

**1 METER RACK DETAILS**  
 E3.1 NOT TO SCALE

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# GROUNDING NOTES

1. THE GROUND RING SHALL CONSIST OF #2 AWG BARE SOLID TINNED COPPER (STC) CONDUCTOR, UNLESS NOTED OTHERWISE, BURIED AT 30" BELOW FINISHED GRADE (OR BELOW FROST LINE). LOCATE 24" MINIMUM AND 36" MAXIMUM FROM EQUIPMENT PAD AND FROM TOWER FOUNDATION. ALL CONNECTIONS SHALL BE MADE USING A PARALLEL TYPE EXOTHERMIC WELD, UNLESS NOTED OTHERWISE. WHERE THE GROUND RING DISTURBS EXISTING SITE GROUNDING, CONNECT GROUND RING TO EXISTING SITE CONDUCTORS SO AS TO MAINTAIN THE CONTINUITY OF THE EXISTING GROUND SYSTEM.
2. INSTALL GROUND RODS AS SHOWN AND AS REQUIRED. GROUND RODS TO BE COPPER CLAD STEEL, 5/8" DIAMETER AND 10FT IN LENGTH. SPACING BETWEEN GROUND RODS SHALL BE 10FT MINIMUM AND 15FT MAXIMUM. TOP OF GROUND ROD TO BE 30" MINIMUM BELOW GRADE (OR BELOW FROST LINE). BOND TOP OF GROUND ROD TO GROUND WIRE WITH EXOTHERMIC WELD. DO NOT EXOTHERMICALLY WELD ANYTHING TO GROUND ROD EXCEPT GROUND WIRE WHICH PASSES OVER TOP OF GROUND ROD (CLAMPED CONNECTIONS TO GROUND ROD PER TOWER MANUFACTURERS DETAILS ARE ACCEPTABLE).
3. EQUIPMENT GROUND RING SHALL HAVE A MINIMUM OF 4 GROUND RODS, INSTALLED AT THE CORNERS OF THE GROUND RING PLUS ADDITIONAL RODS AS REQUIRED TO COMPLY WITH THE SPACING REQUIREMENTS.
4. EQUIPMENT GROUND RING AND TOWER GROUND RING SHALL BE BONDED TOGETHER WITH TWO #2 STC GROUND LEADS, TYPICALLY ONE ON EACH SIDE OF ICE BRIDGE.
5. MINIMUM BEND RADIUS FOR #2 AWG GROUND WIRE IS 12", EXCEPT USE 24" FOR EQUIPMENT PAD GROUND RINGS.
6. GROUND ALL EXTERIOR EXPOSED METAL OBJECTS. USE TWO HOLE LUGS FOR CONNECTION TO FLAT METAL SURFACES. USE ONLY STAINLESS STEEL HARDWARE ON ALL MECHANICAL CONNECTIONS. CLEAN ALL SURFACES (AND STRIP PAINTED SURFACES) TO BARE BRIGHT METAL PRIOR TO MAKING GROUND CONNECTIONS. APPLY ANTI-OXIDE COMPOUND TO ALL CONNECTIONS. APPLY ZINC RICH PAINT (COLD GALV.) TO ALL EXOTHERMIC WELDS, AND TO ANY METAL EXPOSED BY CLEANING, STRIPPING, GRINDING, CUTTING OR DRILLING.
7. ALL GROUNDING CONDUCTORS ABOVE GRADE SHALL BE RUN IN 3/4" FLEXIBLE PVC CONDUIT. CONDUIT SHALL BEGIN WITHIN 3/4" OF ABOVE GROUND CONNECTION POINT, SHALL EXTEND 24" BELOW GRADE MINIMUM, AND SHALL BE FILLED WITH SEALANT AT ABOVE GROUND CONNECTION POINT. SECURE CONDUIT EVERY 24" ON VERTICAL RUNS AND EVERY 36" ELSEWHERE WITH NON-METALLIC TIES.
- 8A. AT GUYED AND SELF SUPPORT TOWERS MOUNT TDSGA-PA14 TOWER BOTTOM GROUND BAR ON DEDICATED POST DIRECTLY BELOW COAX CABLES COMING OFF TOWER. POST TO BE 3.5" OD GALVANIZED SCHEDULE 40 PIPE WITH GALVANIZED PIPE CAP. TOP OF POST TO BE 78" ABOVE GRADE. EMBED POST 30" MINIMUM IN 12" DIAMETER BY 36" DEEP MINIMUM CONCRETE FOOTING WITH TOP OF FOOTING 6" BELOW GRADE. IF TOWER FOUNDATION OBSTRUCTS AUGERED FOOTING, USE POST WITH 10" SQUARE GALVANIZED STEEL FLANGE PLATE WELDED TO BOTTOM AND BOLT FLANGE TO TOP OF CONCRETE TOWER FOOTING.
- 8B. AT MONOPOLE TOWERS CLAMP TDSGA-BC14 TOWER BOTTOM GROUND BAR DIRECTLY TO TOWER. IF RUNNING COAX INSIDE MONOPOLE, CLAMP ONTO BOTTOM LIP OF EXIT PORT. IF BANDING COAX TO OUTSIDE OF TOWER, CLAMP ONTO STEEL ANGLE WHICH IS BANDED TO TOWER. BOND TDSGA-BC14 TO TOWER GROUND RING WITH TWO #2 STC LEADS LUGGED TO GROUND BAR AND EXOTHERMICALLY WELDED TO GROUND RING.
9. AT EQUIPMENT AREA, INSTALL TDSGA-PA14 EXTERIOR GROUND BAR (THRU-BOLTED STYLE) AT BASE OF (2) INTERIOR H-FRAME POSTS AND AT TOP OF ICE BRIDGE POST WHICH IS NEAREST TO (BUT CLOSER TO TOWER THAN) THE COAX CABLE TERMINATION. MOUNT GROUND BAR TO H-FRAME POSTS AT 6" ABOVE GRAVEL AND TO ICE BRIDGE POST AT 6FT ABOVE GRAVEL.
10. ALL ICE BRIDGE SECTIONS ARE TO BE JUMPERED TOGETHER WITH #2 WIRE, EITHER BARE TINNED COPPER OR GREEN INSULATED STRANDED. ICE BRIDGE SHALL BE GROUNDED AT EACH END WITH #2 STC WIRE LUGGED TO ICE BRIDGE AND EXOTHERMICALLY WELDED TO UPPER PORTION OF NEAREST ICE BRIDGE POST. ICE BRIDGE SECTIONS ABOVE H-FRAME SHALL BE BONDED TO EACH OTHER WITH JUMPERS AT EACH END - THIS ASSEMBLY WILL BE CONSIDERED AS A SINGLE ICE BRIDGE SECTION FOR GROUNDING PURPOSES.
11. BOND EACH ICE BRIDGE POST, H-FRAME POST OR DEDICATED GROUNDING POST TO BURIED GROUNDING SYSTEM WITH #2 STC LEAD EXOTHERMICALLY WELDED TO POST BELOW TOP OF GRAVEL AND EXOTHERMICALLY WELDED TO GROUND RING. EACH POST TO HAVE SEPARATE GROUND LEAD DIRECTLY TO GROUND RING - DO NOT DAISY CHAIN POSTS TOGETHER.
12. BOND EACH RF CABINET TO EQUIPMENT GROUND RING WITH #2 AWG TINNED SOLID BARE COPPER CONDUCTOR LUGGED TO CABINET BODY AND EXOTHERMICALLY WELDED TO GROUND RING. LUG TO CABINET BODY USING LOCATION AT WHICH STUDS ON CABINET CHASSIS HAVE DIRECT GROUND WIRE CONNECTION TO CABINET INTERNAL GROUND BAR. RUN CONDUIT AND CONDUCTOR ACROSS BACK OF CABINET (DO NOT RUN TOWARDS NEAREST CORNER OF CABINET AND THEN BEND GROUND WIRE SHARPLY), ACROSS CONCRETE PAD BELOW CABLE LADDER, THEN DOWN INTO GRAVEL AREA.
13. BOND EACH BATTERY CABINET TO GROUND RING WITH #2 AWG TINNED SOLID BARE COPPER CONDUCTOR LUGGED TO CABINET BODY AND EXOTHERMICALLY WELDED TO GROUND RING. RUN GROUND LEAD IN FLEX CONDUIT ALONG BACK OF RBA72 CABINET, ACROSS CONCRETE PAD BELOW CABLE LADDER, THEN DOWN INTO GRAVEL AREA. CONNECT TWO HOLE LUG TO BACK OF CABINET AT FACTORY PROVIDED GROUNDING STUDS.
14. BOND GENERATOR TO GROUND RING WITH #2 STC AT TWO DIAGONALLY OPPOSITE LOCATIONS BY DRILLING AND BOLTING TWO HOLE LUG TO FINS ON GENERATOR BASE STRUCTURE. GROUND LEADS SHOULD TAKE SHORTEST PATH ACROSS CONCRETE PAD TO GRAVEL AREA, THEN CONTINUE TO GROUND RING.
15. WHERE PROPANE TANK IS INSTALLED TO FUEL GENERATOR, BOND PROPANE TANK TO GROUND RING WITH A SINGLE #2 STC CLAMPED TO FILLER PIPE OF PROPANE TANK AND EXOTHERMICALLY WELDED TO GROUND RING. GROUND LEAD SHOULD RUN TO TANK SUPPORT AND TAKE SHORTEST PATH ACROSS CONCRETE PAD TO GRAVEL AREA, THEN CONTINUE TO GROUND RING. IF PROPANE TANK FUEL LINE IS METALLIC AND CROSSES EQUIPMENT GROUND RING, BOND FUEL LINE TO EQUIPMENT GROUND RING WHERE THE TWO LINES CROSS WITH A SINGLE #2 STC CLAMPED TO FUEL LINE AND EXOTHERMICALLY WELDED TO GROUND RING.
16. BOND GPS ANTENNA AND GPS ANTENNA MOUNT TO TSDGA GROUND BAR AT BOTTOM OF H-FRAME POST WITH #2 GREEN INSULATED STRANDED GROUND WIRE.
17. ANY METAL FENCE POST WITHIN 6FT OF A GROUNDED METAL OBJECT SHALL BE BONDED TO THE EQUIPMENT GROUND RING WITH #2 STC CLAMPED OR EXOTHERMICALLY WELDED TO THE POST AND EXOTHERMICALLY WELDED TO GROUND RING. ANY FENCE WITH METAL LINE POSTS WITHIN 6FT OF THE GROUND RING SHALL HAVE THE LINE POSTS BONDED TO THE GROUND RING WITH #2 STC WITH #2 STC CLAMPED OR EXOTHERMICALLY WELDED TO THE POST AND EXOTHERMICALLY WELDED TO GROUND RING AT 20FT MAXIMUM INTERVALS AS MEASURED ALONG THE LENGTH OF THE FENCE.
18. WHERE GROUND BASED RRU'S, RAYCAP OVP'S OR DIPLEXERS ARE INSTALLED AT THE EQUIPMENT AREA, BOND EACH COMPONENT TO NEAREST TDSGA GROUND BAR BELOW THE COMPONENT WITH #2 GREEN INSULATED STRANDED GROUND WIRE. SINGLE HOLE LUG OR RING TYPE CONNECTOR IS SUITABLE FOR CONNECTION TO GROUNDING STUD ON EACH COMPONENT.
19. NOTIFY VZW CM TO INSPECT GROUND RING BEFORE BACKFILLING. CONTRACTOR SHALL HIRE A 3RD PARTY TO PERFORM AN IEEE81 FALL OF POTENTIAL METHOD GROUND TEST. MAXIMUM ALLOWABLE RESISTANCE TO GROUND IS 5 OHMS. PROVIDE ADDITIONAL GROUND SYSTEM COMPONENTS AS REQUIRED TO ACHIEVE THIS VALUE.
20. REFER TO TOWER GROUNDING DIAGRAM AND NOTES FOR GROUND SYSTEM REQUIREMENTS ON THE TOWER.
21. GROUNDING OF ALL ELECTRICAL EQUIPMENT SHALL BE AS PER NEC MUNICIPAL AND UTILITY COMPANY REQUIREMENTS.



PROJECT INFORMATION:

SITE NAME:  
 HENDERSON COUNTY TOWER  
 SITE No.: 639642  
 PROJECT #: 20202154476  
 469 S FORGE CREST DR  
 MILLS RIVER, NC 28759  
 HENDERSON COUNTY

PLANS PREPARED BY:




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KHA PROJECT NUMBER:

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DRAWN BY: CHECKED BY:

XQD DMF

SHEET TITLE:

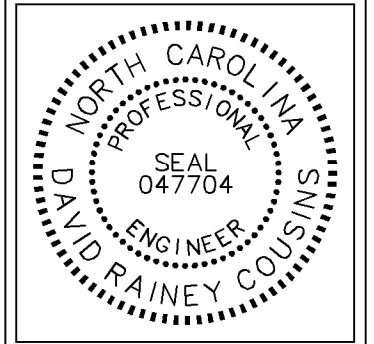GROUNDING NOTES


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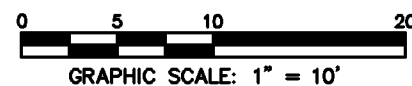
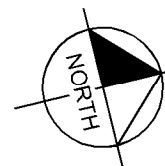
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**KEY NOTES - GROUNDING EQUIPMENT**

- (A) GROUND ROD TEST WELL (SEE DETAIL 1/E7).
- (B) GROUND ROD, TYPICAL (SEE DETAIL 2/E10 AND NOTES 2 AND 3 ON E4).
- (C) TOWER AND EQUIPMENT GROUND RING (SEE NOTES 1, 3, 4, 5, 6 AND 7 ON E4).
- (D) TDSGA-PA14 OR TDSGA-BC14 WHERE APPLICABLE (SEE NOTES 10 AND 11 ON E4).
- (J) ICE BRIDGE POST BOND TO GROUND RING, TYPICAL (SEE NOTES 12 AND 13 ON E4).
- (K) FENCE POST GROUNDING, TYPICAL (SEE NOTE 22 ON E4).
- (L) GATE GROUNDING, TYPICAL (SEE NOTES 19, 20 & 21 ON E4).
- (M) UTILITY H-FRAME GROUNDING, TYPICAL (SEE SHEET E3 AND NOTE 13 ON E4).
- (N) TOWER GROUNDING, TYPICAL (SEE NOTES 5, 6 & 25 ON E4).
- (P) GROUND RADIALS, TYPICAL (SEE NOTE 6 ON E4).
- (Q) REFER TO SHEETS E7, E9, E10 & E11 FOR GROUNDING NOTES, DETAILS, AND SPECIFICATIONS.

**1** GROUNDING PLAN  
**E5** SCALE: 1" = 10'



**LEGEND:**

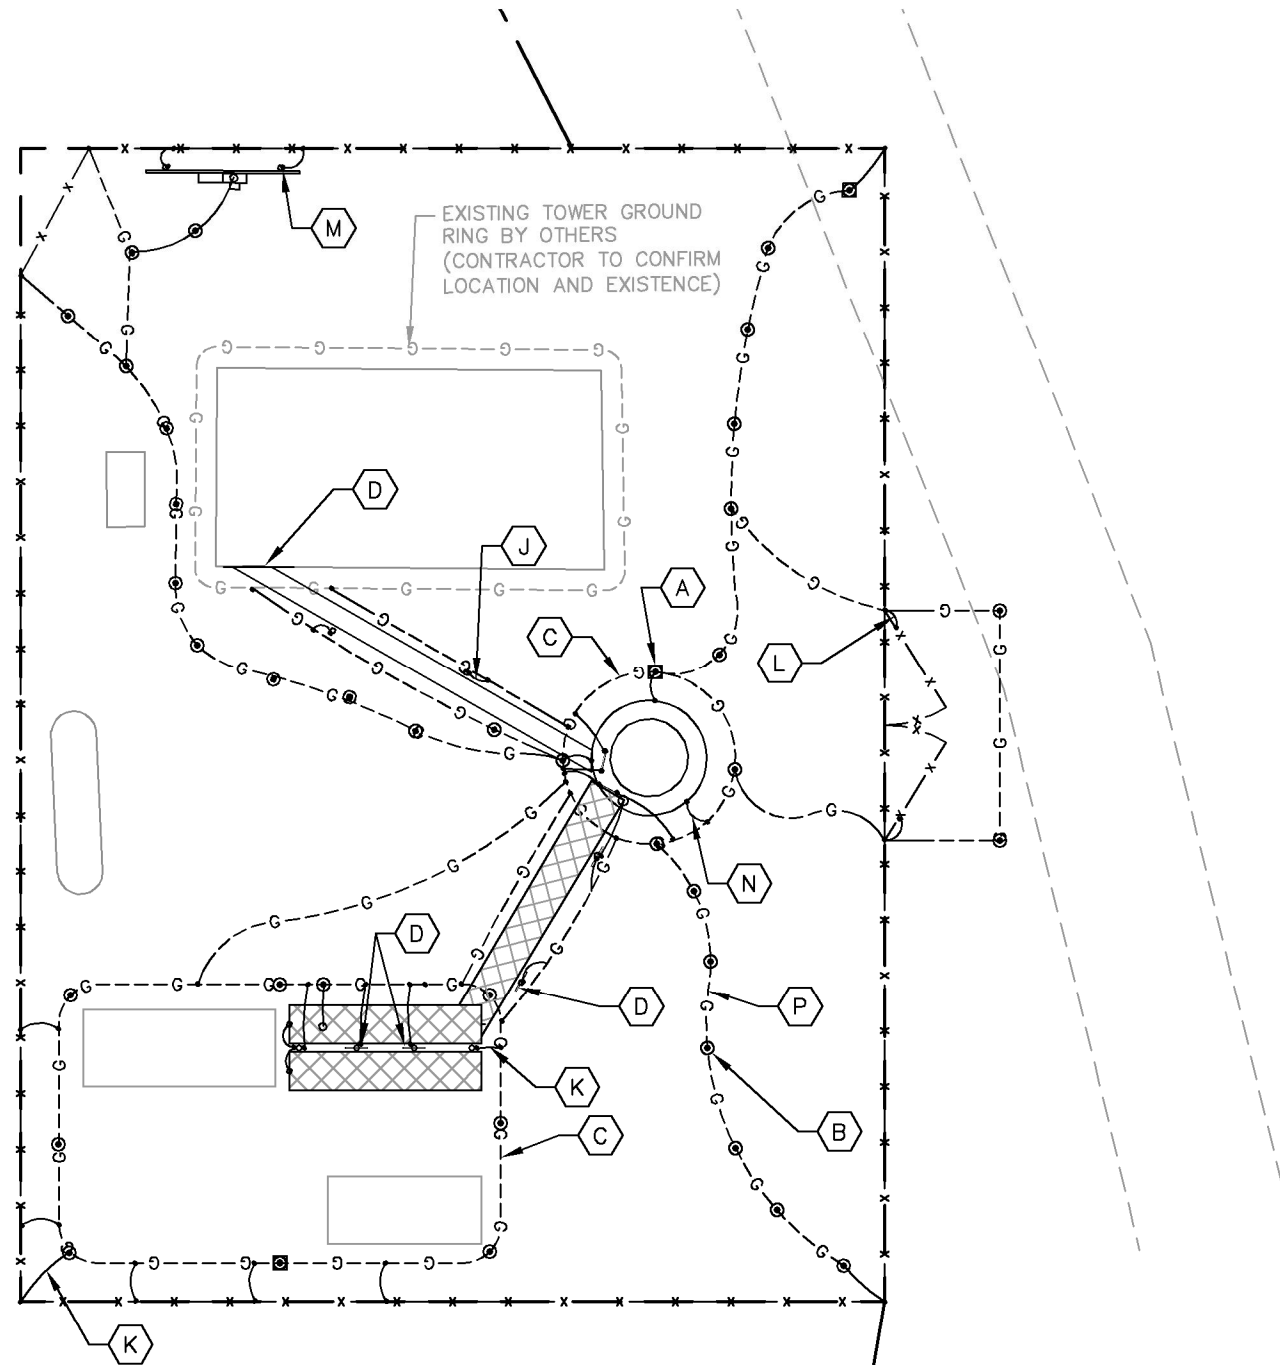
- G---G--- GROUND RING
- G⊙---G--- GROUND ROD EXOTHERMICALLY WELDED TO GROUND RING
- EXOTHERMIC WELD
- ⊙ GROUND ROD TEST WELL (SEE DETAIL 1/E10)
- MECHANICAL CONNECTION



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KHA PROJECT NUMBER:  
017848000

DRAWN BY: XQD CHECKED BY: DMF

SHEET TITLE:

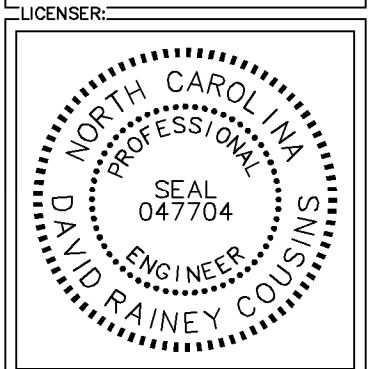
**GROUNDING PLAN**

SHEET NUMBER:  
**E5**

**KEY NOTES - ELECTRICAL EQUIPMENT**

- 1 #6 AWG INSULATED STRANDED COPPER.
- 2 #6 AWG INSULATED STRANDED COPPER. CONNECT COAX GROUND KITS DIRECTLY TO TOWER TOP CIGBE ONLY.
- 3 #2 AWG SOLID TINNED COPPER.
- 4 #2 AWG SOLID TINNED COPPER. (IF GROUNDING POST NOT AVAILABLE)
- 5 #2 AWG SOLID TINNED COPPER GROUND RING BURIED 30" BELOW GRADE.
- 6 TOWER ACTS AS CONDUCTOR.
- 7 TOWER GROUND BARS WILL BE ISOLATED FROM TOWER BUT BONDED TO TOWER WITH #2 AWG INSULATED STRANDED COPPER AND CLAMPED, OR EXOTHERMIC WELD, UNLESS OTHERWISE NOTED.
- 8 4/0 BRAIDED COPPER STRAP, EXOTHERMIC WELD TO BOTH GATE AND GATE POST.
- 9 BOND GROUND BAR TO GROUNDING POST USING THROUGH BOLT CONNECTION.
- 10 #2 AWG INSULATED STRANDED COPPER.


**NOTE:**  
1. HENDERSON COUNTY TO FURNISH AND INSTALL ANY GROUNDING REQUIRING GROUND DISTURBANCE.

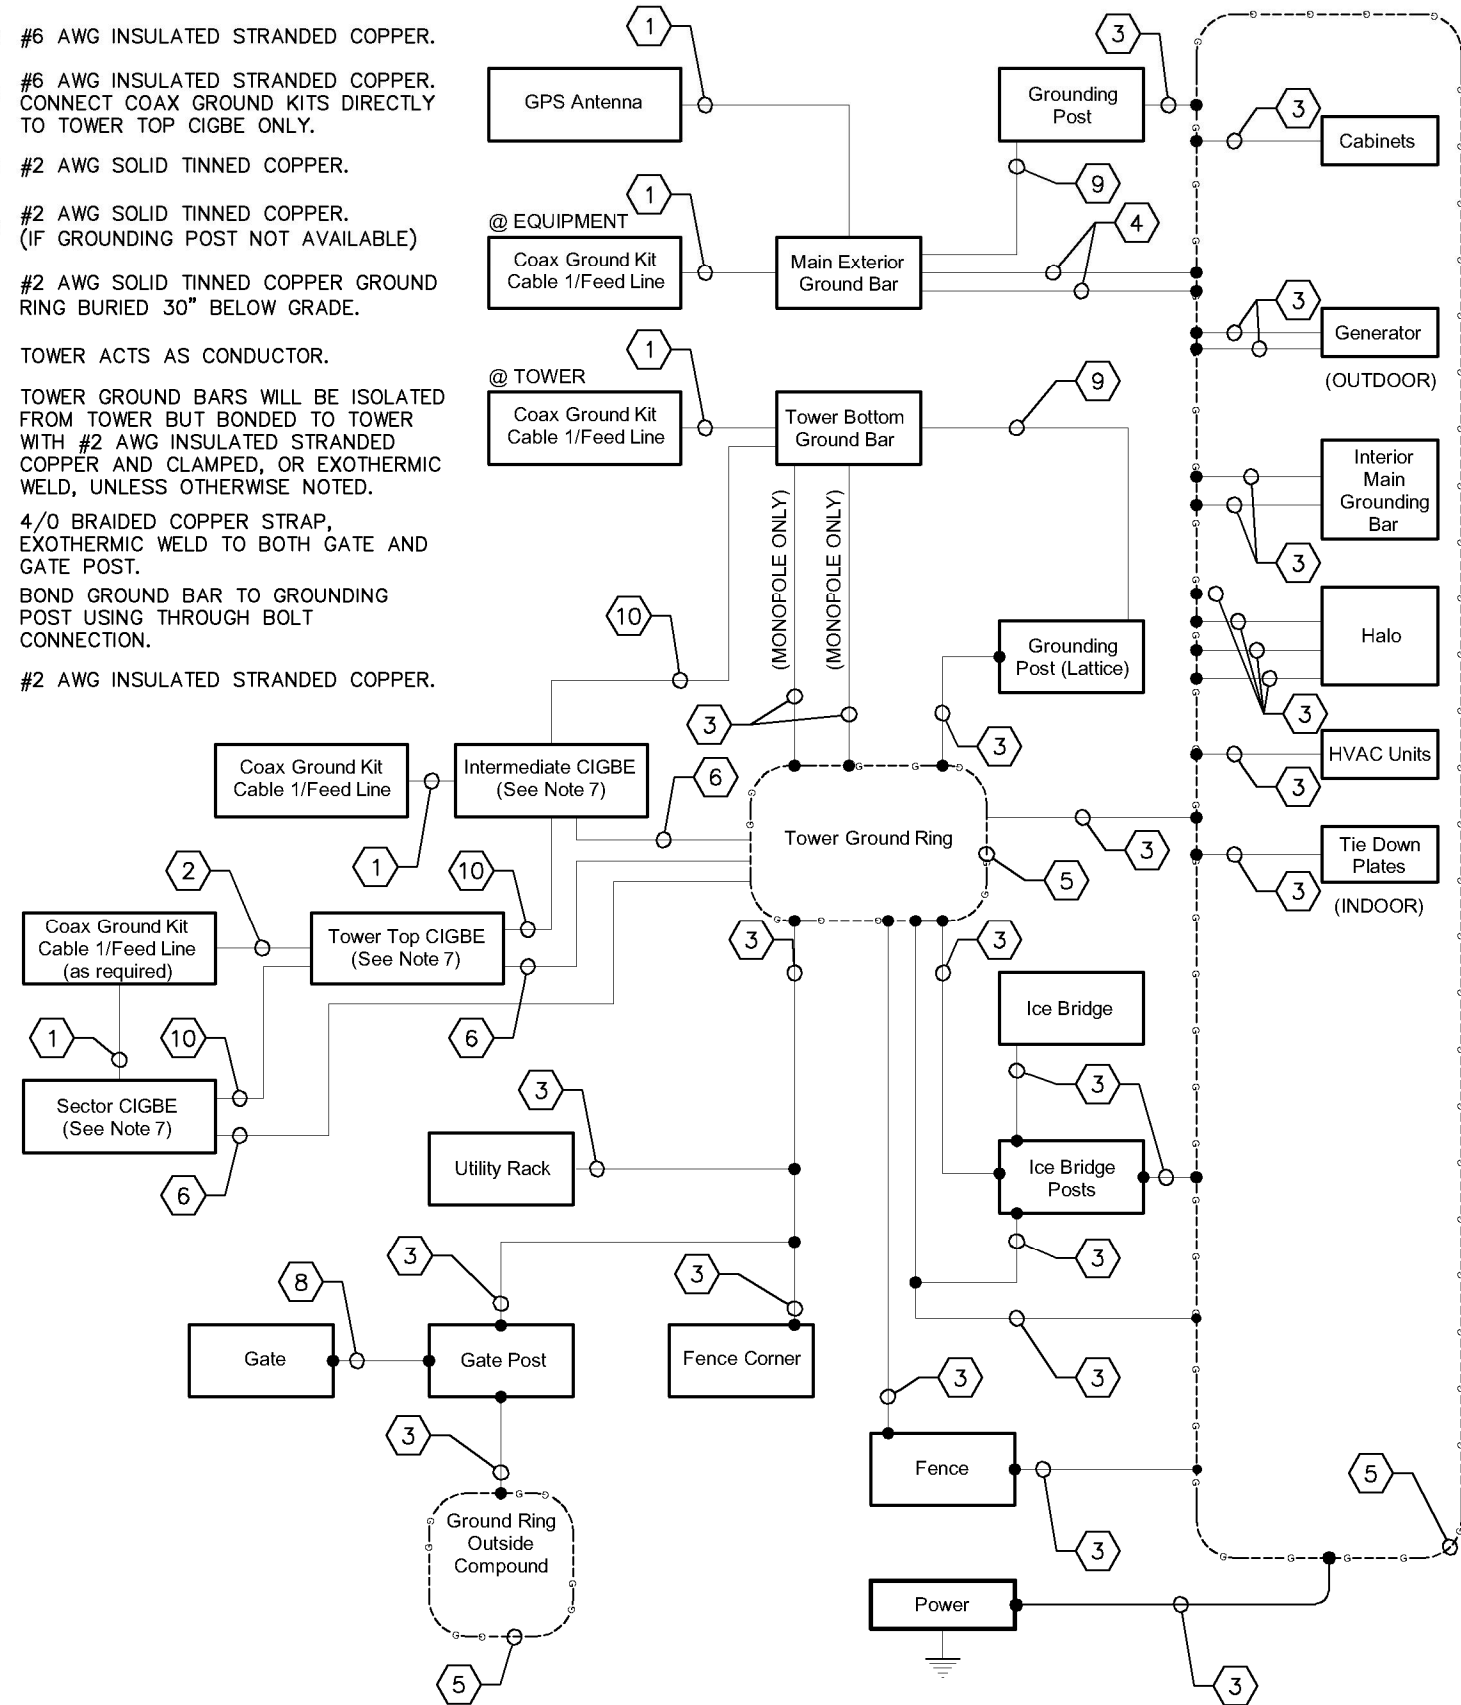

**1** GROUNDING SINGLE LINE DIAGRAM  
E6 NOT TO SCALE

**KEY NOTES - CONDUIT, CONDUCTORS, & MISC**

- A PROPOSED ANTENNA.
- B COAX OR HYBRID CABLE GROUNDING KIT, TYPICAL. GROUNDING KITS ARE REQUIRED EVERY 75 FT MAXIMUM EXCEPT WHERE COAX IS CONCEALED INSIDE MONOPOLE OR OTHER INACCESSIBLE SPACE.
- C #6 AWG INSULATED GROUNDING CONDUCTOR FROM COAX GROUND KIT TO TOWER GROUND BAR, TYPICAL.
- D SECTOR CIGBE GROUND BAR, PROVIDE ONE PER SECTOR NEXT TO ANTENNAS (OPTIONAL ON GUYED TOWERS) AND ISOLATED FROM TOWER. BOND TO TOWER OR SECTOR FRAME WITH #2 AWG SOLID TINNED COPPER AND APPROVED CLAMP. (SEE NOTE P BELOW)
- E TOWER TOP CIGBE GROUND BAR MOUNTED TO TOWER WHERE COAX CABLES LEAVE VERTICAL WAVE GUIDE SUPPORT OR COMMON CABLE TRAY. TYPICALLY OCCURS ON GUY TOWERS (IN LIEU OF SECTOR CIGBE'S), ROOFTOPS, OR ON WATER TANKS (THRU-BOLTED TO MESSENGER PIPE) IN ORDER TO MAINTAIN 75 FEET MAXIMUM DISTANCE BETWEEN COAX GROUND KITS. ISOLATE CIGBE FROM TOWER AND BOND TO TOWER WITH #2 AWG BARE SOLID TINNED COPPER AND APPROVED CLAMP. (SEE NOTE P BELOW)
- F COAX OR HYBRID CABLE.
- G #2 AWG INSULATED, STRANDED COPPER. (SEE NOTE P BELOW)
- H INTERMEDIATE CIGBE GROUND BAR MOUNTED TO TOWER BELOW AND WITHIN 3 FEET OF COAX GROUND KITS AND ISOLATED FROM TOWER (THRU-BOLTED TO MESSENGER PIPE ON WATER TANKS). BOND TO TOWER WITH #2 AWG BARE SOLID TINNED COPPER AND APPROVED CLAMP. (SEE NOTE P BELOW)
- J TOWER BOTTOM GROUND BAR TDSGA-PA14 ON DEDICATED STEEL POST WHERE POSSIBLE; OTHERWISE TDSGA-BC14 CLAMPED DIRECTLY TO TOWERS STEEL (THRU-BOLTED TO MESSENGER PIPE ON WATER TANKS).
- K #2 AWG BARE STRANDED TINNED COPPER GROUNDING CONDUCTOR WHEN USING TDSGA-BC14. TYPICAL TWO CONNECTIONS TO GROUND RING.
- L #2 AWG SOLID TINNED COPPER TOWER GROUND RING.
- M DRIP LOOP. (SEE DETAIL 1/E6)
- N TO SHELTER/RF CABINETS.
- P IF UNABLE TO CLAMP #2 AWG BARE SOLID TINNED COPPER TO METAL STRUCTURE, THEN RUN #2 AWG INSULATED STRANDED TINNED COPPER FROM CIGBE TO NEXT LOWEST CIGBE.
- Q PROPOSED RRU AND DIPLEXER (IF USED).
- R PROPOSED RAYCAP.

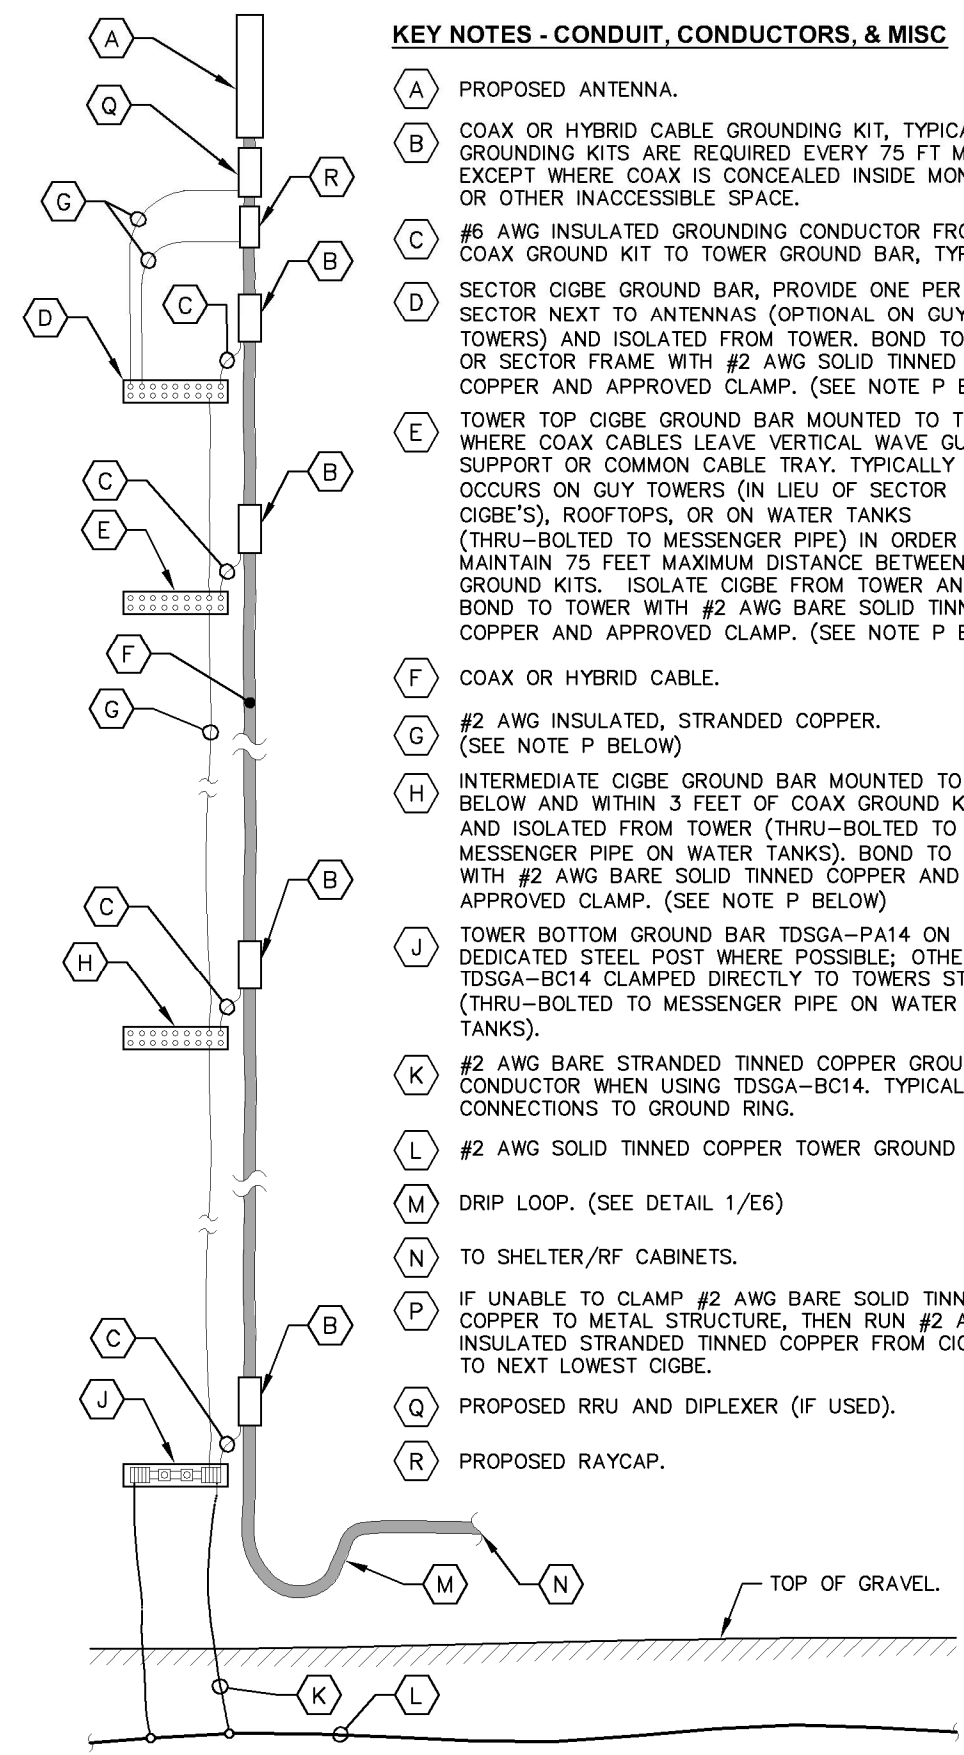

**2** COAX-TOWER GROUNDING SCHEMATIC  
E6 NOT TO SCALE




PROJECT INFORMATION:  
SITE NAME:  
HENDERSON COUNTY TOWER  
SITE No.: 639642  
PROJECT #: 20202154476  
469 S FORGE CREST DR  
MILLS RIVER, NC 28759  
HENDERSON COUNTY

PLANS PREPARED BY:  
**Kimley»Horn**  
11720 AMBER PARK DRIVE, SUITE 600  
ALPHARETTA, GA 30009  
PHONE: 770-619-4280  
WWW.KIMLEY-HORN.COM  
NC License F-0102

REV: \_\_\_\_\_ DATE: \_\_\_\_\_ ISSUED FOR: \_\_\_\_\_ BY: \_\_\_\_\_

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| 0 | 01/10/24 | CONSTRUCTION | DRC |

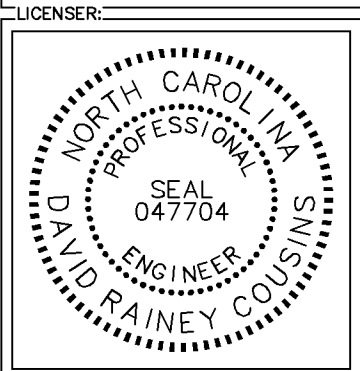

KHA PROJECT NUMBER:  
017848000  
DRAWN BY: XQD CHECKED BY: DMF

SHEET TITLE:  
**GROUNDING SINGLE LINE DIAGRAM**

SHEET NUMBER:  
E6

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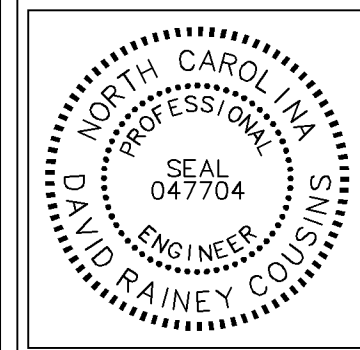
PROJECT INFORMATION:  
 SITE NAME:  
 HENDERSON COUNTY TOWER  
 SITE No.: 639642  
 PROJECT #: 20202154476  
 469 S FORGE CREST DR  
 MILLS RIVER, NC 28759  
 HENDERSON COUNTY

PLANS PREPARED BY:  
**Kimley»Horn**  
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| 0 | 01/10/24 | CONSTRUCTION | DRC |

LICENSER: \_\_\_\_\_





KHA PROJECT NUMBER:  
 017848000

DRAWN BY: XQD CHECKED BY: DMF

SHEET TITLE:

**GROUNDING  
 DETAILS**

SHEET NUMBER:  
 E7

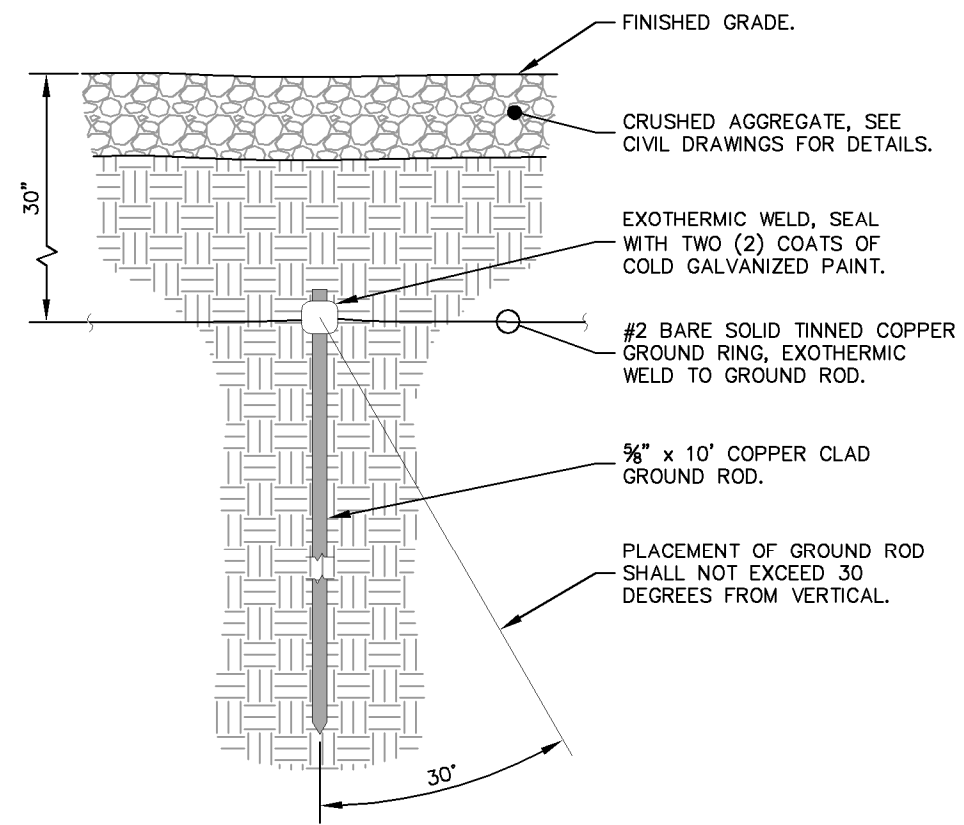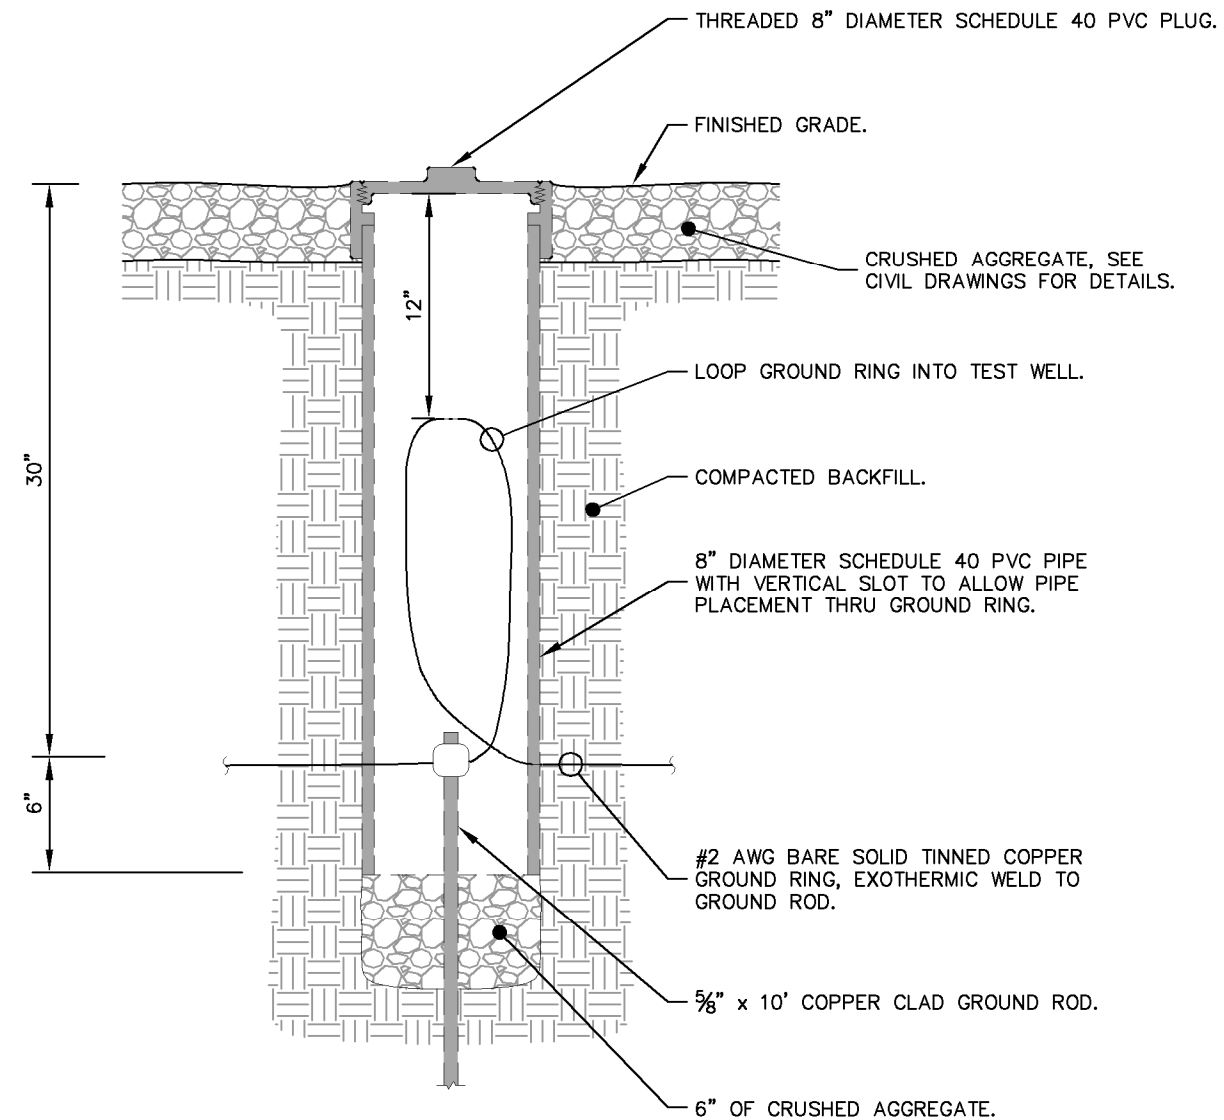

**1** GROUND ROD TEST WELL DETAIL  
 E7 NOT TO SCALE


**2** GROUND ROD INSTALLATION DETAIL  
 E7 NOT TO SCALE

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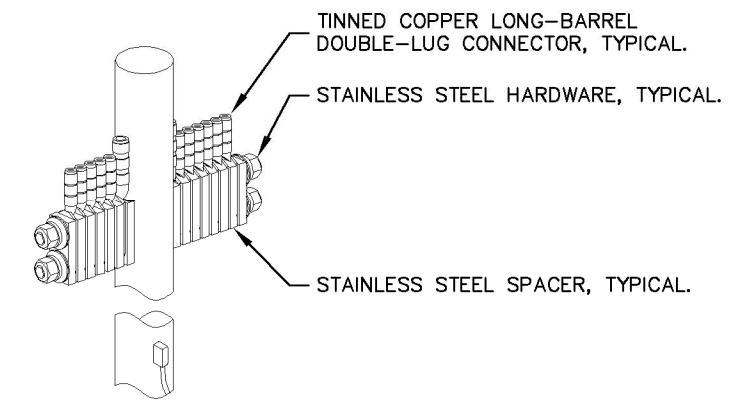


PROJECT INFORMATION:  
 SITE NAME:  
 HENDERSON COUNTY TOWER  
 SITE No.: 639642  
 PROJECT #: 20202154476  
 469 S FORGE CREST DR  
 MILLS RIVER, NC 28759  
 HENDERSON COUNTY


PLANS PREPARED BY:  
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**1** BAR NONE GROUNDED BEAM CLAMP (TDSGA-BC14)  
**E8** NOT TO SCALE

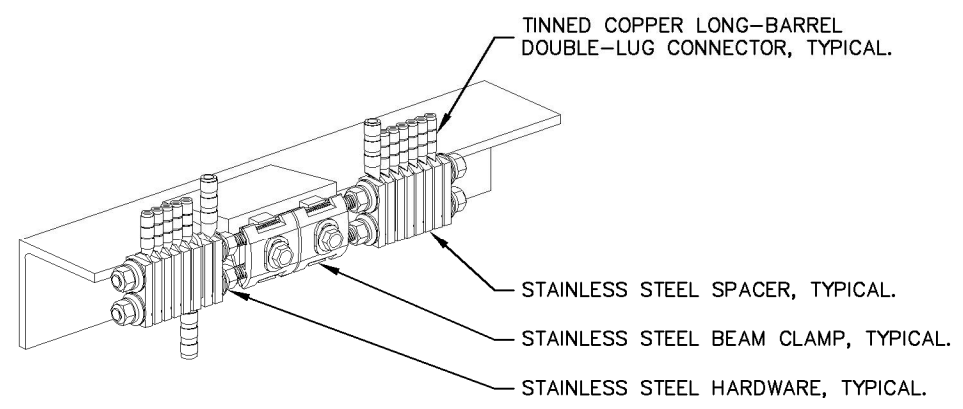


**2** BAR NONE POST MOUNTED (TDSGA-PA14)  
**E8** NOT TO SCALE




**3** ANTENNA GROUND WIRE INSTALLATION DETAIL  
**E8** NOT TO SCALE

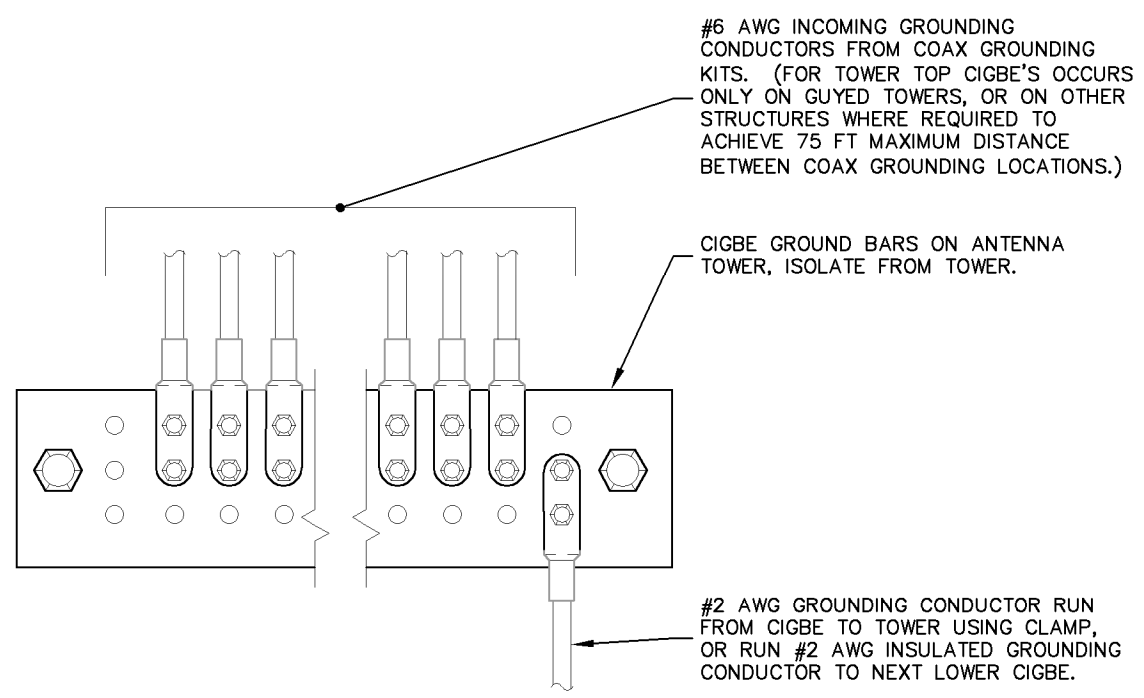- NOTES:
1. ALL CIGBE GROUND BARS ON TOWER ARE TO BE ERICO TDSGA. TYPICALLY USE TDSGA-WB17 ISOLATED FROM UNISTRUT BRACKET.
  2. IF CIGBE CANNOT BE CONNECTED TO TOWER WITH #2 AWG GROUNDING CONDUCTOR, VIA CLAMP OR EXOTHERMIC WELD, THEN RUN #2 AWG BLACK GROUND LEAD FROM CIGBE DOWN TO NEXT LOWER CIGBE. SECURE GROUND LEAD WITH NON-METALIC TIES AT SAME SPACING AS COAX SUPPORTS.

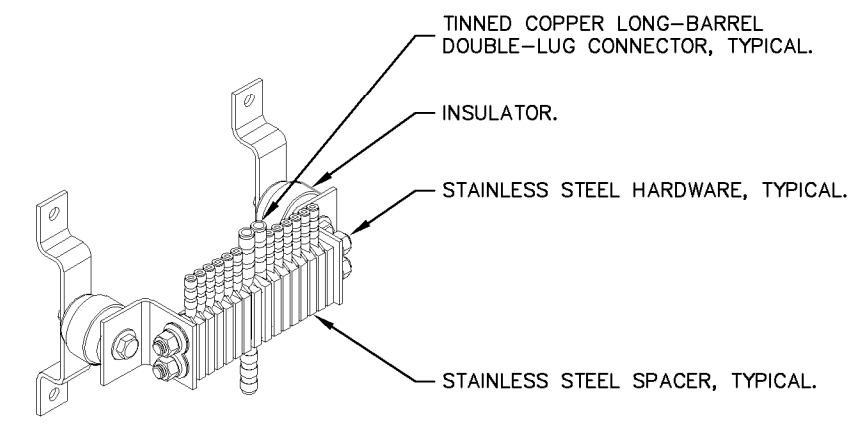

**4** BAR NONE INSULATED (TDSGA-WB17)  
**E8** NOT TO SCALE

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| REV: | DATE:    | ISSUED FOR:  | BY: |
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KHA PROJECT NUMBER:  
 017848000  
 DRAWN BY: XQD CHECKED BY: DMF

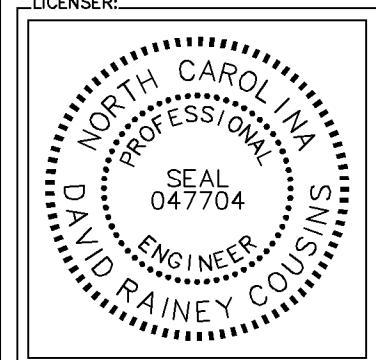SHEET TITLE:  
**GROUNDING DETAILS**

SHEET NUMBER:  
**E8**

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