

OWNER

HENDERSONVILLE COUNTY
STATE OF NORTH CAROLINA
CONTACTS:
THAD NINNEMANN
828.577.1501
TRINA RUSHING
828.697.4725

GENERAL CONTRACTOR

TBD

ARCHITECT

THE TAMARA PEACOCK COMPANY ARCHITECTS
104 FIRST AVENUE EAST, SUITE A
HENDERSONVILLE, NC 28792
828.696.4000
TAMARA@TAMARAPEACOCK.COM

MR. BRIAN PRICE

HCPL REMODEL

Henderson Co. Public Library

HENDERSONVILLE, NC

BUILDING STATISTICS

BUILDING TYPE: IIB
SF: 1ST 34,090 SF
2ND 7,385 SF
TOTAL 41,475 SF
OCCUPANCY TYPE: A3
ALLOWABLE AREA: 15x1200= 18,000sf (MAIN FLOOR) (PER 2015 NC IEBC SECT 803.3.2.5)
<50% ALLOWABLE OVERAGE?= YES (PER 2012 NCIBC SECT. 1028.2)

SPRINKLERED: NONE
SEPARATED USE: NONE
SEPARATION REQUIRED: NONE (T 508.4)
INCIDENTAL USE:
OCCUPANCY LOAD: A3: 2,765
PLUMBING REQUIREMENTS: NO CHANGE
PLUMBING PROPOSED: NO CHANGES
LIFE SAFETY REQUIREMENTS: SEE A002

APPLICABLE BUILDING CODES/OCCUPANCY NOTES
1 EXISTING BUILDINGS OCCUPANCY PER 2012 NC IBC 1004.1 EXCEPTION 1, AND 1004.3
EXCEPTION 2 DETERMINED BY BUILDING INSPECTOR
2 NO CHANGE IN OCCUPANCY TYPE OR AMOUNT, ALL MEANS OF EGRESS MAINTAINED PER
2015 NC IEBC SECTION 1005
3 MAXIMUM EXIT ACCESS TRAVEL DISTANCE: 200' (TABLE 1016.1)
4 DEAD END CORRIDOR LIMIT = 35' (2012 NC IEBC 805.6.1)
5 COMMON PATH OF TRAVEL LIMIT = 75' (TABLE 1014.3)
6 ALL EGRESS DOORS ARE MIN 32" CLEAR


SCOPE OF WORK:
The Ground Floor of the
Henderson County Public Library:
1. Renovate and expand circulation area
2. Add a classroom and (2) study rooms,
3. Partially enclose the Young Adult section,
4. Install (6) new windows on the North Elevation.

| PARKING CALCULATIONS | | | | |
|----------------------|------------|------|-------|-----------------|
| AREA TYPE | PERCENTAGE | AREA | RATIO | # OF SPACES |
| ASSEMBLY | NA | NA | NA | TO REMAIN AS-IS |

| Drawing List | |
|--------------|-----------------------------------|
| SHEET NO | SHEET NAME |
| A001 | COVER SHEET |
| A002 | LIFE SAFETY PLAN |
| A003 | ABBREVIATIONS SYMBOLS AND LEGENDS |
| A004 | CODE SUMMARY |
| A005 | PARTITION TYPES - SCHEDULES |
| A006 | ACCESSIBILITY STANDARDS |
| A007 | STAGING PLAN |
| A101 | NEW OVERALL FLOOR PLAN |
| A102 | CIRCULATION AREA DEMO |
| A102.1 | CIRCULATION AREA NEW WORK |
| A103 | YOUNG ADULT AREA DEMO |
| A103.1 | YOUNG ADULT AREA NEW WORK |
| A104 | ENLARGED CLASSROOM AREA LAYOUTS |
| A301 | ROOF PLAN |
| AE100 | ELECTRIC PLANS & NOTES |
| AE101 | ELECTRIC PLANS & NOTES |
| AM001 | HVAC UPFIT |
| AM002 | MECHANICAL SCHEDULES AND NOTES |



SITE MAP

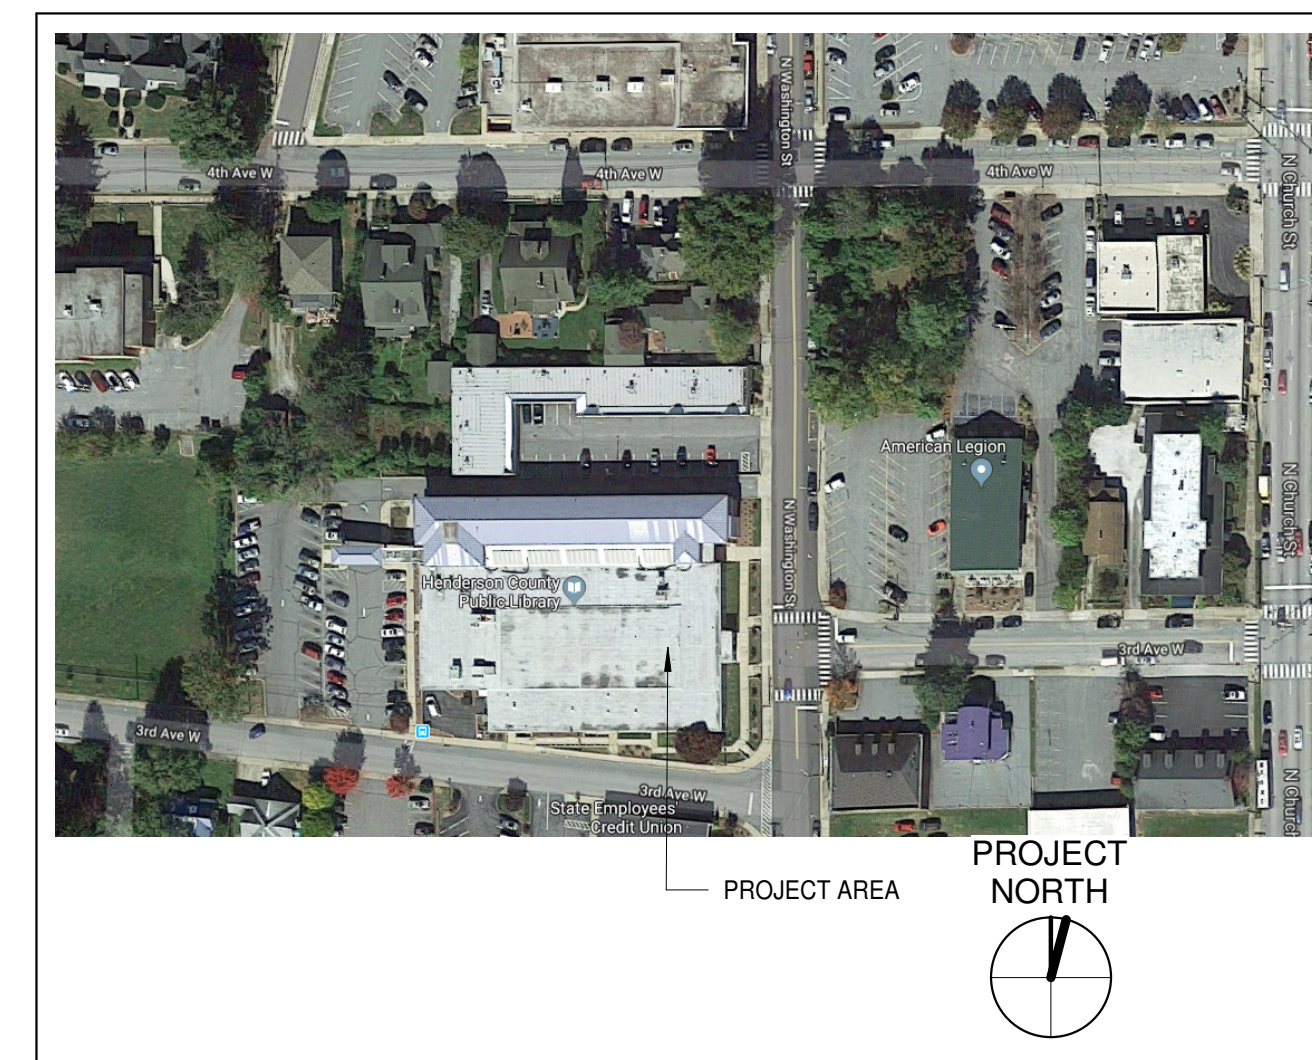

VICINITY MAP



TAMARA PEACOCK, R.A.
LICENSE NO. 12126

PROJ. DESIGNER: CAPT. APPROVER
DRAWN BY: AUTHOR
REVISED BY: CHECKER

| REVISION | REVISION DATE | ISSUED FOR |
|----------|---------------|------------|
| 1 | 7/17/2018 | DW |

THE TAMARA PEACOCK COMPANY
Architects
104 1st Ave E. Hendersonville, NC 28792
Phone: 828.696.4000 Fax: 954.728.9225

PROJECT NAME:
Henderson Co. Public Library
301 N. WASHINGTON ST.
HENDERSONVILLE, NC 28792

SHEET NAME:
COVER SHEET

PROJ. NO.: 1804
DATE: 8/3/2018
2:46:28 PM
SHEET NO.:
A001

BID SET
7-2018

BUILDING STATISTICS


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- COMMON PATH OF TRAVEL LIMIT = 75' (TABLE 1014.3)
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LIFE SAFETY LEGEND AND NOTES

- EGRESS PATH OF TRAVEL
- DOOR EXIT OCCUPANT LOAD
- DOOR EXIT OCCUPANT CAPACITY
- DOOR CLEAR EXIT WIDTH (IN INCHES)
- BRACKET MOUNTED FIRE EXTINGUISHER
- RECESSED OR SEMI-RECESSED FIRE EXTINGUISHER CABINET
- CEILING MOUNTED EXIT SIGN (ARROWS WHEN INDICATED)
- WALL MOUNTED EXIT SIGN (ARROWS WHEN INDICATED)
- EMERGENCY FIRE ALARM HORN
- EMERGENCY SURFACE MOUNTED LIGHT

NOTES:

- PLANS SHALL COMPLY WITH ALL REQUIREMENTS OF THE NORTH CAROLINA FIRE PREVENTION CODE, 2012 EDITION, N.F.P.A. 101 (LIFE SAFETY CODE), 2012 EDITION, AND N.F.P.A. 1 (UNIFORM FIRE CODE), 2012 EDITION.
- ALL INTERIOR FINISHES TO COMPLY WITH N.F.P.A. LSC 101, CHAPTER 10 SEC. 10.2 AND CHAPTER 36.
- ALL EMERGENCY LIGHTS AND EXIT SIGNS ARE BATTERY BACK-UP AND SHALL BE FULLY OPERABLE BY THE TIME OF THE FIRE FINAL INSPECTION
- PROVIDE HAND HELD FIRE EXTINGUISHERS ACCORDING TO THE LOCAL FIRE MARSHALL REQUIREMENTS - PROVIDE (2) 2A: 10BC FIRE EXTINGUISHERS EVERY 2,500 SF AS PER LSC 101, 9.7.41
- PROVIDE PANIC AND FIRE EXIT HARDWARE FOR ALL EGRESS DOORS. PROVIDE AUTOMATIC CLOSING DEVICES ON ALL RATED DOORS. OPERATING DEVICES ON ACCESSIBLE DOORS TO BE LEVER-OPERATED MECHANISMS, PUSH-TYPE MECHANISMS AND/OR U-SHAPED HANDLES. EGRESS DOORS SHALL NOT REQUIRE THE USE OF A KEY, TOOL, OR SPECIAL KNOWLEDGE TO OPEN FROM EGRESS SIDE.

FIRE RATING AND FIRE PROOFING NOTES:

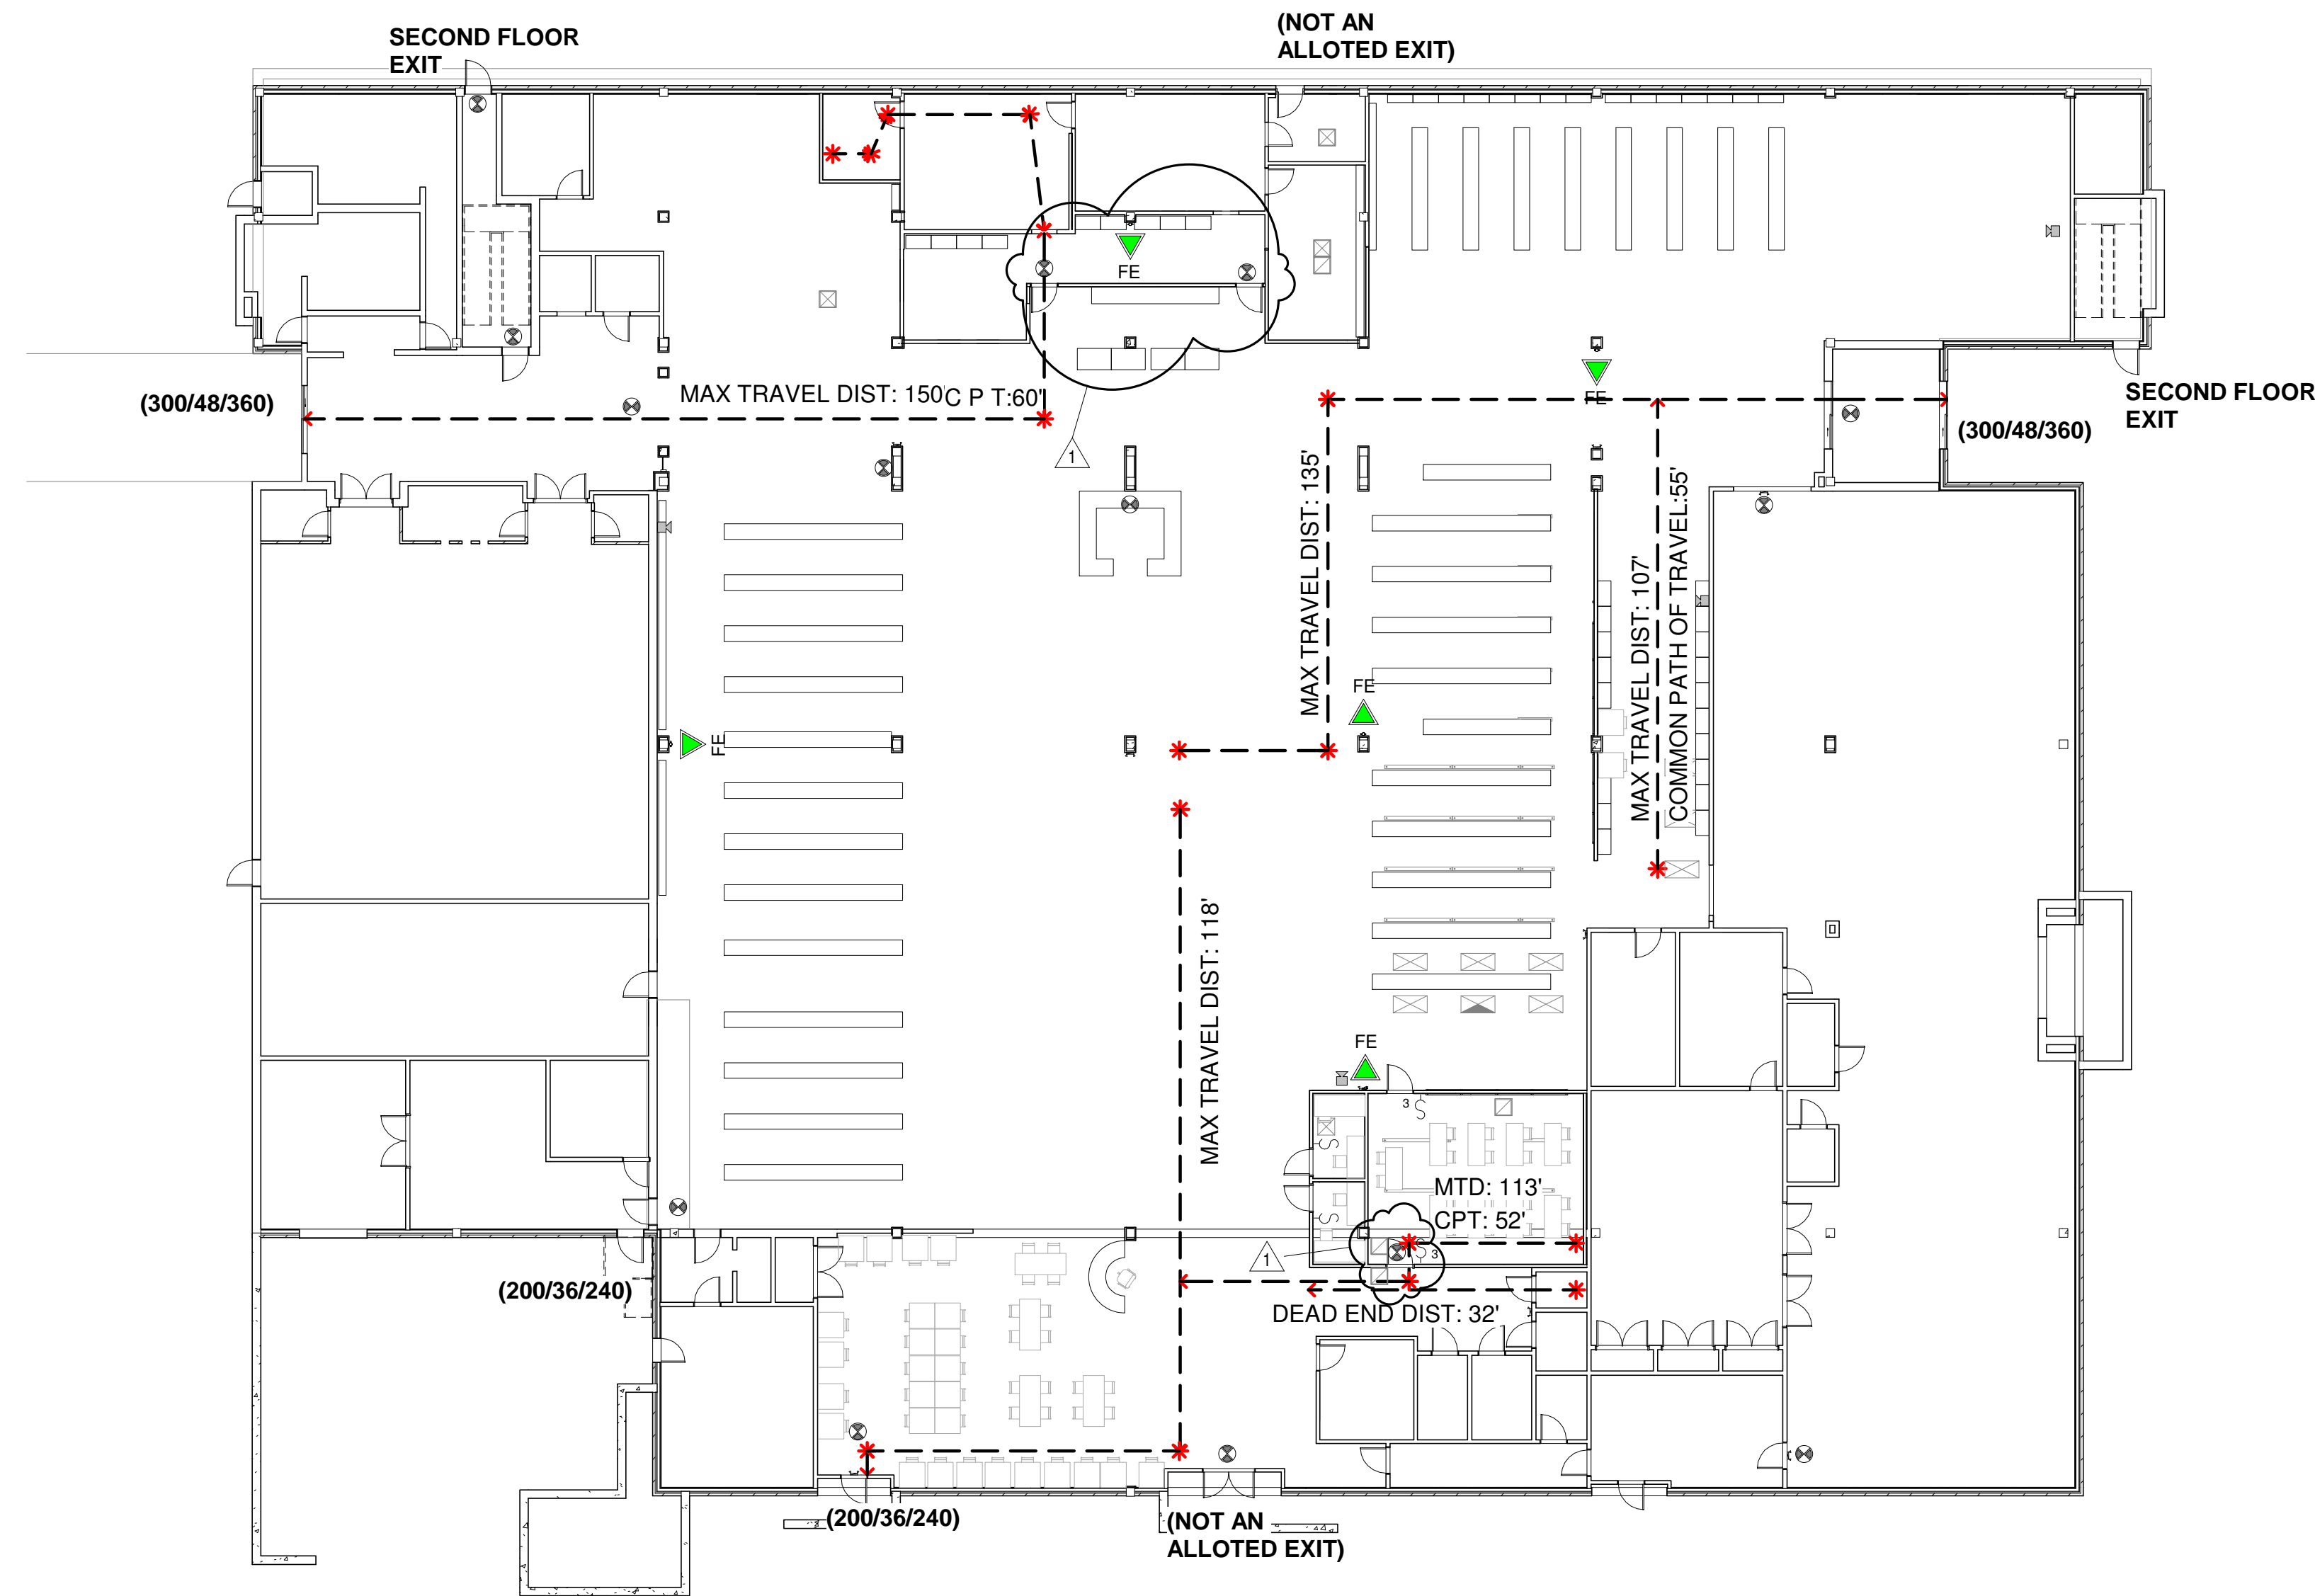- THE SCOPE OF WORK FOR THIS PROJECT IMPACTS ALARMS SIGNALS, LIGHTS AND SMOKE DETECTION DEVICES.
- NO FIRE WALLS OR EXITS ARE IN SCOPE OF WORK.
- SEE FLOOR PLAN(S) AND WALL TYPE SCHEDULE FOR WALL ASSEMBLY TYPES AND CONSTRUCTION
- REFER TO SHEET A004 FOR GENERAL FLOOR, ROOF, AND STRUCTURAL RATING REQUIREMENTS AND RELEVANT PROPOSED PROTECTION SYSTEMS.

1 LIFE SAFETY PLAN
 A002 1/16" = 1'-0"

| | | |
|-----------|---------------|------------|
| PROJ. NO. | DESIGNER | DRAWN BY |
| CAPT. | APPROVER | AUTHOR |
| REVISION | REVISION DATE | ISSUED FOR |
| | 7/17/2018 | DW |

THE TAMARA PEACOCK COMPANY
Architects

104 1st Ave E. Hendersonville, NC 28792
 Phone: 828.696.4000 Fax: 954.728.9225

PROJECT NAME:
Henderson Co. Public Library
 301 N. WASHINGTON ST.
 HENDERSONVILLE, NC 28792

SHEET NAME:
LIFE SAFETY PLAN

PROJ. NO. 1804 DATE: 8/3/2018
 SHEET NO. 246-29 PM

A002

ABBREVIATION NOTES:

- 1. GENERALLY TERMS ARE SPELLED OUT AND ABBREVIATIONS USED ONLY TO REDUCE TIME AND SPACE OR WHERE APPROPRIATE OR TO IMPROVE CLARITY.
2. ABBREVIATIONS LISTED BELOW APPLY TO THE ARCHITECTURAL DRAWINGS ONLY. REFER TO DRAWINGS BY OTHER TRADES FOR ABBREVIATIONS USED ON OTHER TRADES DRAWINGS.
3. REFER TO FINISH SCHEDULE FOR MATERIAL ABBREVIATIONS USED ON THE FINISH SCHEDULE.
4. ABBREVIATION LISTED HERE ARE BASED ON THE NATIONAL CAD STANDARD MODULE 5. REFER TO THE NCS FOR ABBREVIATIONS SHOWN ON THE DRAWINGS THAT ARE NOT LISTED HERE. WHERE MULTIPLE TERMS EXISTING FOR THE ABBREVIATION SHOWN, THE TERM REFERENCED IN THE LIST BELOW SHALL BE USED.

Table with 3 columns: Abbreviation, Description, Abbreviation. Includes terms like A/C AIR CONDITION, A/E ARCHITECT/ENGINEER, A/C CENTER LINE, etc.

Table with 3 columns: Abbreviation, Description, Abbreviation. Includes terms like EPX EPOXY, EQ EQUAL, EQUIP EQUIPMENT, etc.

Table with 3 columns: Abbreviation, Description, Abbreviation. Includes terms like P PAINT, PAT PATTERN, PB PANIC BAR, etc.


Table with 3 columns: Abbreviation, Description, Abbreviation. Includes terms like R RADIATION, RADN RADIATION, RB RESILANT BASE, etc.

LINE STYLES

Table mapping line styles to PEN values: PEN: 1, PEN: 2, PEN: 3, PEN: 4, PEN: 5, PEN: 6








LINE TYPES

Table mapping line types to visual styles: BEYOND, CENTERLINE, DEMOLISHED, HIDDEN, OVERHEAD

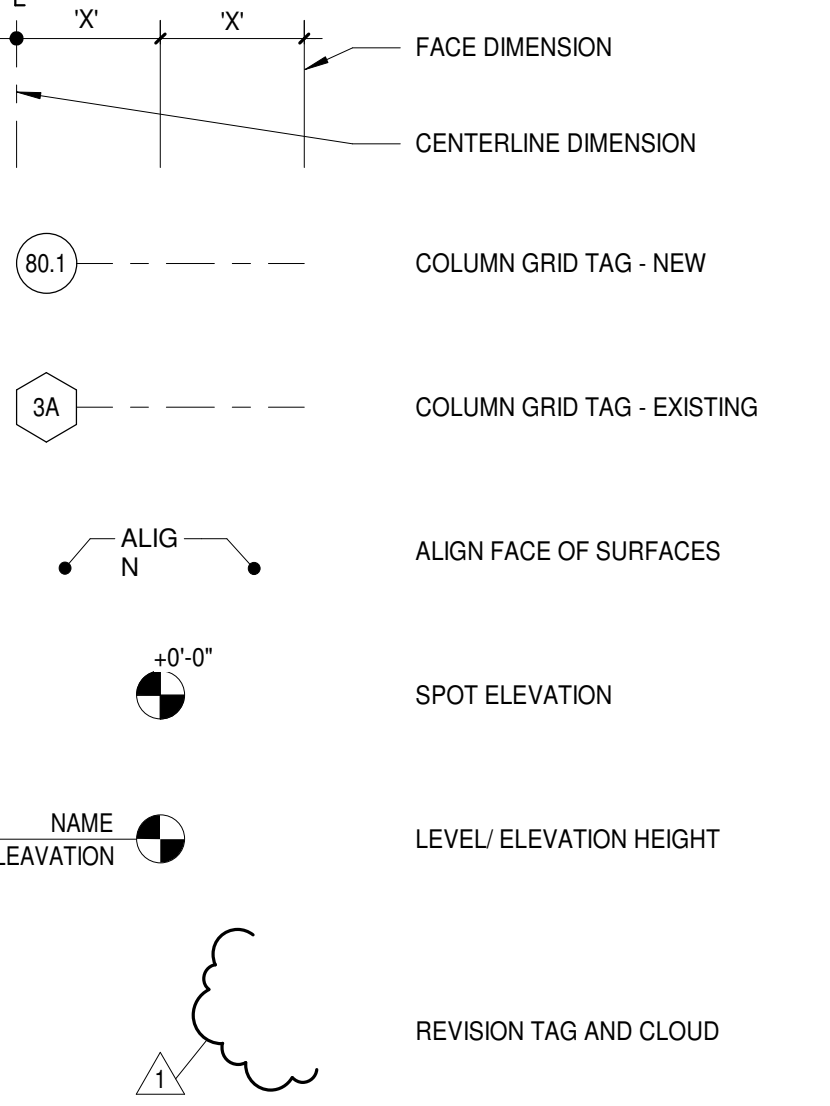

STANDARD GRAPHICS AND SYMBOLS

12" = 1'-0"

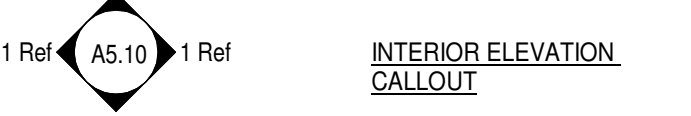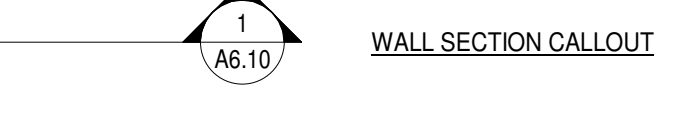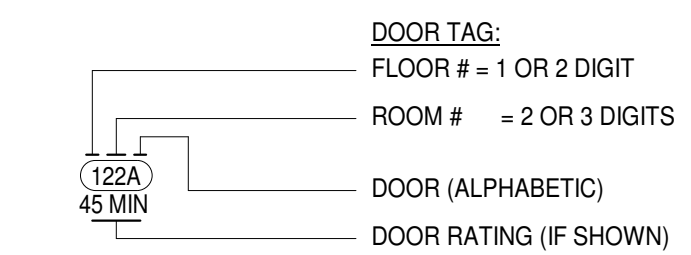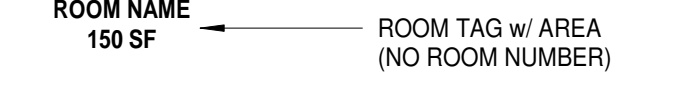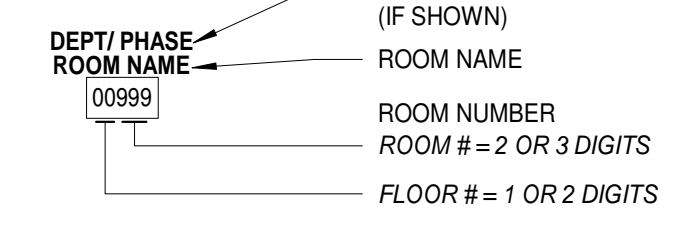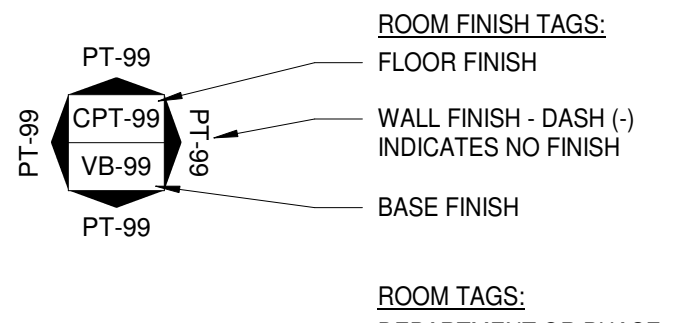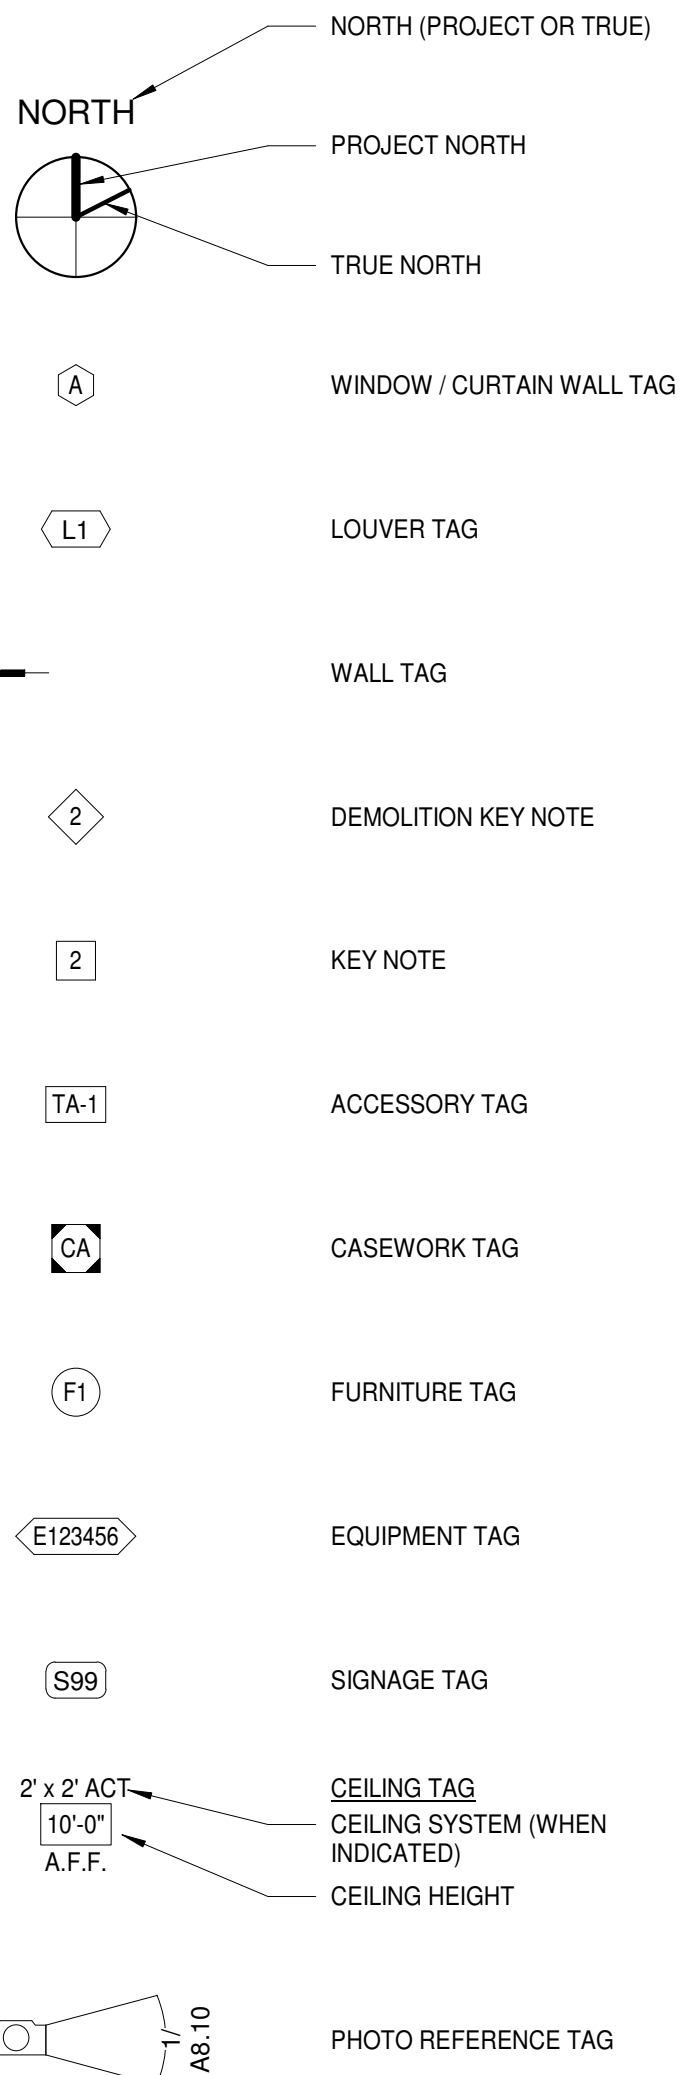

THE TAMARA PEACOCK COMPANY Architects logo and contact information. Includes address: 104 1st Ave E, Hendersonville, NC 28792. Phone: 828.696.4000. Fax: 954.728.9225. Also includes project name: ABBREVIATIONS, SYMBOLS AND LEGENDS and sheet number: A003.

BID SET 7-2018

PROJECT BUILDING CODE SUMMARY

PROJECT SUMMARY: REMODEL OF MINOR ELEMENTS
Project Name: HENDERSON COUNTY PUBLIC LIBRARY MINOR REMODEL
Address: 301 N. WASHINGTON ST. HENDERSONVILLE, NC 28792
Proposed Use: ASSEMBLY
Owner or Authorized Agent: HCPL
Owned By: Private City/ County State
Code Jurisdiction: 2015 NC-EIBC 2012 NC-IBC

APPLICABLE CODES:

NEW BUILDING
 New Construction
 Shell Building
 Addition
 Upfit

EXISTING BUILDING
 Alteration
 Repair
 Occupancy Change

All Lvl: II

Existing Use:
 Addition/
 Relocation

OCCUPANCY: SEE LIFE SAFETY PLAN(S) FROM OVERALL OCCUPANT LOADS

Occupancy Types:

- Assembly
 - A-1
 - A-2
 - A-3
 - A-4
 - A-5
- Factory/ Industrial
 - F-1
 - F-2
- Institutional
 - I-1
 - I-2
 - I-3
 - I-4
 - I-5
- Residential
 - R-1
 - R-2
 - R-3
 - R-4
- High Hazard
 - H-1
 - H-2
 - H-3
 - H-4
 - H-5
- Mercantile
- Utility and Miscellaneous
- Storage
 - S-1
 - S-2
- Business
- Educational

BUILDING DATA:

Construction Types: I-A II-A III-A IV V-A
 I-B II-B III-B V-B

Sprinklers: NO YES

Standpipes: NO YES

Buildin Height: APPROX. 32 Feet 2 Stories Unlimited

Code Jurisdiction:

APPLICABLE CODES:

Other Uses: Accessory Uses (Indicate Percentages): Assembly
 Incidental Uses: First Lvl Assembly Second Lvl Business

Mixed Occupancy: (IBC SECTION 508)
 No Separation: 0 Hr. (AS PER IBC TABLE 508.4)
 Yes

Non-Separated Mixed Occupancy (508.3.2) -- The required type of construction for the building shall be determined by applying the height and area limitations for each of the applicable occupancies to the entire building. The most restrictive type of construction, so determined, shall apply to the entire building.
 Separated Mixed Occupancy (508.3.3) -- See below for area calculations for each story, the area of the occupancy shall be such that the sum of the ratios of the actual floor area of each use divided by the allowable floor area for each use shall not exceed 1.

| AREA No. | Use and Description | Bldg. Area Per Story (Actual) | Table 503 Area | Allowable Frontage Increase | Allowable Sprinkler Increase | Allowable Area or Unlimited | Separated Occupancy Allowable Area Ratio per 508.4.2 |
|--|-----------------------------|-------------------------------|----------------|-----------------------------|------------------------------|-----------------------------|--|
| First Floor | A3 - Small Assembly (1st F) | 34,090 s.f. | Not Used | Not Used | Not Used | | NA |
| Second Floor | B - Business (2nd F) | 7,385 s.f. | Not Used | Not Used | Not Used | | NA |
| MAXIMUM BUILDING AREA 1st STORY (NCIBC 1028.2) | | | | | | | 36,000 SF |
| ACTUAL BUILDING AREA 1st STORY | | | | | | | 34,090 SF |
| MAXIMUM BUILDING AREA 2nd STORY | | | | | | | NA (NO WORK) |
| ACTUAL BUILDING AREA 2nd STORY | | | | | | | NA (NO WORK) |

Building Area Increase Calculations:
 $A_s = (A_1 + A_2 + A_3 + A_4 + A_5)$ where:
 A_s = Allowable building area per story
 A₁ = Tabular building area per story per Table 503
 A₂ = Area increase factor due to sprinkler protection 508.2
 A₃ = Area increase factor due to sprinkler protection per 508.3

Frontage Increase:
 $F = (FP + 0.25)W/30$ where:
 F = Area increase due to frontage
 FP = Building perimeter that fronts open space
 W = Building width or open space per 508.2.1

Width Limits:
 $W = L_1 + w_1 + L_2 + w_2 + L_3 + w_3$ where:
 L_n = Length of a portion of the exterior perimeter wall
 w_n = Width of open space associated with that portion of the exterior perimeter wall

ALLOWABLE HEIGHT: (Section 503)

| Type of Construction | Allowable Height (Feet) | Actual Height (Feet) |
|----------------------------|-------------------------|----------------------|
| Building Height in Feet | 40'-0" | 25'-10" |
| Building Height in Stories | 2 | 2 |

TABLE 705.8 MAXIMUM AREA OF EXTERIOR WALL OPENINGS BASED ON FIRE SEPERATION DISTANCE

| Percentage of Wall Opening Calculations: (Unprotected, Sprinklered) | Allowable Area | Actual Area | | | |
|---|----------------|-------------|-----------|-----------|------------|
| | | North Wall | East Wall | West Wall | South Wall |
| 0 to less than 3 | Not Permitted | - | - | - | - |
| 3 to less than 5 | 25% | - | - | - | - |
| 5 to less than 10 | 25% | - | - | - | - |
| 10 to less than 15 | 45% | - | - | - | - |
| 15 to less than 20 | 75% | - | - | - | - |
| 20 to less than 25 | No Limit | - | - | - | All > 20 |
| 25 to less than 30 | No Limit | - | - | - | - |
| 30 or greater | Not Required | All > 30 | All > 30 | - | - |

TABLE 602 - FIRE-RESISTANCE RATING REQUIREMENT EXTERIOR WALLS BASED ON FIRE SEPERATION DISTANCE

| Fire Separation Distance in Feet | Type of Construction (VBI) | Notes |
|----------------------------------|----------------------------|--|
| X < 5' | NA | EXISTING BUILDING, NO OCCUPANCY CHANGE |
| 5 < X < 10' | 0 | |
| 10 < X < 30' | 0 | |
| > 30' | 0 | |

TABLE 601 - FIRE-RESISTANCE RATING REQUIREMENT FOR BUILDING ELEMENTS (HOURS)

| Building Element | Rating (Type VBI) | | Notes |
|--|-------------------|-----------------------------|--|
| | Req'd* | Design # for Rated Assembly | |
| Primary Structural Frame | 0 | - | EXISTING BUILDING, NO OCCUPANCY CHANGE |
| Bearing Walls Exterior | 0 | - | |
| Bearing Walls Interior | 0 | - | |
| Nonbearing Walls Exterior | 0 | - | |
| Nonbearing Walls Interior | 0 | - | |
| Floor Construction, and associated secondary members | 0 | - | |
| Roof construction and associated secondary members | 0 | - | |

| Vertical Exit Enclosures | Rating | Notes |
|--|--------|----------------|
| Shafts - Trash Chute, Termination Room | 0 | |
| Shafts - Elevator | 0 | |
| Corridor Separation | 1 HR | NOT APPLICABLE |
| Occupancy Separation | 1 HR | NOT APPLICABLE |
| Party Wall Separation | 0 | |
| Incidental Use Separation | 0 | |
| Area Separation | 1 | |

TABLE 803.9 INTERIOR WALL AND CEILING FINISH REQUIREMENTS (CLASSIFICATION)

| Use and Description | Int. Exit Ramps | Int. Exit Enclosures | Rooms & Enclosed Spaces |
|-------------------------------------|-----------------|----------------------|-------------------------|
| EXISTING LIBRARY, NO CHANGES TO OCC | NA | NA | NA |
| | NA | NA | NA |
| | NA | NA | NA |

FIRE EXTINGUISHERS FOR CLASS A FIRE HAZARDS

| | |
|---|-------------|
| Minimum Rated Single Extinguisher | 2A |
| Maximum Floor Area Per Unit of A | 3,000 sqft |
| Maximum Floor Area for Extinguisher | 11,250 sqft |
| Maximum Travel Distance to Extinguisher | 75 feet |

| Use Group or Space Description | (a) | (b) | (a/b) | (c) | Exit Width (inches) | |
|--------------------------------|----------------|------------------------------------|---------------------|--------------------------------------|---|--|
| | Area 1 SQ. FT. | Area Per Occupant (Table 1004.1.2) | Number of Occupants | Egress Width Per Occupant (IBC 1005) | Required Width per floor (Section 1005.1) (a/b) x c | |
| First Floor (total) | 34,090 sf | | | | | |
| Assembly (Library) | 34,090 sf | | 2,273 | | | |
| Second Floor (total) | 7,385 sf | 15 NET | 492 | | | |
| Total Building Occupancy | | | NA | | | |

- See definition "Area, Gross" and "Area, Net"
- Minimum stairway width (Section 1009.1); min. corridor width (Section 1017.2); min. door width (Section 1008.1.1)
- Minimum width of exit passageway (Section 1021.2)
- Assembly occupancies (Section 1028)

LIFE SAFETY SYSTEM REQUIREMENTS

| | | |
|---|-----------------------------|---|
| Emergency Lighting: | <input type="checkbox"/> No | <input checked="" type="checkbox"/> Yes |
| Exit Sign: | <input type="checkbox"/> No | <input checked="" type="checkbox"/> Yes |
| Fire Alarm: | <input type="checkbox"/> No | <input checked="" type="checkbox"/> Yes |
| Emergency Voice/Alarm Communication System: | <input type="checkbox"/> No | <input checked="" type="checkbox"/> Yes |
| Smoke Detection Systems: | <input type="checkbox"/> No | <input checked="" type="checkbox"/> Yes |
| Smoke Control System: | <input type="checkbox"/> No | <input checked="" type="checkbox"/> Yes |
| Panic Hardware: | <input type="checkbox"/> No | <input checked="" type="checkbox"/> Yes |

BUILDING ENVELOPE REQUIREMENTS
 INFORMATION BASED ON IECC 2009 (CLIMATE ZONE 3A), TABLE 301.1, TABLE 502.2(1), TABLE 502.3

INSULATION VALUES - ALL GROUP 'A' OCCUPANCIES

| Item | Value | Notes |
|---|-------|--|
| ROOF (ATTIC AND OTHER): WALLS, ABOVE GRADE: (WOOD FRAMED) | NA | FRAMING OTHER THAN METAL SHEET PILING WITHOUT METAL REINF. OR CLADDING |
| U-FACTOR: | 0.65 | |
| WALLS, BELOW GRADE: | NR | METAL FRAMING WITH OR WITHOUT THERMAL BREAK |
| CURTAIN WALL / STOREFRONT U-FACTOR: | 0.60 | |
| WOOD FRAMED U-FACTOR: | NA | ENTRANCE DOOR U-FACTOR: |
| ALL OTHER U-FACTOR: | 0.65 | |
| GLAZED DOORS SWINGING: | NR | SHGC (SEE IECC, TABLE 502.3) |
| | | PF < .25 |
| | | .25 < PF < .5 |
| | | PF > .5 |

MINIMUM NUMBER OF REQUIRED PLUMBING FIXTURES -

PLUMBING FIXTURE COUNTS ARE BASED ON THE TOTAL OCCUPANT LOAD AS PER IBC SECTION 1004 - OCCUPANT LOAD, IBC TABLE 2902.1 & IBC 2902.1.1 - FIXTURE CALCULATIONS

TOTAL OCCUPANCY: 278

REQUIREMENTS BY OCCUPANCY (AS PER IBC TABLE 2902.1.1):

| Occupancy | Male (139) Required | Male (139) Provided | Female (139) Required | Female (139) Provided |
|--|---------------------|---------------------|-----------------------|-----------------------|
| ASSEMBLY A-2 OCCUPANCY | | | | |
| REQUIRED TOILETS: MALE 139 FEMALE 139 | | | | |
| REQUIREMENT FOR WATER COOLERS: 1 PER 1,000 | | | | |
| EXISTING BUILDING, NO OCCUPANCY CHANGE | | | | |

EXIT REQUIREMENTS

COMMON PATH OF EGRESS TRAVEL

| Floor | Travel Distance | |
|-------------|--|------------------------|
| | Allowable Travel Distance (Table 1014.3) | Actual Travel Distance |
| FIRST FLOOR | 100' | 62'(MAX) |

NUMBER AND ARRANGEMENT OF EXITS

| Floor, Room or Space Designation | Minimum Number of Exits | | Travel Distance | | Arrangement Means of Egress (section 1015.2) | |
|----------------------------------|-------------------------|----------------|--|------------------------|--|--|
| | Required | Shown on Plans | Allowable Travel Distance (Table 1016.2) | Actual Travel Distance | Min. Required Distance Between Exit Doors | Actual Distance (Shortest between two exits) |
| LIBRARY | 2 | 5 | 200' | 56' LF - see G-002 | 56'-1" | 63'-2" |

1. CORR. DEAD ENDS 2. (NO CHANGES) EXIT REQ. NA 3. Common Path of Travel (Section 1014.3)

| PROJ. DESIGNER | APPROVER | AUTHOR | REVISOR | CHECKER |
|----------------|----------|--------|---------|---------|
| | | | | |

ISSUED FOR: _____

REVISION DATE: _____

REVISION: _____

THE TAMARA PEACOCK COMPANY
Architects

104 1st Ave E. Hendersonville, NC 28792
 Phone: 828.696.4000 Fax: 954.728.9225


PROJECT NAME:
Henderson Co. Public Library
 301 N. WASHINGTON ST.
 HENDERSONVILLE, NC 28792

SHEET NAME:
CODE SUMMARY


PROJ. NO. 1804 DATE: 8/3/2018
 SHEET NO. 214-6-31
 DATE: 8/3/2018
 TIME: 2:46:31 PM
A004

BID SET
 7-2018


| SA | SB | SC | | | | | | | | | | | | | | | | | | | | | | | | | | | | | | | | | | | | | | | | | | | | | | | | | | | | | | | | | | | | | | | | | | | | | | | | |
|---|
| <p>STRUCTURE ABOVE</p> <p>CEILING LINE</p> <p>PLAN</p> <p>FLOOR LINE</p> <p>SLAB OR DECKING ABOVE, SEE STRUCTURAL DWGS</p> <p>FOR RATED WALLS, CONT FIRE RATED ACOUSTICAL SEALANT @ TOP AND BOTTOM OF WALL (BOTH SIDES). PROVIDE NON-FIRE-RATED ACOUSTICAL SEALANT AT NON-RATED WALLS</p> <p>(FULL CAVITY WIDTH) ACOUSTICAL BATT INSULATION, W/ GALV STEEL PINS SECURED TO INTERIOR FACE OF GYP BD AT 16" OC VERT & HORIZ</p> <p>5/8" GYP. BD.</p> <p># METAL STUD FRAMING @ 16" OC SEE CHART BELOW.</p> <p>STEEL RUNNER, FASTENED TO CONCRETE SLAB AT 12" OC TOP & BOTTOM OF METAL STUD FRAMING</p> <p>PROTECT AND PATCH EXISTING FIN FLOORING & WALL BASE MATCH BASEBOARD WHERE NEW EXTG SLAB SEE STRUCT DWGS</p> | <p>STRUCTURE ABOVE</p> <p>CEILING LINE</p> <p>PLAN</p> <p>FLOOR LINE</p> <p>SLAB OR DECKING ABOVE, SEE STRUCTURAL DWGS</p> <p>DIAGONALLY BRACE BACK TO STRUCT @ 48" MAX, STAGGERED</p> <p>4" MIN</p> <p>5/8" GYP. BD.</p> <p># METAL STUD FRAMING @ 16" OC SEE CHART BELOW.</p> <p>STEEL RUNNER, FASTENED TO CONCRETE SLAB AT 12" OC TOP & BOTTOM OF METAL STUD FRAMING</p> <p>FIN FLOORING & WALL BASE AS SCHEDULED</p> <p>CONC SLAB SEE STRUCT DWGS</p> | <p>STRUCTURE ABOVE</p> <p>CEILING LINE</p> <p>PLAN</p> <p>FLOOR LINE</p> <p>SLAB OR DECKING ABOVE, SEE STRUCTURAL DWGS</p> <p>DIAGONALLY BRACE BACK TO STRUCT @ 48" MAX</p> <p>CONT FIRE RATED ACOUSTICAL SEALANT @ TOP AND BOTTOM OF WALL (BOTH SIDES) FOR RATED WALLS. PROVIDE NON-FIRE-RATED ACOUSTICAL SEALANT AT NON-RATED WALLS</p> <p>(FULL CAVITY WIDTH) ACOUSTICAL BATT INSULATION, W/ GALV STEEL PINS SECURED TO INTERIOR FACE OF GYP BD AT 16" OC VERT & HORIZ</p> <p>5/8" TYPE 'X' GYP. BD.</p> <p># METAL STUD FRAMING @ 16" OC SEE CHART BELOW.</p> <p>STEEL RUNNER, FASTENED TO CONCRETE SLAB AT 12" OC TOP & BOTTOM OF METAL STUD FRAMING</p> <p>FIN FLOORING & WALL BASE AS SCHEDULED</p> <p>CONC SLAB SEE STRUCT DWGS</p> | |
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| STUD SIZE | SA4 | - | - | - | - | |
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| STUD SIZE | SC2 | SC4 | SC6 | SC8 | - | |
| ACTUAL DIMENSION 'X' | 2 1/4" | 4 1/4" | 6 5/8" | 8 5/8" | - | |
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3 WALL BRACING DETAIL
A005 3/4" = 1'-0"

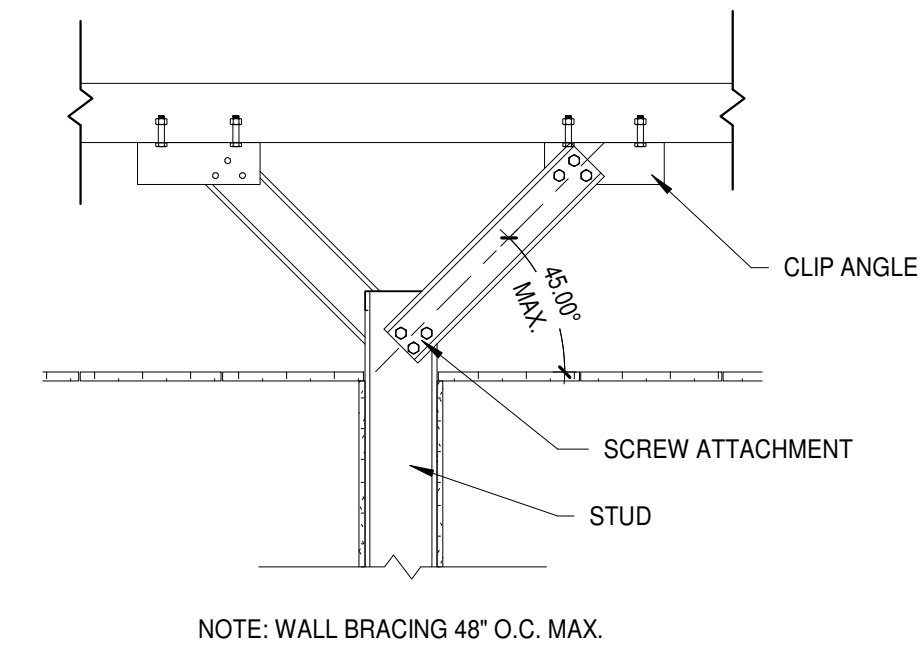


| # | W | H | MATERIAL | QUANTITY | ELEVATION | NOTES |
|---|----------|----------|--------------------------------|----------|-----------|--------------------------------|
| A | 10'-9" | 2'-0" | KNOCK-DOWN METAL FRAME | 2 | 3B | |
| B | 13'-4.5" | 2'-0" | - | 1 | 3B | |
| C | 16'-8.5" | 4'-0" | - | 1 | 4A | |
| I | 1'-11.3" | 5'-11.3" | ALUM. STOREFRONT SIZE PER MFG. | 6 | 1C | MASONRY R.O.-2'-0" H X 6'-0" W |

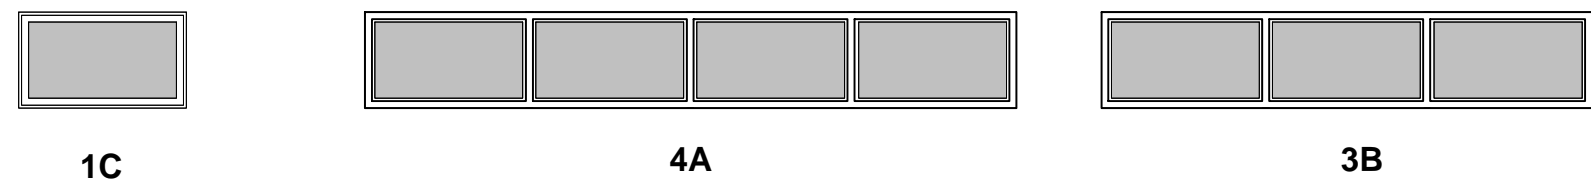


| # | W | H | D | MATERIAL | HDWR | FRAME | ELEVATION | NOTES |
|------|-------|-------|-------|----------|--------|-------|-----------|---|
| 1031 | 3'-0" | 6'-8" | 1.75" | WOOD | BLINDS | 1 | A | |
| 1051 | 3'-0" | 6'-8" | 1.75" | WOOD | BLINDS | 1 | - | |
| 1052 | 3'-0" | 6'-8" | 1.75" | WOOD | BLINDS | 1 | - | |
| 1053 | 3'-0" | 6'-8" | 1.75" | WOOD | BLINDS | 1 | - | |
| 1054 | 3'-0" | 6'-8" | 1.75" | WOOD | BLINDS | 1 | - | |
| EX01 | 3'-0" | 6'-8" | - | WOOD | - | 1 | - | EXISTING DOORS & FRAMES TO BE REINSTALLED |
| EX02 | 3'-0" | 6'-8" | - | WOOD | - | 1 | - | EXISTING DOORS & FRAMES TO BE REINSTALLED |
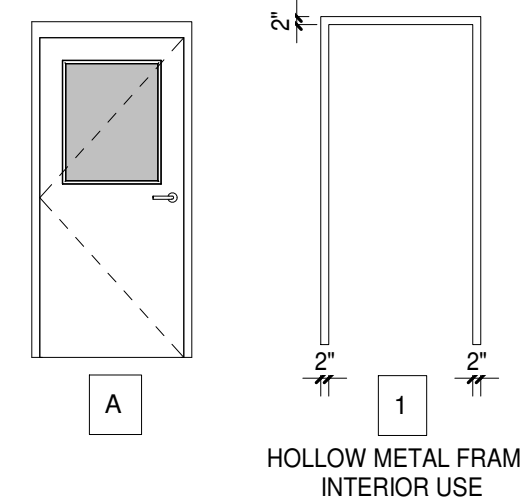
| ROOM NAME | FINISH | | | | | CEILING HEIGHT | COMMENTS |
|------------------------|-----------------|-----------------|-------|---------|------------------|---|----------|
| | FLOOR | BASE | WALL | CEILING | EXTG GRID | | |
| CIRCULATION OFFICE | EXTG CPT REMAIN | WOOD MATCH EXTG | PAINT | A.C.T. | EXTG GRID REMAIN | WOOD BASE APPEARS TO BE CLEAR-FINISHED WHITE OAK, 4/4 THICK X 5.5" TALL | |
| CHECK-IN & SORTING | - | - | - | - | - | WHERE NEW WALLS MEET EXTG. MATCH FINISH LEVELS, PAINT COLORS | |
| SELF-SERVE CIRC. FRONT | - | - | - | - | - | | |
| CLASSROOM | - | - | - | - | - | | |
| STUDY RM 154 | - | - | - | - | - | | |
| STUDY RM 155 | - | - | - | - | - | | |

2 METAL WINDOW FRAMES
A005 1 1/2" = 1'-0"

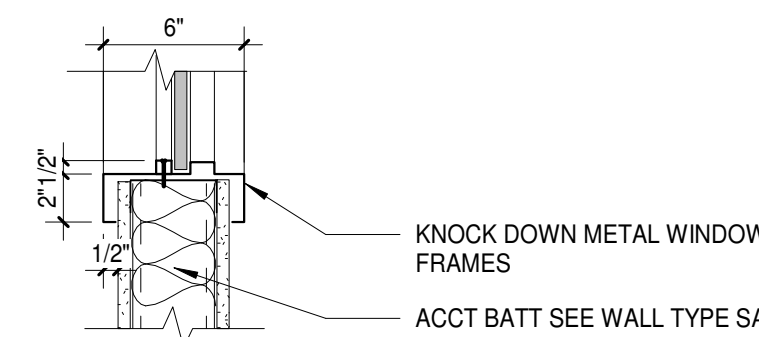

1 NEW NORTH WALL WINDOW
A005 1/4" = 1'-0"

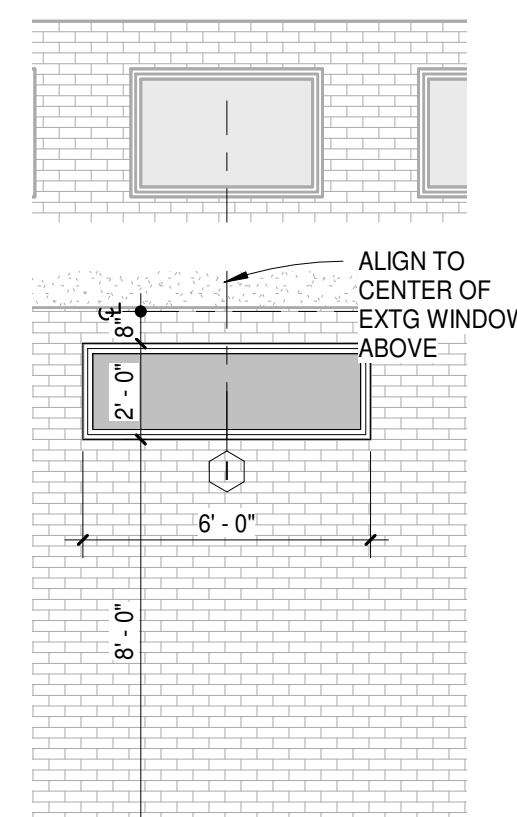

| WALL TYPE | MEMBER THICKNESS | WALL FRAMING PRIORITY | | | | | | | | | | | | | | | | | | | | | | | | | | | | | | | | | | | | | | |
|---|
| M - MASONRY S - STEEL STUD W - WOOD STUD C - CHASE WALL E - SHAFT WALL | <table border="1"> <thead> <tr> <th>FLOORING</th> <th>STEEL STUD</th> <th>WOOD STUD</th> <th>SHAFT WALL</th> </tr> </thead> <tbody> <tr> <td>L - LAMINATED</td> <td>1 - 1 5/8" STUD</td> <td>1 - 1 1/2" NAILER</td> <td>2 - 2 1/2" CH STUD</td> </tr> <tr> <td>0 - 7/8" HAT</td> <td>2 - 2 1/2" STUD</td> <td>3 - 2 x 4" STUD</td> <td>4 - 4" CH STUD</td> </tr> <tr> <td>1 - 1 1/2" HAT</td> <td>3 - 3 5/8" STUD</td> <td>6 - 2 x 6" STUD</td> <td>6 - 6" CH STUD</td> </tr> <tr> <td></td> <td>4 - 4" STUD</td> <td>8 - 2 x 8" STUD</td> <td>8 - 8" CMU</td> </tr> <tr> <td></td> <td>6 - 6" STUD</td> <td></td> <td></td> </tr> <tr> <td></td> <td>8 - 8" STUD</td> <td></td> <td></td> </tr> </tbody> </table> | FLOORING | STEEL STUD | WOOD STUD | SHAFT WALL | L - LAMINATED | 1 - 1 5/8" STUD | 1 - 1 1/2" NAILER | 2 - 2 1/2" CH STUD | 0 - 7/8" HAT | 2 - 2 1/2" STUD | 3 - 2 x 4" STUD | 4 - 4" CH STUD | 1 - 1 1/2" HAT | 3 - 3 5/8" STUD | 6 - 2 x 6" STUD | 6 - 6" CH STUD | | 4 - 4" STUD | 8 - 2 x 8" STUD | 8 - 8" CMU | | 6 - 6" STUD | | | | 8 - 8" STUD | | | <p>PARTITIONS SHALL BE PRIORITIZED BASED ON FIRE AND SMOKE RATING. PARTITIONS SHALL BE CONSTRUCTED SUCH THAT HIGHER PRIORITY IS FRAMED BEFORE LOWER PRIORITY. LOWER PRIORITY PARTITIONS SHALL BE FRAMED TIGHT TO, BUT NOT INTERRUPT HIGHER PRIORITY CONSTRUCTION. (SEE THE EXAMPLE BELOW)</p> <table border="1"> <thead> <tr> <th>2 HOUR FIRE RATED WITH SMOKE BARRIER</th> <th>PRIORITY 1 (HIGHEST)</th> </tr> </thead> <tbody> <tr> <td>1 HOUR FIRE RATED WITH SMOKE BARRIER</td> <td>PRIORITY 2</td> </tr> <tr> <td>1 HOUR FIRE RATED</td> <td>PRIORITY 3</td> </tr> <tr> <td>NONE RATED</td> <td>PRIORITY 4</td> </tr> <tr> <td></td> <td>PRIORITY 5 (LOWEST)</td> </tr> </tbody> </table> | 2 HOUR FIRE RATED WITH SMOKE BARRIER | PRIORITY 1 (HIGHEST) | 1 HOUR FIRE RATED WITH SMOKE BARRIER | PRIORITY 2 | 1 HOUR FIRE RATED | PRIORITY 3 | NONE RATED | PRIORITY 4 | | PRIORITY 5 (LOWEST) |
| FLOORING | STEEL STUD | WOOD STUD | SHAFT WALL | | | | | | | | | | | | | | | | | | | | | | | | | | | | | | | | | | | | | |
| L - LAMINATED | 1 - 1 5/8" STUD | 1 - 1 1/2" NAILER | 2 - 2 1/2" CH STUD | | | | | | | | | | | | | | | | | | | | | | | | | | | | | | | | | | | | | |
| 0 - 7/8" HAT | 2 - 2 1/2" STUD | 3 - 2 x 4" STUD | 4 - 4" CH STUD | | | | | | | | | | | | | | | | | | | | | | | | | | | | | | | | | | | | | |
| 1 - 1 1/2" HAT | 3 - 3 5/8" STUD | 6 - 2 x 6" STUD | 6 - 6" CH STUD | | | | | | | | | | | | | | | | | | | | | | | | | | | | | | | | | | | | | |
| | 4 - 4" STUD | 8 - 2 x 8" STUD | 8 - 8" CMU | | | | | | | | | | | | | | | | | | | | | | | | | | | | | | | | | | | | | |
| | 6 - 6" STUD | | | | | | | | | | | | | | | | | | | | | | | | | | | | | | | | | | | | | | | |
| | 8 - 8" STUD | | | | | | | | | | | | | | | | | | | | | | | | | | | | | | | | | | | | | | | |
| 2 HOUR FIRE RATED WITH SMOKE BARRIER | PRIORITY 1 (HIGHEST) | | | | | | | | | | | | | | | | | | | | | | | | | | | | | | | | | | | | | | | |
| 1 HOUR FIRE RATED WITH SMOKE BARRIER | PRIORITY 2 | | | | | | | | | | | | | | | | | | | | | | | | | | | | | | | | | | | | | | | |
| 1 HOUR FIRE RATED | PRIORITY 3 | | | | | | | | | | | | | | | | | | | | | | | | | | | | | | | | | | | | | | | |
| NONE RATED | PRIORITY 4 | | | | | | | | | | | | | | | | | | | | | | | | | | | | | | | | | | | | | | | |
| | PRIORITY 5 (LOWEST) | | | | | | | | | | | | | | | | | | | | | | | | | | | | | | | | | | | | | | | |

WALL TAG LEGEND
3/4" = 1'-0"

GENERAL NOTES

- THE CONTRACTOR SHALL MAINTAIN ALL EXISTING EMERGENCY LIGHTING, EXITING, SECURITY, AND ALARMS FOR THE ENTIRE SITE. ANY VARIATIONS OF EXISTING SYSTEMS SHALL BE COORDINATED WITH THE OWNER. THE CONTRACTOR SHALL TAKE ALL NECESSARY PRECAUTIONS PRESCRIBED BY ALL LAWS, ORDINANCES, CODES, REGULATIONS AND ALL AUTHORITIES HAVING JURISDICTION TO PREVENT INJURY TO ANY PERSONS ON, ABOUT, OR ADJACENT TO THE CONSTRUCTION SITE.
- THE GENERAL CONTRACTOR SHALL BE RESPONSIBLE FOR THE REGULAR REMOVAL OF ALL WASTE MATERIAL FROM THE PROJECT SITE. ALL ITEMS AND MATERIALS REMOVED FROM THE SITE SHALL BE DISPOSED OF AS SPECIFIED. ON SITE BURNING IS PROHIBITED. ALL AREAS ADJACENT TO THE DEMOLITION ARE SHALL BE KEPT CLEAN. ALL DEMOLITION AREAS SHALL BE CLEANED AND READY FOR NEW CONSTRUCTION AT THE END OF THE DEMOLITION.
- IF THE CONTRACTOR IDENTIFIES ANY CONFLICTS OR OMISSIONS ON THE DRAWINGS, THE ARCHITECT SHALL BE NOTIFIED IMMEDIATELY.
- ALL EXPOSED INTERIOR AND EXTERIOR MISC. METALS, JOISTS, DECKS, COLUMNS, BEAMS, LINTELS, ANGLES, BRACKETS, ETC. SHALL BE PAINTED. COLOR SELECTION TO BE DETERMINED BY ARCHITECT.
- CONTRACTOR SHALL NOT SCALE THE DRAWINGS. IF DIMENSIONS ARE UNCLEAR NOTIFY THE ARCHITECT IMMEDIATELY FOR CLARIFICATION.
- THE GENERAL CONTRACTOR SHALL VERIFY THAT ALL REQUIRED CLEARANCES FOR INSTALLATION AND MAINTENANCE OF ALL MECHANICAL, ELECTRICAL, DUCTWORK AND CONDUIT ARE PROVIDED. SHOULD ANY CONFLICT EXIST, THE GENERAL CONTRACTOR SHALL ADVISE THE ARCHITECT BEFORE PROCEEDING WITH CONSTRUCTION.
- THE GENERAL CONTRACTOR SHALL BE RESPONSIBLE FOR COMPLETING ALL WORK IN ACCORDANCE WITH ALL APPLICABLE CODES IN EFFECT AT THE TIME OF CONSTRUCTION.
- THE BUILDING IS DESIGNED TO BE STRUCTURALLY SELF-SUPPORTING & STABLE AFTER THE BUILDING IS FULLY COMPLETED. IT IS THE CONTRACTOR'S SOLE RESPONSIBILITY TO DETERMINE ALL ERECTION MEANS, METHODS, PROCEDURES & SEQUENCING TO DETERMINE THE ADEQUACY & STRENGTH OF ANY PARTS OF THE STRUCTURE BEING USED AS TEMPORARY SUPPORTS; TO DETERMINE THE STRUCTURE OF ELEMENTS BEING USED AS TEMPORARY SUPPORTS THROUGHOUT THE CONSTRUCTION PERIOD & TO ENSURE THE SAFETY OF THE BUILDING AND ITS COMPONENT PARTS DURING CONSTRUCTION. THE SUB-CRONTACTORS SHALL CAREFULLY COORDINATE THEIR ACTIVITIES THROUGH THE GENERAL CONTRACTOR TO ACHIEVE THESE REQUIREMENTS.
- THE CONTRACTOR SHALL BE RESPONSIBLE FOR PROVIDING TEMPORARY BRACING, GUYS, SHORING OR TIE-DOWNS AS REQUIRED TO EXECUTE CONSTRUCTION SEQUENCE. SUCH TEMPORARY MATERIALS SHALL BE REMOVED BY THE CONTRACTOR AFTER COMPLETION OF THE PROJECT.
- THE GENERAL CONTRACTOR AND THEIR SUBCONTRACTORS SHALL REVIEW THE LAYOUT AND EXACT LOCATION OF ALL PARTITIONS, DOORS, ELECTRICAL/TELEPHONE OUTLETS, LIGHT SWITCHES AND THERMOSTATS AND ADVISE THE ARCHITECT OF ANY CONFLICT BEFORE PROCEEDING WITH CONSTRUCTION.
- "TYPICAL" MEANS IDENTICAL FOR ALL SIMILAR CONDITIONS UNLESS OTHERWISE NOTED.
- "SIMILAR" MEANS COMPARABLE CHARACTERISTICS FOR THE CONDITION.
- NOT USED
- PROVIDE INTERIOR SIGNS W/ BRAILLE FOR ALL SPACES REQUIRED BY CODE. ALL SIGNS SHALL MEET AND BE INSTALLED PER IBC 2012 AND ANSI 117 2009 REQUIREMENTS.
- PORTABLE FIRE EXTINGUISHERS HAVING A GROSS WEIGHT NOT EXCEEDING 40 POUNDS SHALL BE INSTALLED SO THAT THE TOP IS NOT MORE THAN 5'-0" FROM FINISHED FLOOR. THE MINIMUM HEIGHT BETWEEN THE FINISH FLOOR AND THE BOTTOM OF THE EXTINGUISHERS SHALL NOT BE LESS THAN 4 INCHES.
- CONTRACTOR SHALL PROVIDE SHOP DRAWINGS FOR ARCHITECT'S REVIEW FOR ALL PRE-MANUFACTURED COMPONENTS PRIOR TO PURCHASE.
- CONTRACTOR SHALL PROVIDE CUT SHEETS FOR ARCHITECT'S REVIEW FOR ALL MATERIALS, FIXTURES & EQUIPMENT PRIOR TO PURCHASE.

GENERAL PARTITION NOTES:

- PLAN DIMENSIONS ARE FACE OF STUD, CMU OR FINISH FACE OF EXISTING WALL CONSTRUCTION UNLESS SPECIFICALLY NOTED OTHERWISE
- REFERENCE ALL FLOOR PLANS AND LIFE SAFETY PLANS FOR RATED WALL LOCATIONS & RATINGS.
- AT ALL UL RATED WALLS THAT EXTEND TO THE STRUCTURE ABOVE, FILL VOIDS SOLID WITH MINERAL WOOL INSULATION WHERE WALL IS FRAMED AROUND BEAMS, BAR JOISTS, SLABS, AND ROOF DECK. MAINTAIN SCHEDULED SOUND RATING. AT ALL SOUND RATED WALLS PROVIDE FLEXIBLE SEALANT OR AN ACOUSTICAL GASKET BETWEEN THE STC RATED SYSTEM AND ALL DISSIMILAR SURFACES (IE PENETRATIONS) AND ALSO BETWEEN THE SYSTEM AND SIMILAR SURFACES WHERE PERIMETER RELIEF IS REQUIRED. ALL OPENINGS THROUGH THE SYSTEM, AND ITS ENTIRE PERIMETER, SHALL BE SEALED AIRTIGHT. TAPING GYPSUM BOARD WALL AND WALL-CEILING INTERSECTIONS PROVIDES AN ADEQUATE AIR SEAL AT THESE LOCATIONS.
- PROVIDE DEFLECTION TRACK AT TOP OF WALL AT ALL CONNECTIONS TO THE STRUCTURE ABOVE.
- ANY PORTION OF GYPSUM BOARD THAT BECOMES WET OR SHOWS SIGNS OF MOISTURE DAMAGE, EITHER BEFORE OR AFTER INSTALLATION, IS TO BE REMOVED IMMEDIATELY AND REPLACED WITH NEW DRY GYPSUM BOARD.
- GENERAL CONTRACTOR SHALL VERIFY SPACING AND GAUGE OF INTERIOR STUDS, LIMITING HEIGHTS AND ALLOWABLE DEFLECTION FOR SPECIFIC APPLICATIONS BASED ON MANUFACTURERS REQUIREMENTS. AT A MINIMUM STUDS SHALL BE 20 GAUGE OR GREATER.
- SOUND ATTENUATION GASKET IS REQUIRED AT ALL INTERIOR PARTITIONS AND SHALL RUN FULL HEIGHT OF PARTITION UNLESS NOTED OTHERWISE. SOUND ATTENUATION BATT SHALL BE MADE OF MINERAL WOOL OR OTHER UL APPROVED MATERIAL.
- IT IS NOT THE INTENT OF THE DOCUMENTS TO IDENTIFY EACH INDIVIDUAL WALL WITH A WALL TAG. MINOR WALLS OR OTHER WALLS NOT TAGGED WILL BE OF THE SAME WALL TYPE AS ADJACENT WALLS.
- GYPSUM BOARD ON WALLS SHALL BE APPLIED WITH A MINIMUM 1/4" GAP BETWEEN THE GYPSUM BOARD AND THE FLOOR AND SHALL NOT BE APPLIED OVER OTHER BUILDING MATERIALS WHERE CONDITIONS EXIST THAT ARE FAVORABLE TO MOLD GROWTH.

TAMARA PEACOCK, R.A.
LICENSE NO. 12129

PROJ. DESIGNER
CAPT. APPROVER

DRAWN BY: AUTHOR
REVISED BY: CHECKER

| ISSUED FOR | REVISION DATE | REVISION |
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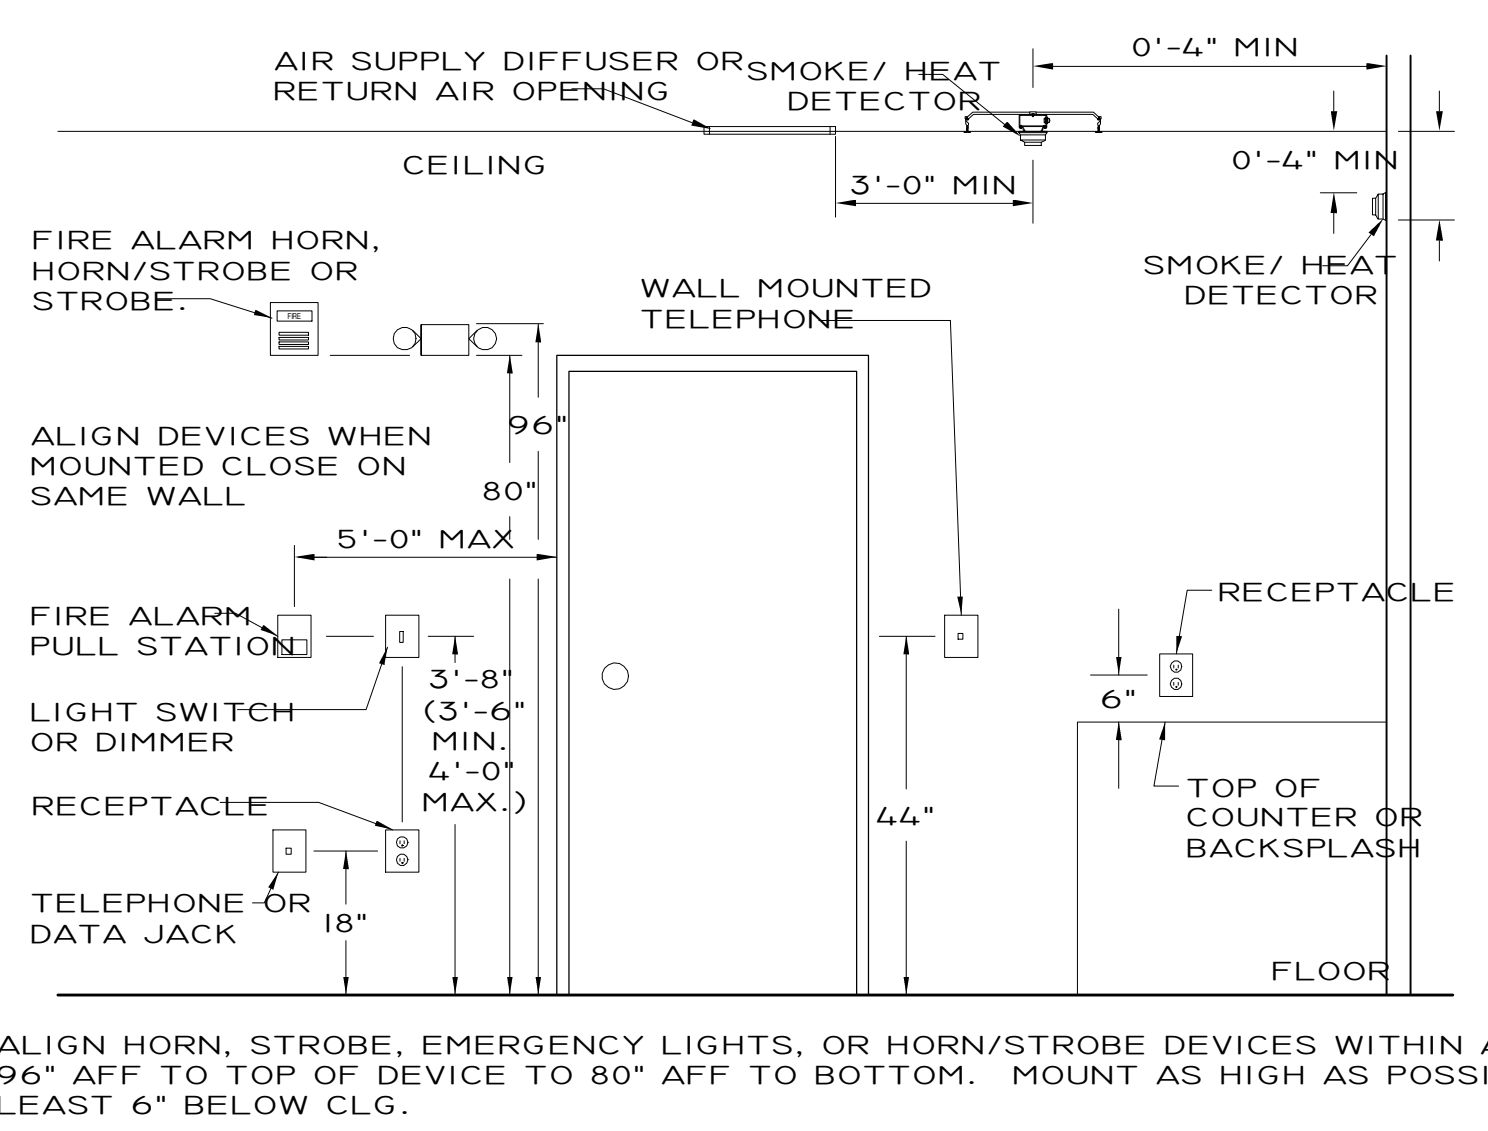
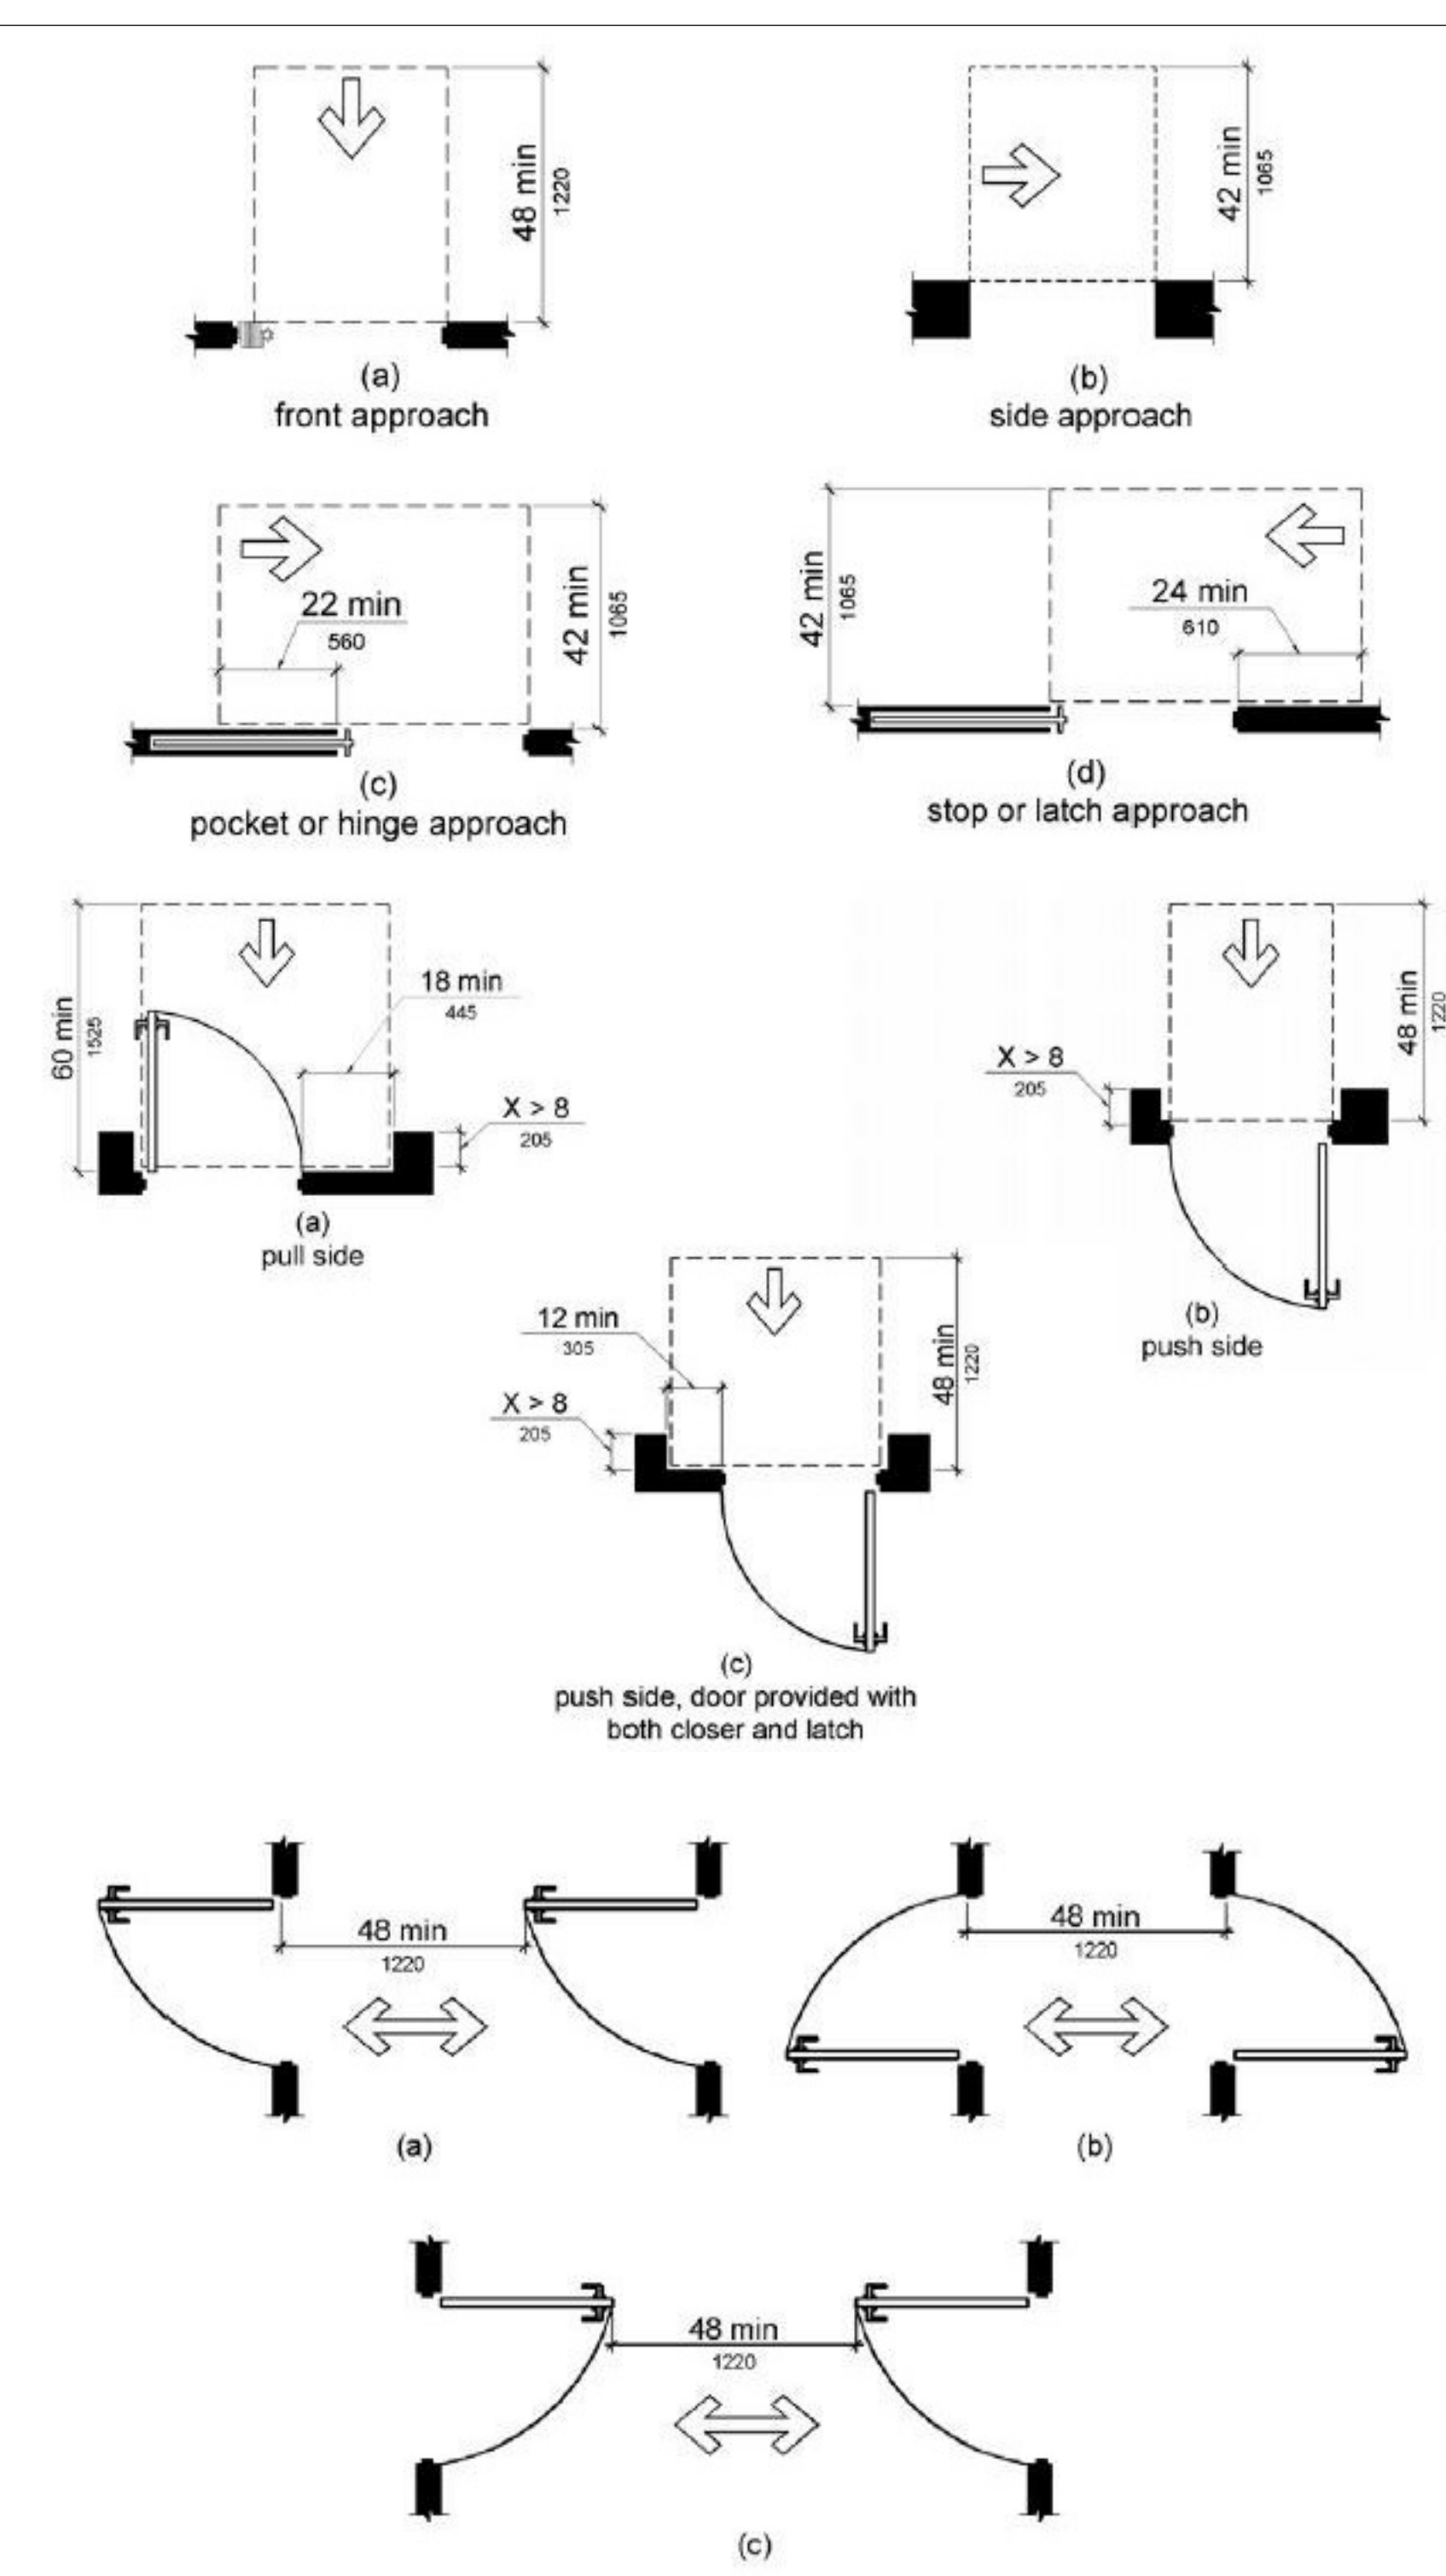
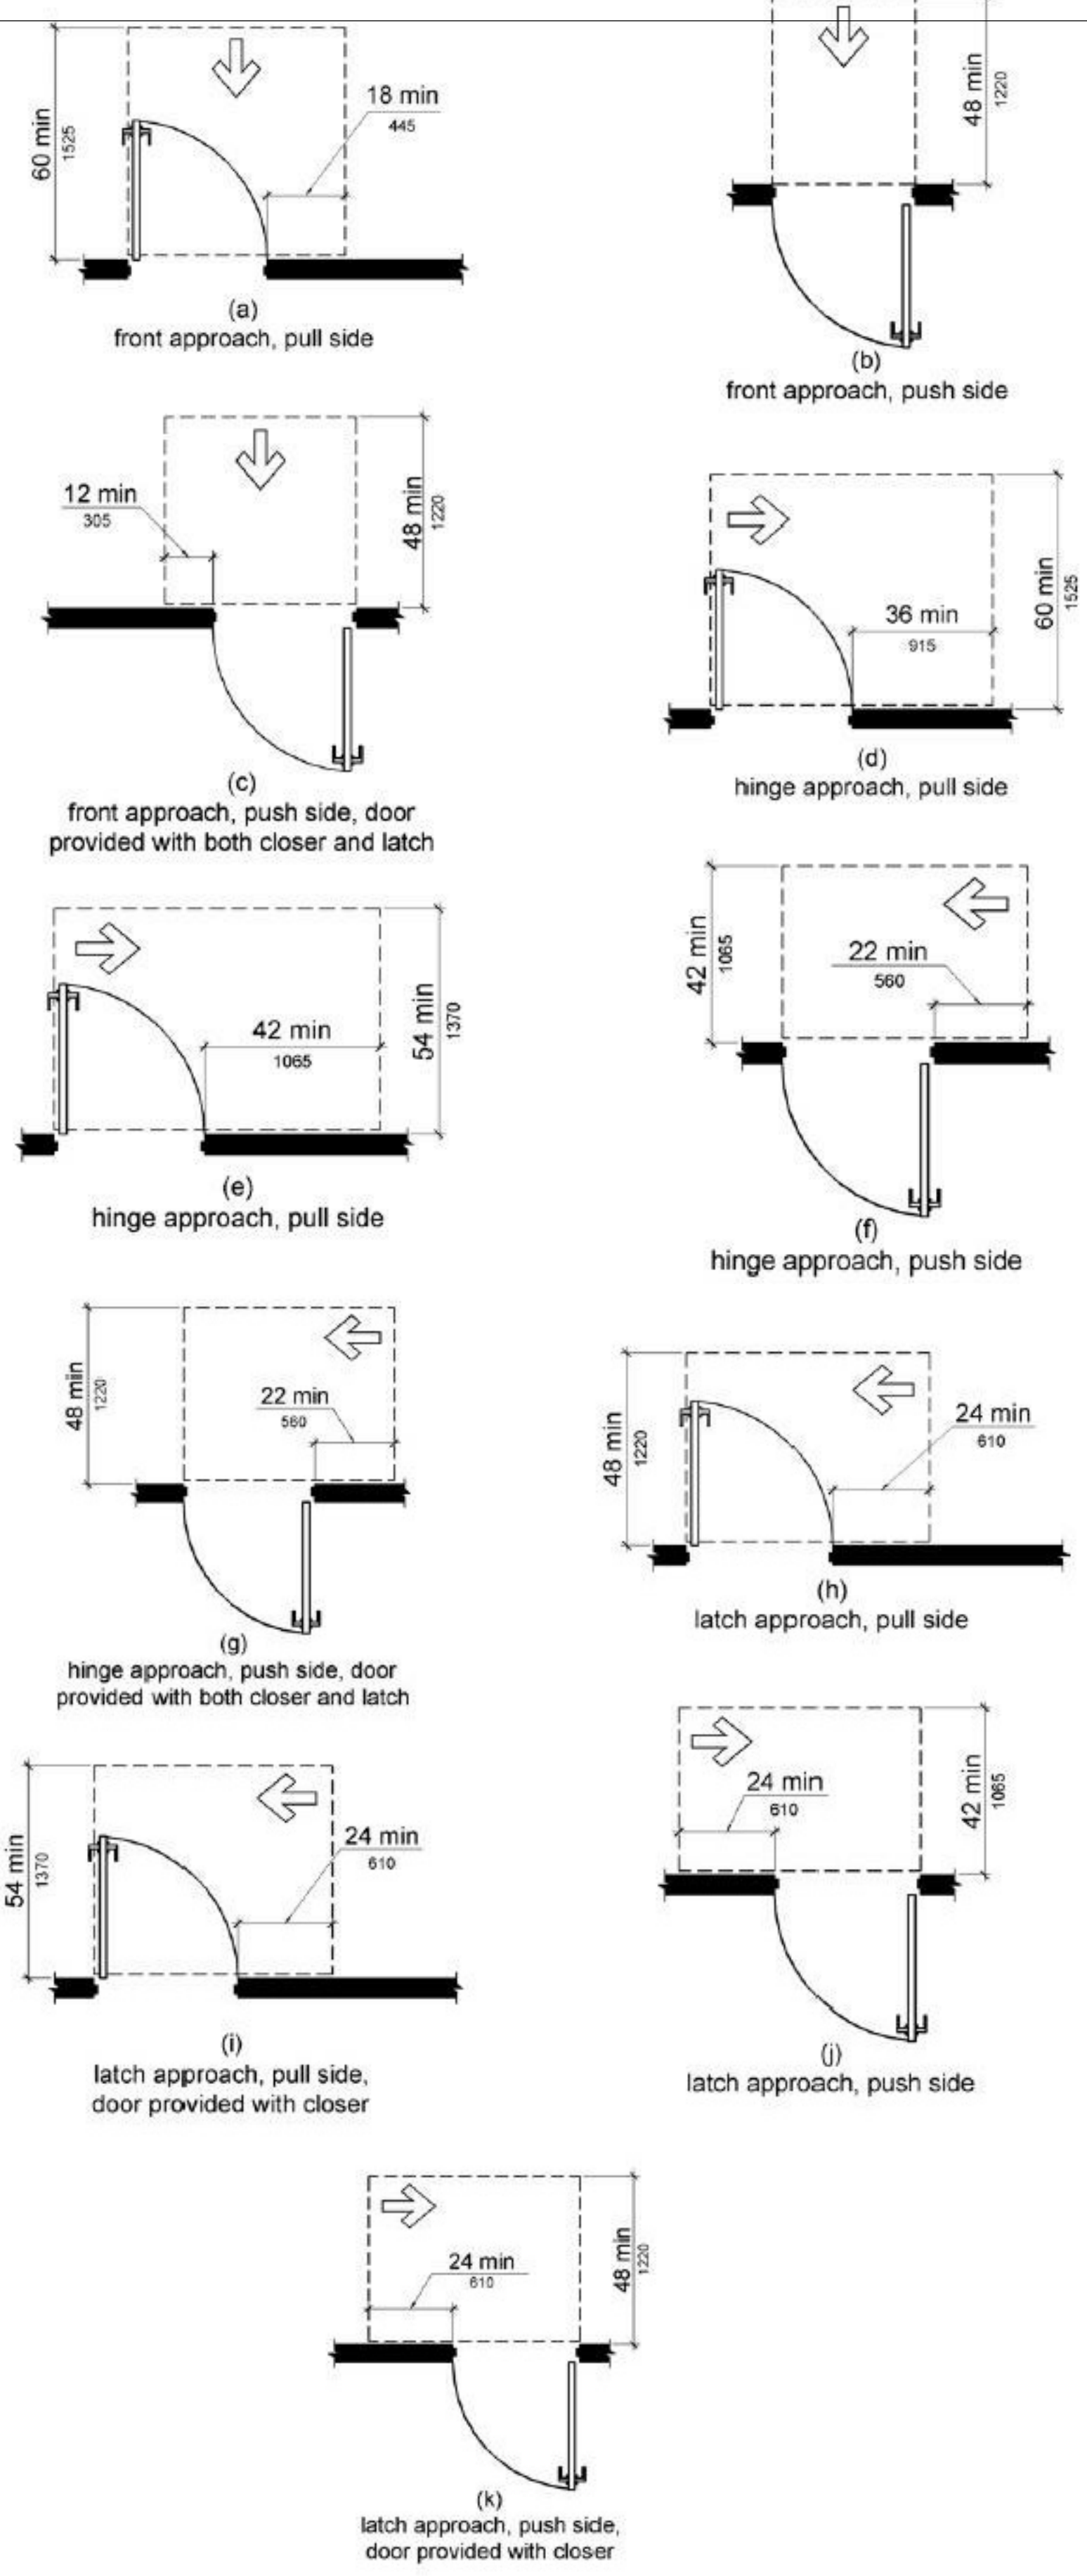
THE TAMARA PEACOCK COMPANY
Architects
104 1st Ave E. Hendersonville, NC 28792
Phone: 828.696.4000 Fax: 954.728.9225

PROJECT NAME:
Henderson Co. Public Library
301 N. WASHINGTON ST.
HENDERSONVILLE, NC 28792


SHEET NAME:
PARTITION TYPES - SCHEDULES
A005

PROJ. No. 1804
DATE: 8/3/2018
2:46:32 PM

BID SET
7-2018



NOTE:
 1. ALL DIMENSIONS SHOWN ARE MINIMUMS.
 2. DIMENSIONS AND CLEARANCES SHOWN MUST BE PROVIDED AT ALL DOORS.
 3. CONTRACTOR SHALL REVIEW FIELD LAYOUT AND CONFIRM THAT ALL OF THE APPROPRIATE CLEARANCES ARE PROVIDED. ANY DISCREPANCIES SHALL BE BROUGHT TO THE ARCHITECT'S ATTENTION. ANY REMEDIAL WORK THAT SHOULD HAVE BEEN AVOIDED BY BRINGING DISCREPANCIES TO THE ARCHITECT'S ATTENTION SHALL BE AT THE CONTRACTOR'S EXPENSE.

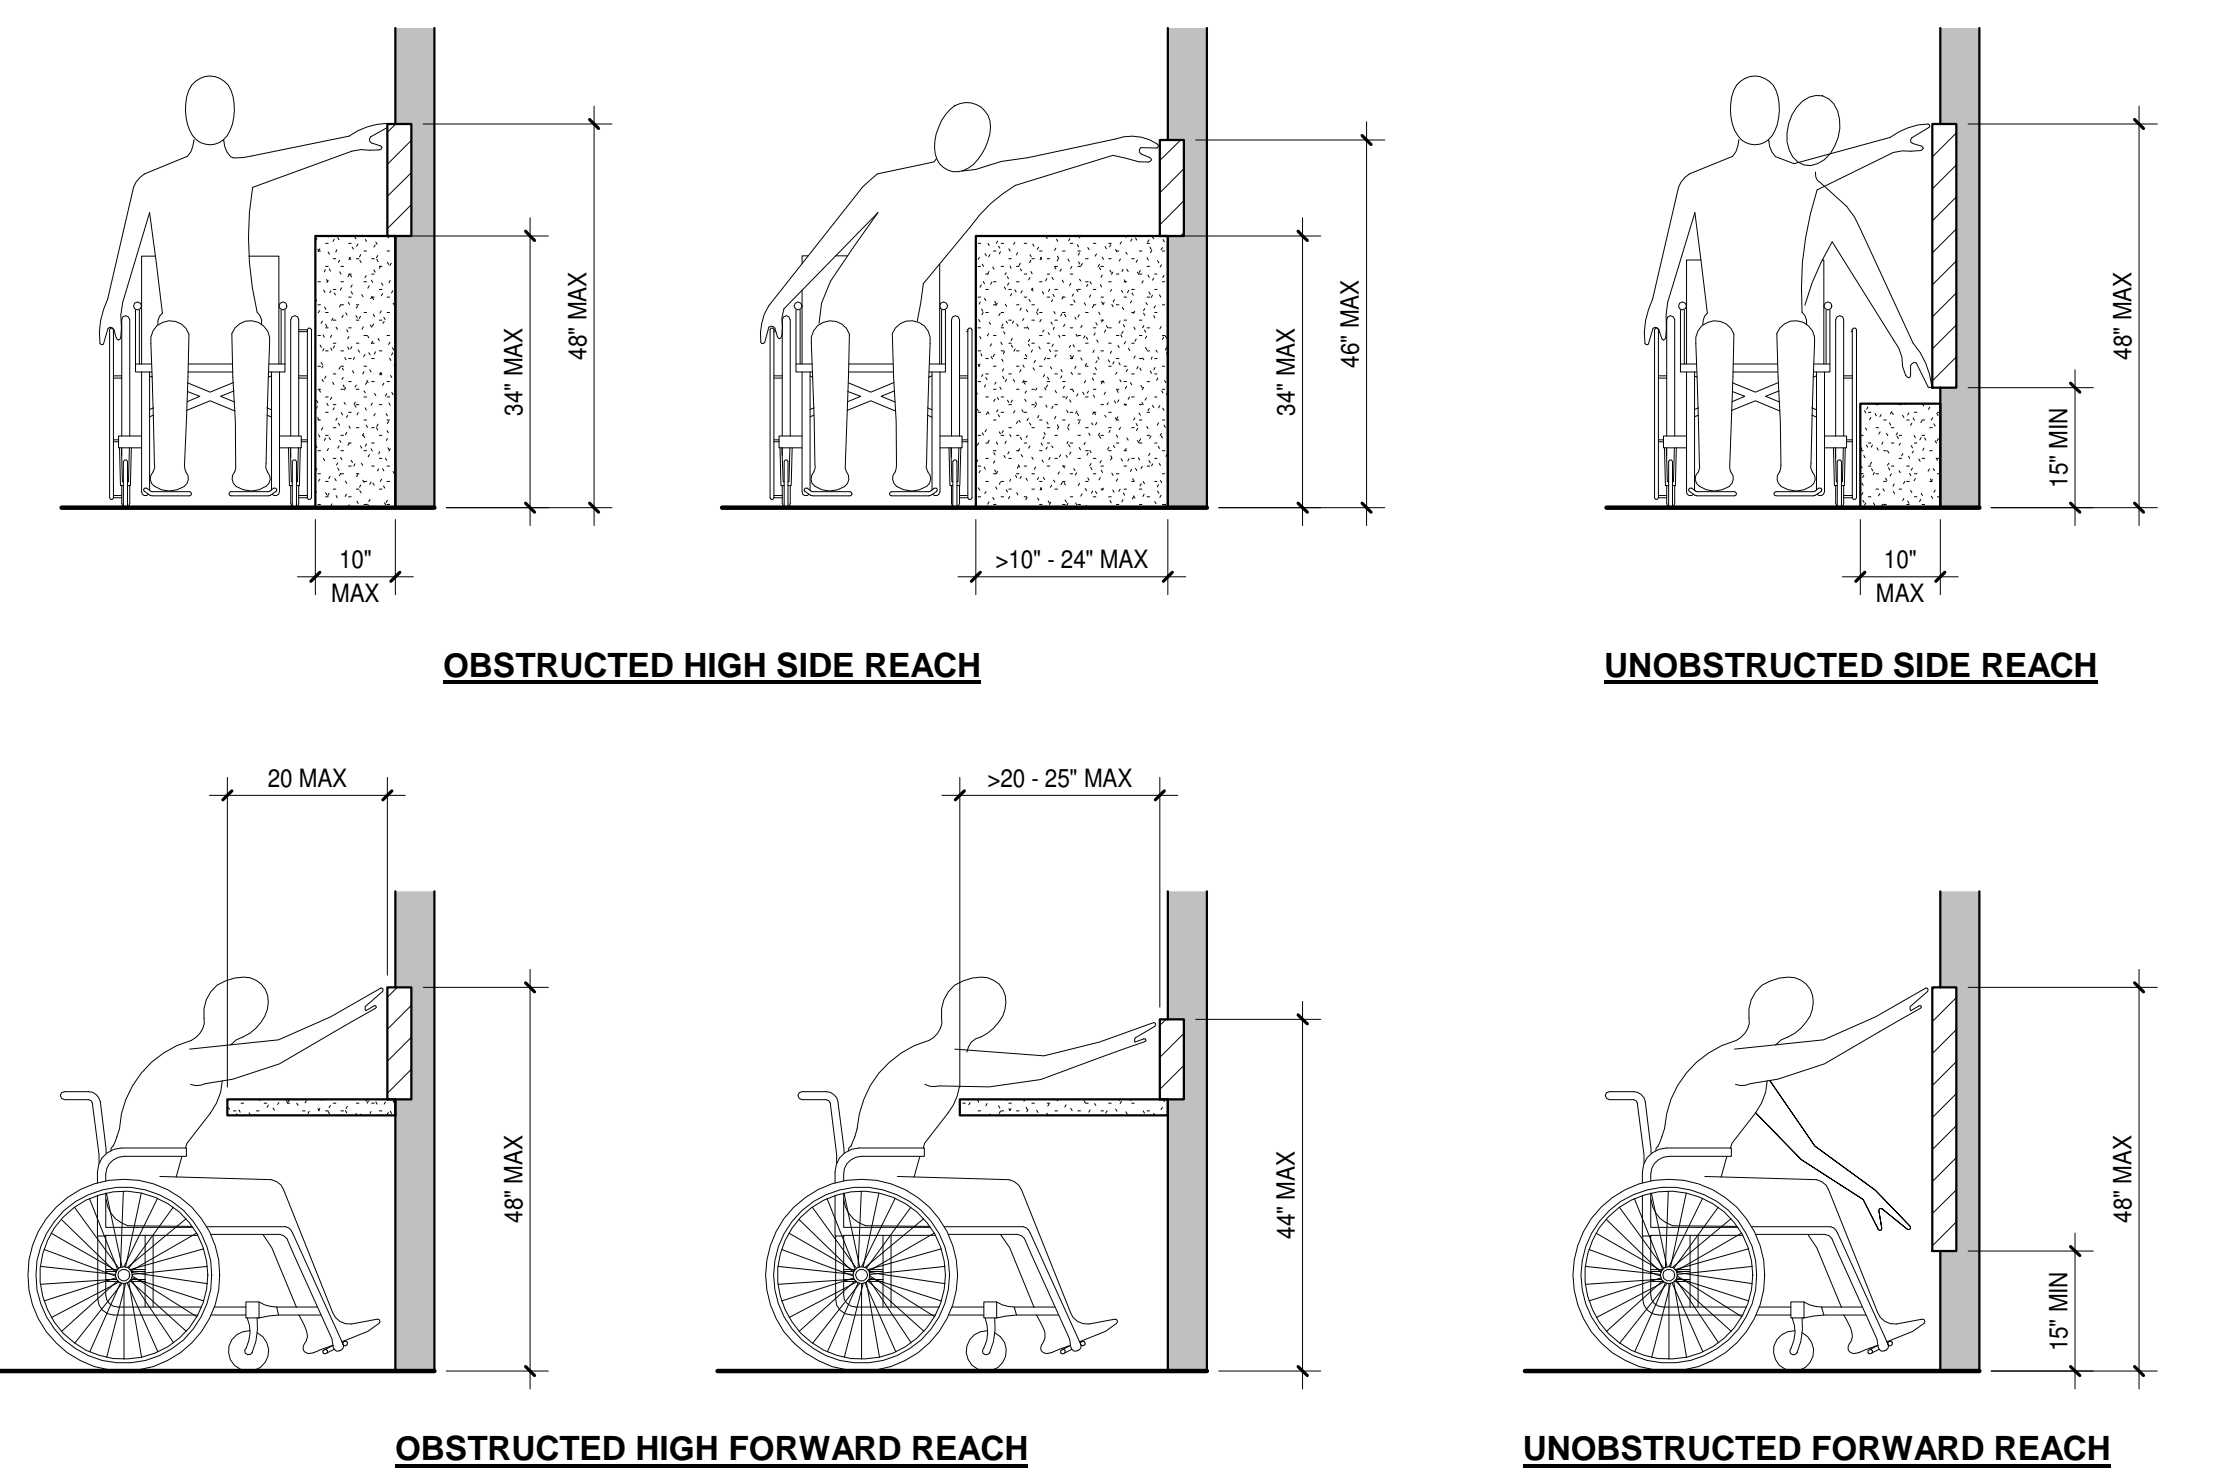

ADVISORY 308.1 GENERAL. THE FOLLOWING TABLE PROVIDES GUIDANCE ON REACH RANGES FOR CHILDREN ACCORDING TO AGE WHERE BUILDING ELEMENTS SUCH AS COAT HOOKS, LOCKERS, OR OPERABLE PARTS ARE DESIGNED FOR USE PRIMARILY BY CHILDREN. THESE DIMENSIONS APPLY TO EITHER FORWARD OR SIDE REACHES. ACCESSIBLE ELEMENTS AND OPERABLE PARTS DESIGNED FOR ADULT USE OR CHILDREN OVER AGE 12 CAN BE LOCATED OUTSIDE THESE RANGES BUT MUST BE WITHIN THE ADULT REACH RANGES REQUIRED BY 308

| FORWARD OR SIDE REACH | CHILDRENS REACH RANGES | | |
|-----------------------|------------------------|------------------|-------------------|
| | AGES 3 AND 4 | AGES 5 THROUGH 8 | AGES 9 THROUGH 12 |
| HIGH (MAX) | 36" | 40" | 44" |
| LOW (MIN) | 20" | 18" | 16" |

Maneuvering Clearances at Doors
 1/2" = 1'-0"

2 Device Mounting Heights
 A006 1/4" = 1'-0"

REACH RANGES

TAMARA PEACOCK, R.A.
 LICENSE NO. 12126

PROJ. DESIGNER: CAPT. APPROVER: DRAWN BY: AUTHOR: REVISIONS BY: CHECKER:

ISSUED FOR: REVISION: REVISION DATE:

THE TAMARA PEACOCK COMPANY
Architects


104 1st Ave E. Hendersonville, NC 28792
 Phone: 828.696.4000 Fax: 954.728.9225






PROJECT NAME:
Henderson Co. Public Library
 301 N. WASHINGTON ST.
 HENDERSONVILLE, NC 28792


SHEET NAME:
ACCESSIBILITY STANDARDS

PROJ. No. 1804 DATE: 8/3/2018
 2:4-6:33 PM
 SHEET No.: A006

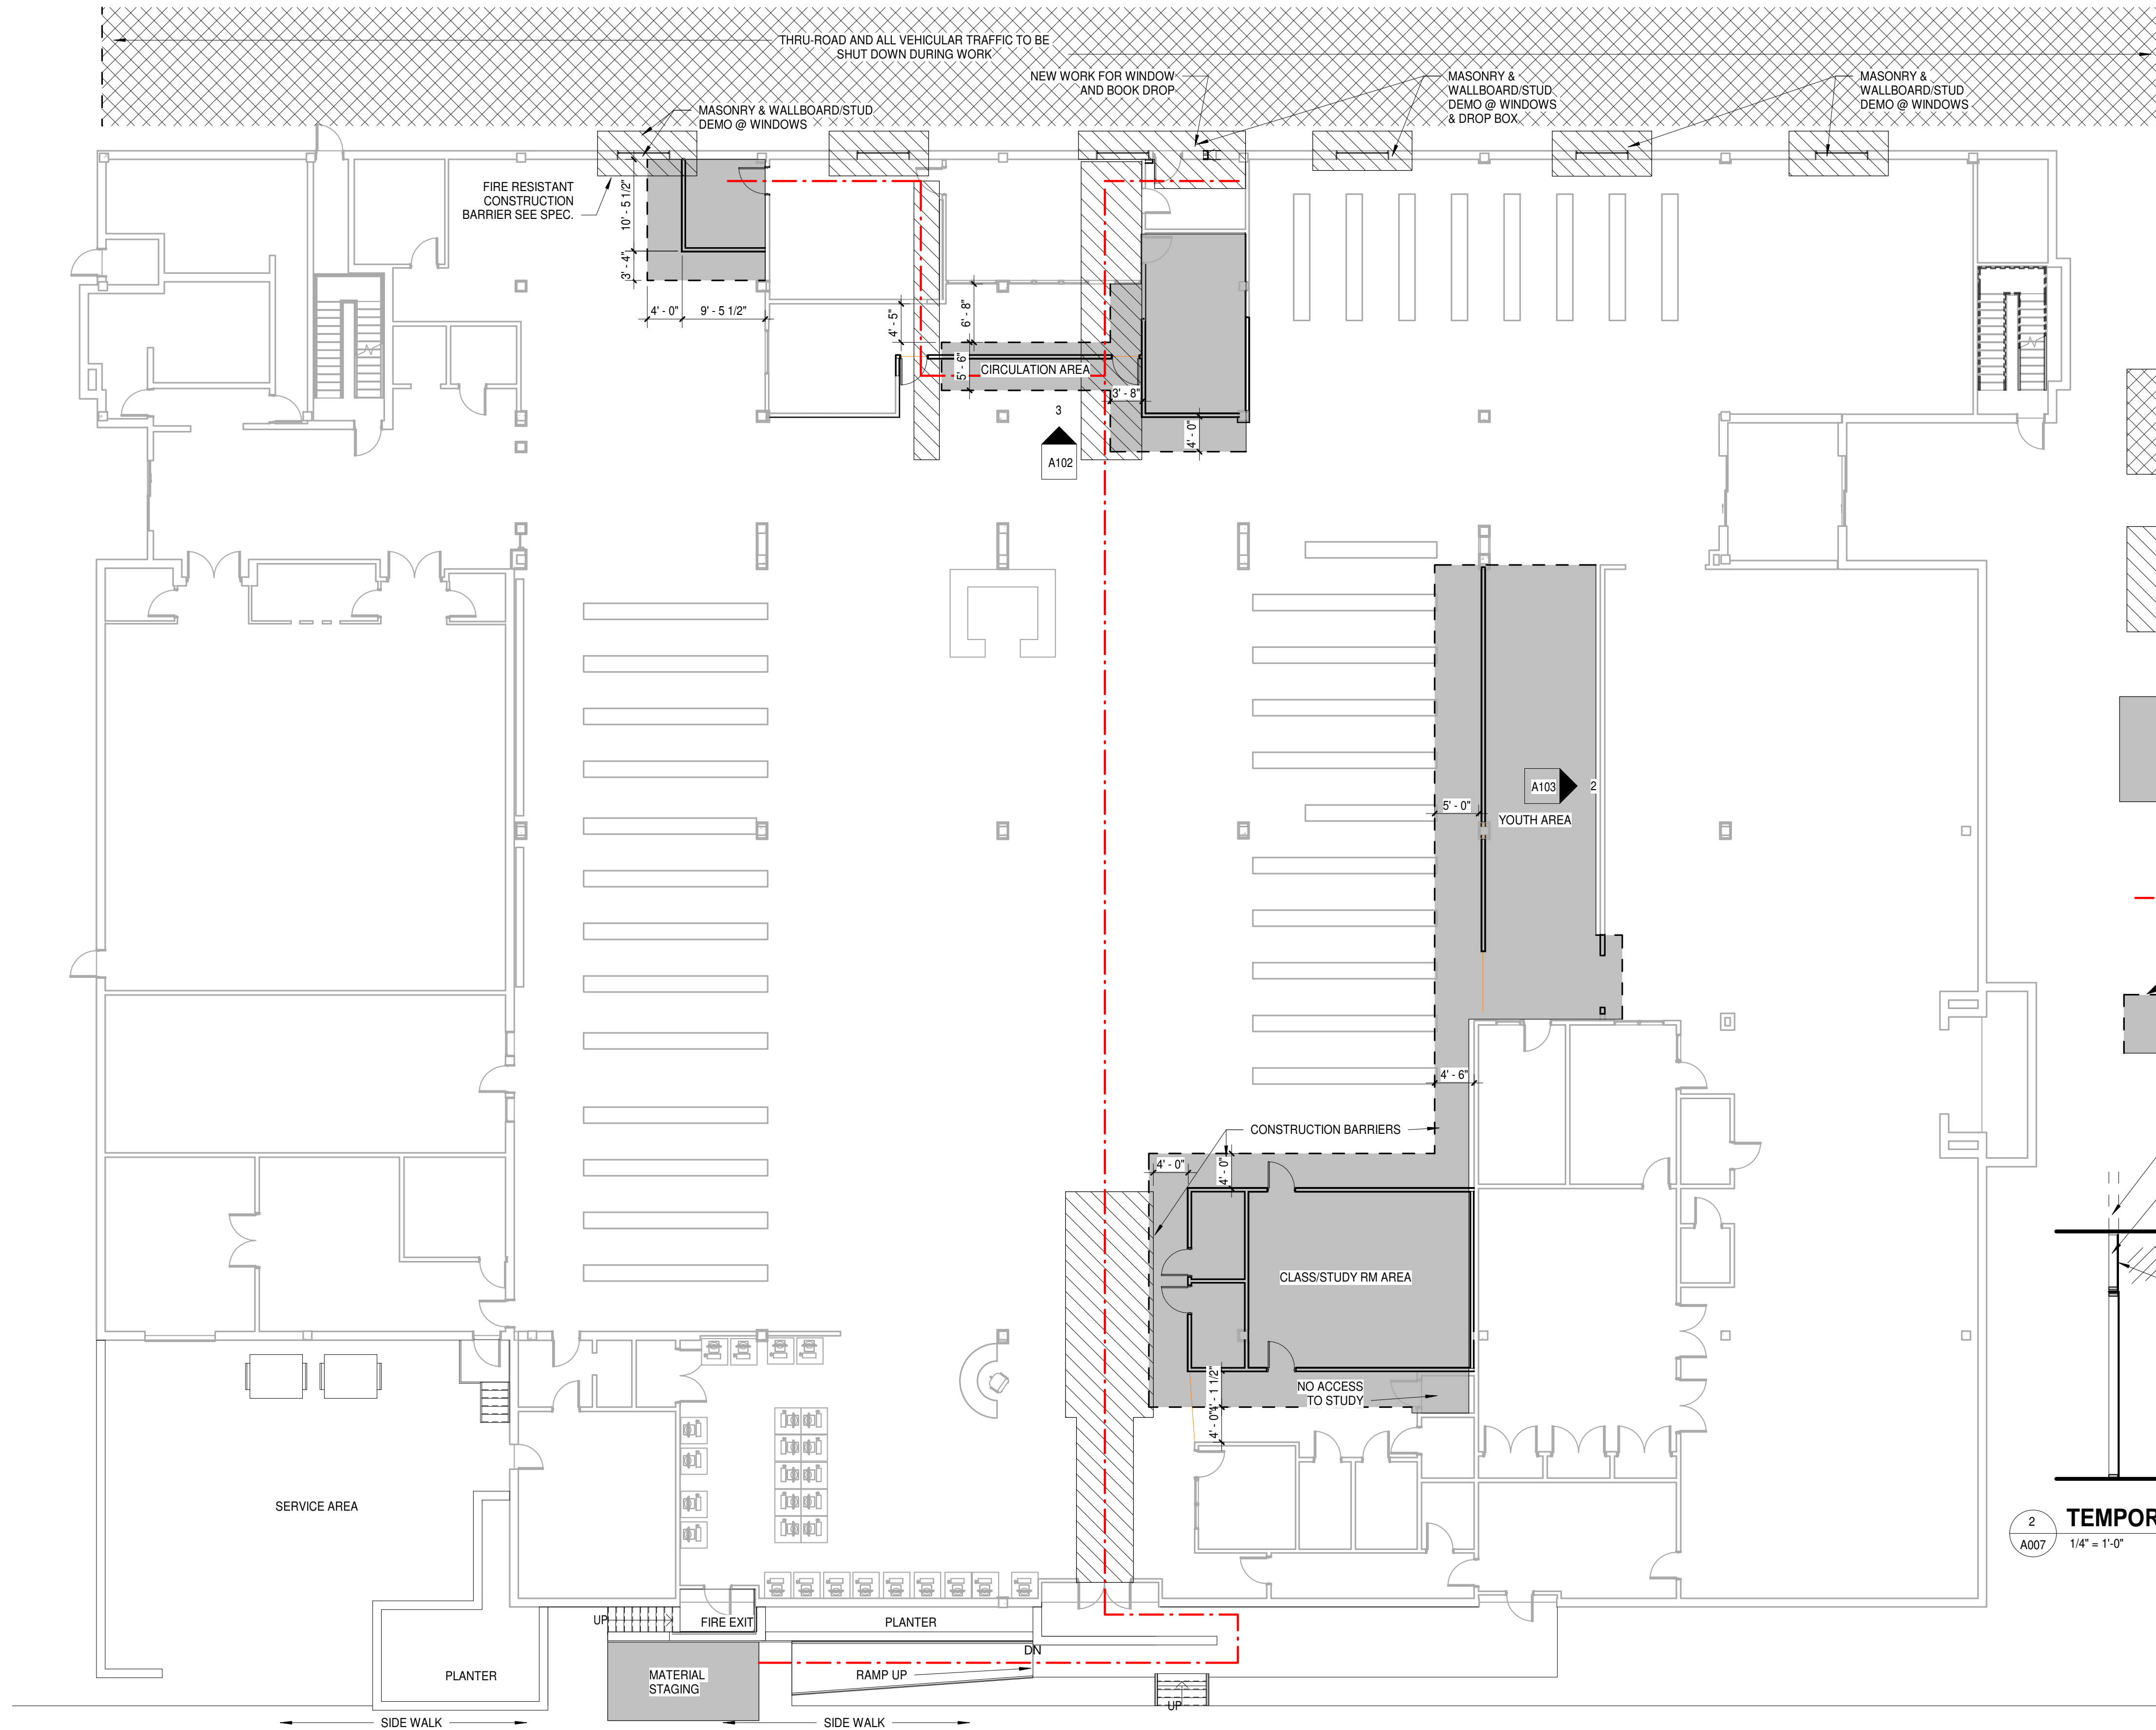BID SET
 7-2018

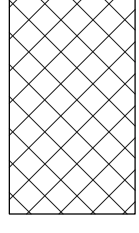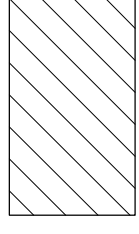

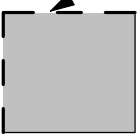-  TRAFFIC REDIRECTED TEMPORARILY
-  AREAS OF HIGH TRAFFIC: SHARED WITH TENANTS
-  RESTRICTED: CONSTRUCTION ACCESS ONLY. SEE DETAIL FOR BARRIER WALL. 2/A007
-  SUGGESTED STAGING PATH
-  CONSTRUCTION BARRIER (WHEN ENCLOSING MORE THAN 100 S.F. FIRE RESISTANT BARRIER IS REQUIRED)

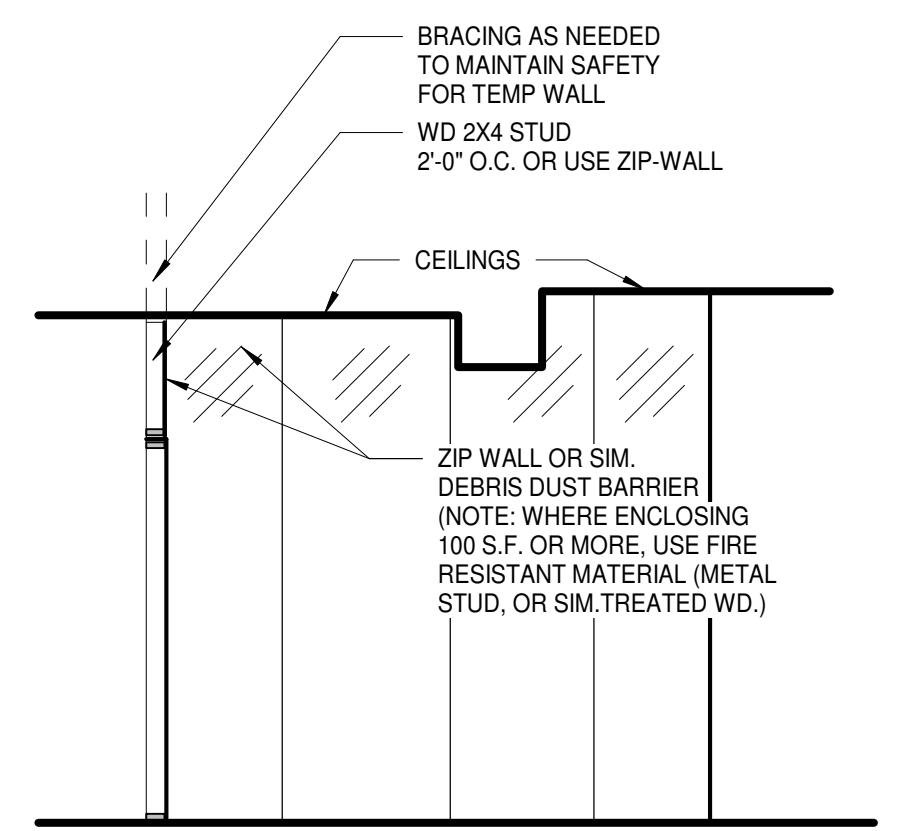


2
A007 1/4" = 1'-0"

TEMPORARY CONST PARTITION

1
A007 3/32" = 1'-0"

STAGING PLAN

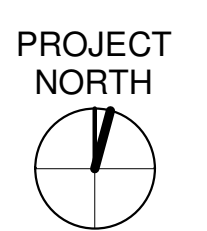

BID SET
7-2018

TAMARA PEACOCK, R.A.
LICENSE NO. 12126

| | |
|----------------|------------|
| DESIGNER | AUTHOR |
| CAPT. APPROVER | REVISED BY |
| | CHECKER |

| ISSUED FOR | REVISION | REVISION DATE |
|------------|----------|---------------|
| | | |





THE TAMARA PEACOCK COMPANY
Architects

104 1st Ave E. Hendersonville, NC 28792
Phone: 828.696.4000 Fax: 954.728.9225

PROJECT NAME:
Henderson Co. Public Library
301 N. WASHINGTON ST.
HENDERSONVILLE, NC 28792

SHEET NAME:
STAGING PLAN

PROJ. No. 1804 DATE: 8/3/2018
2:46:34
SHEET No.: PM
A007

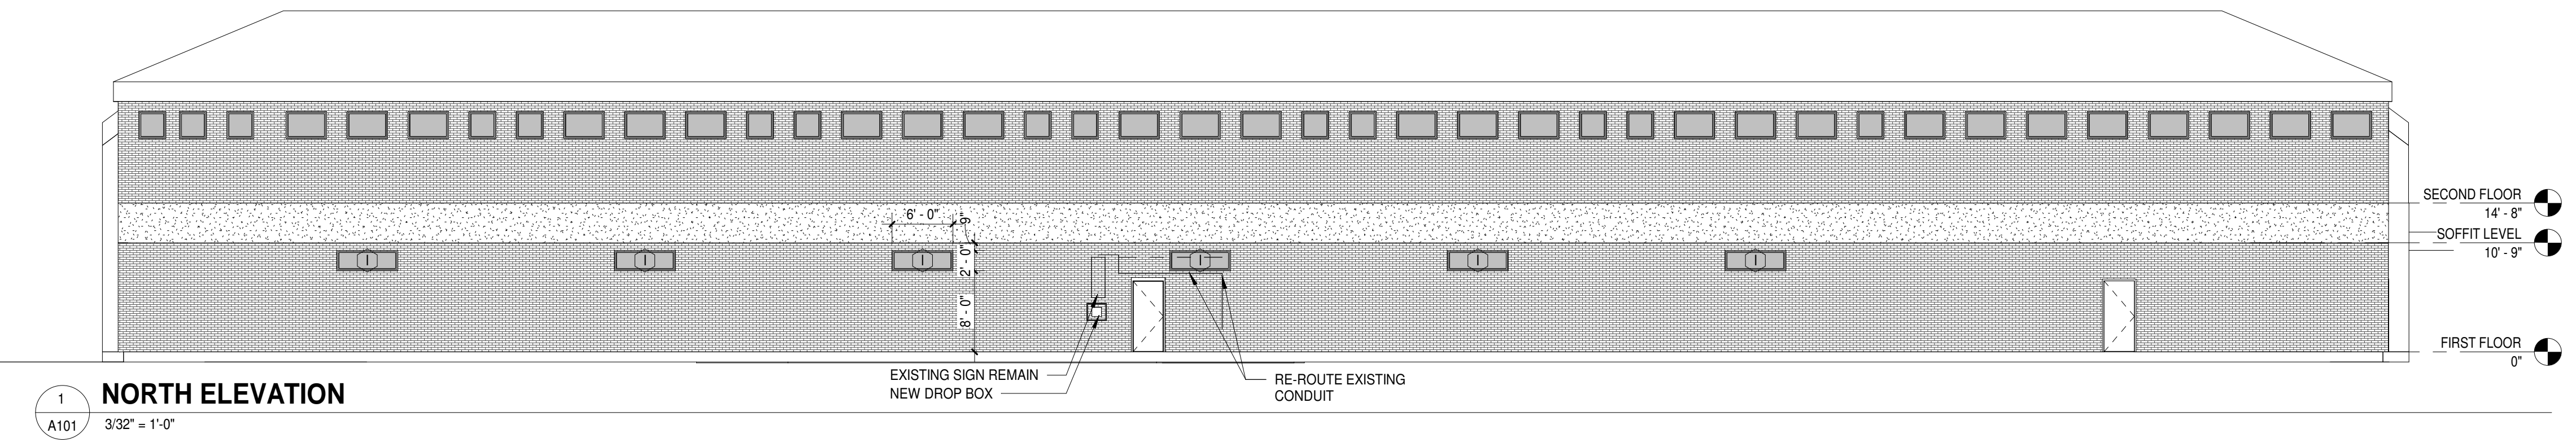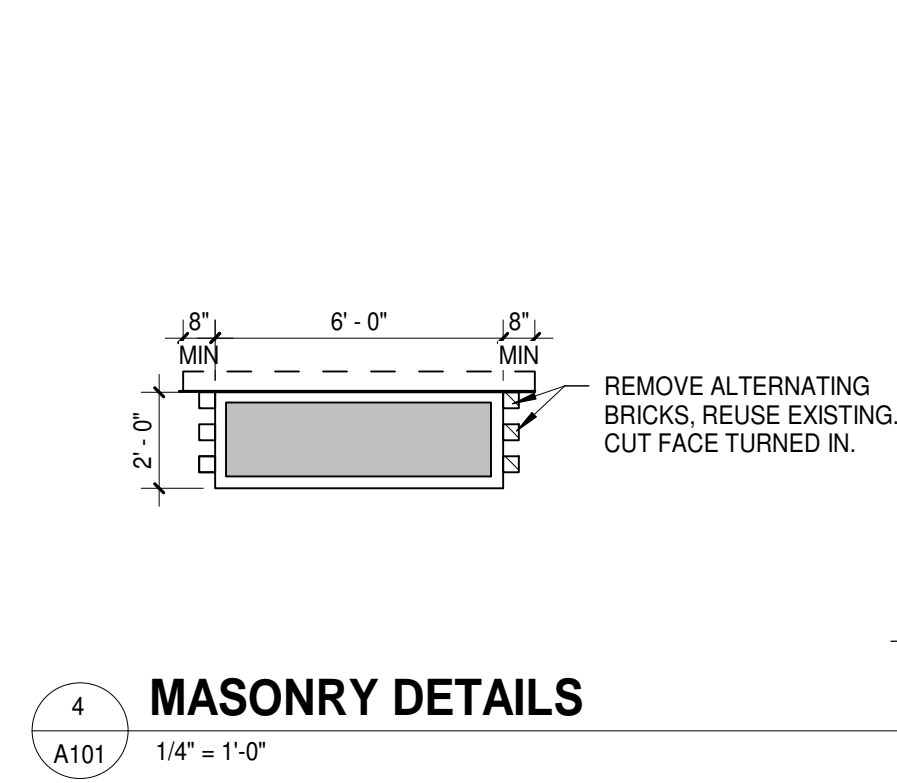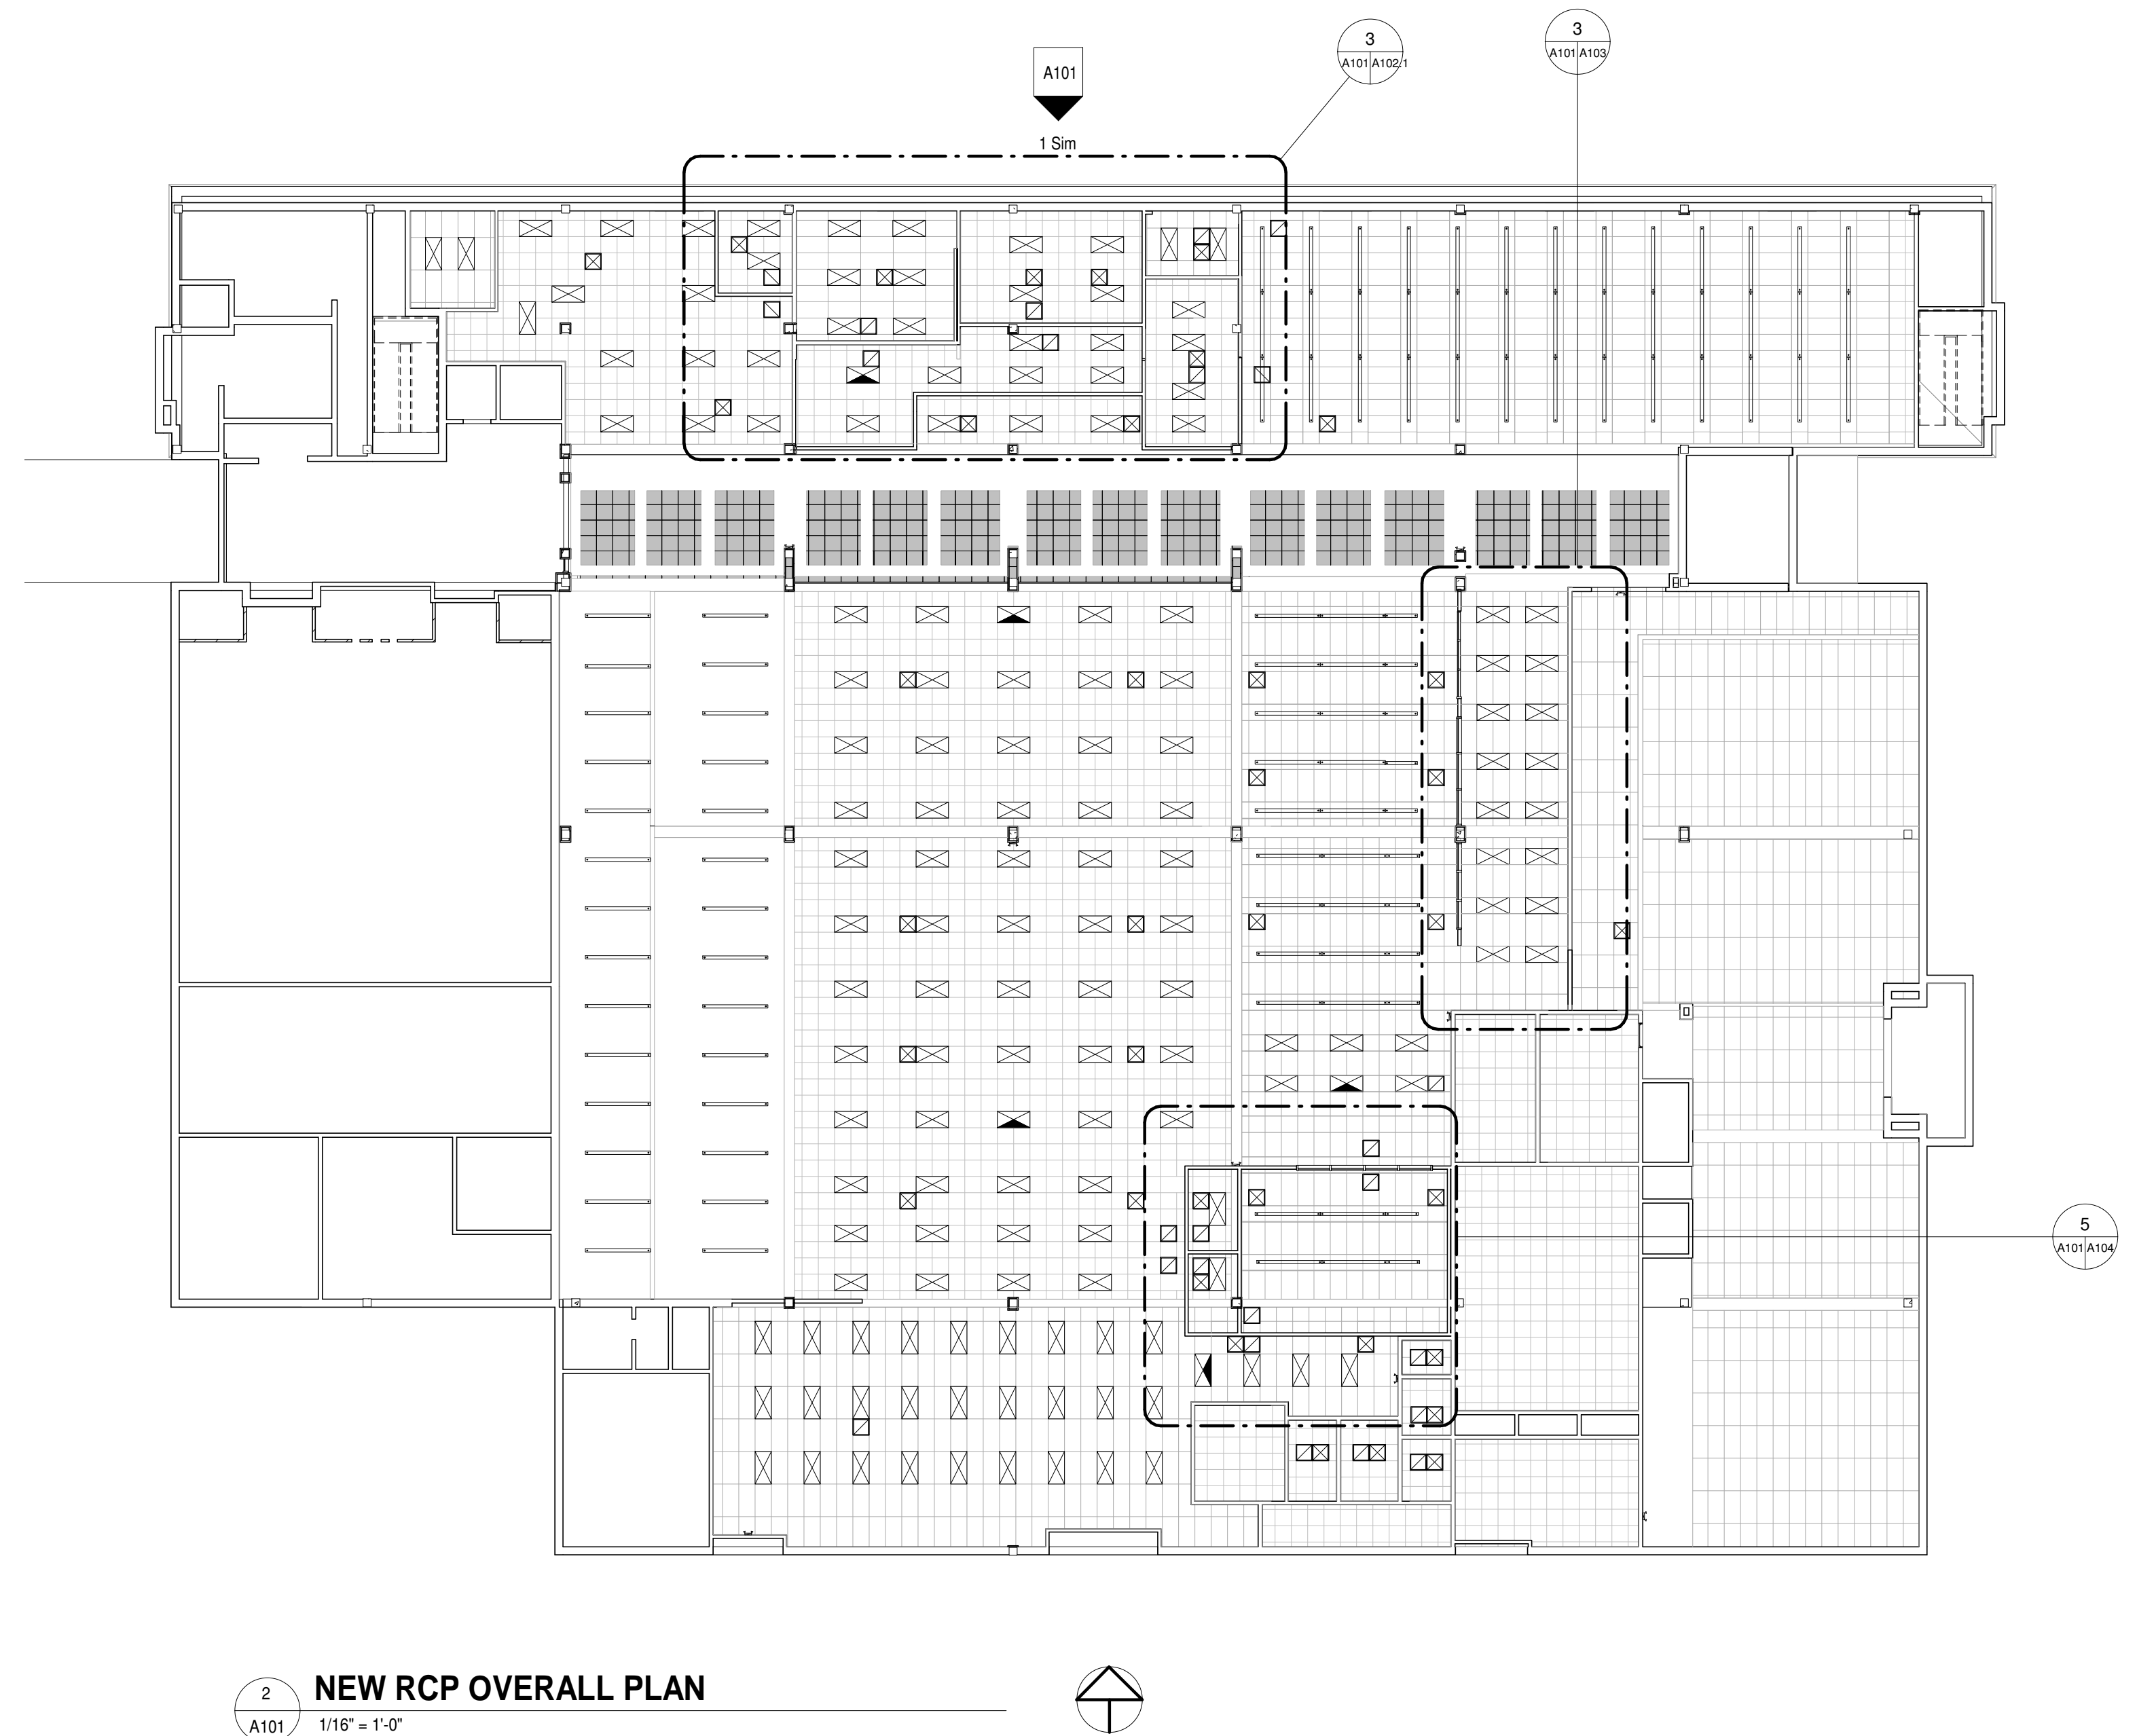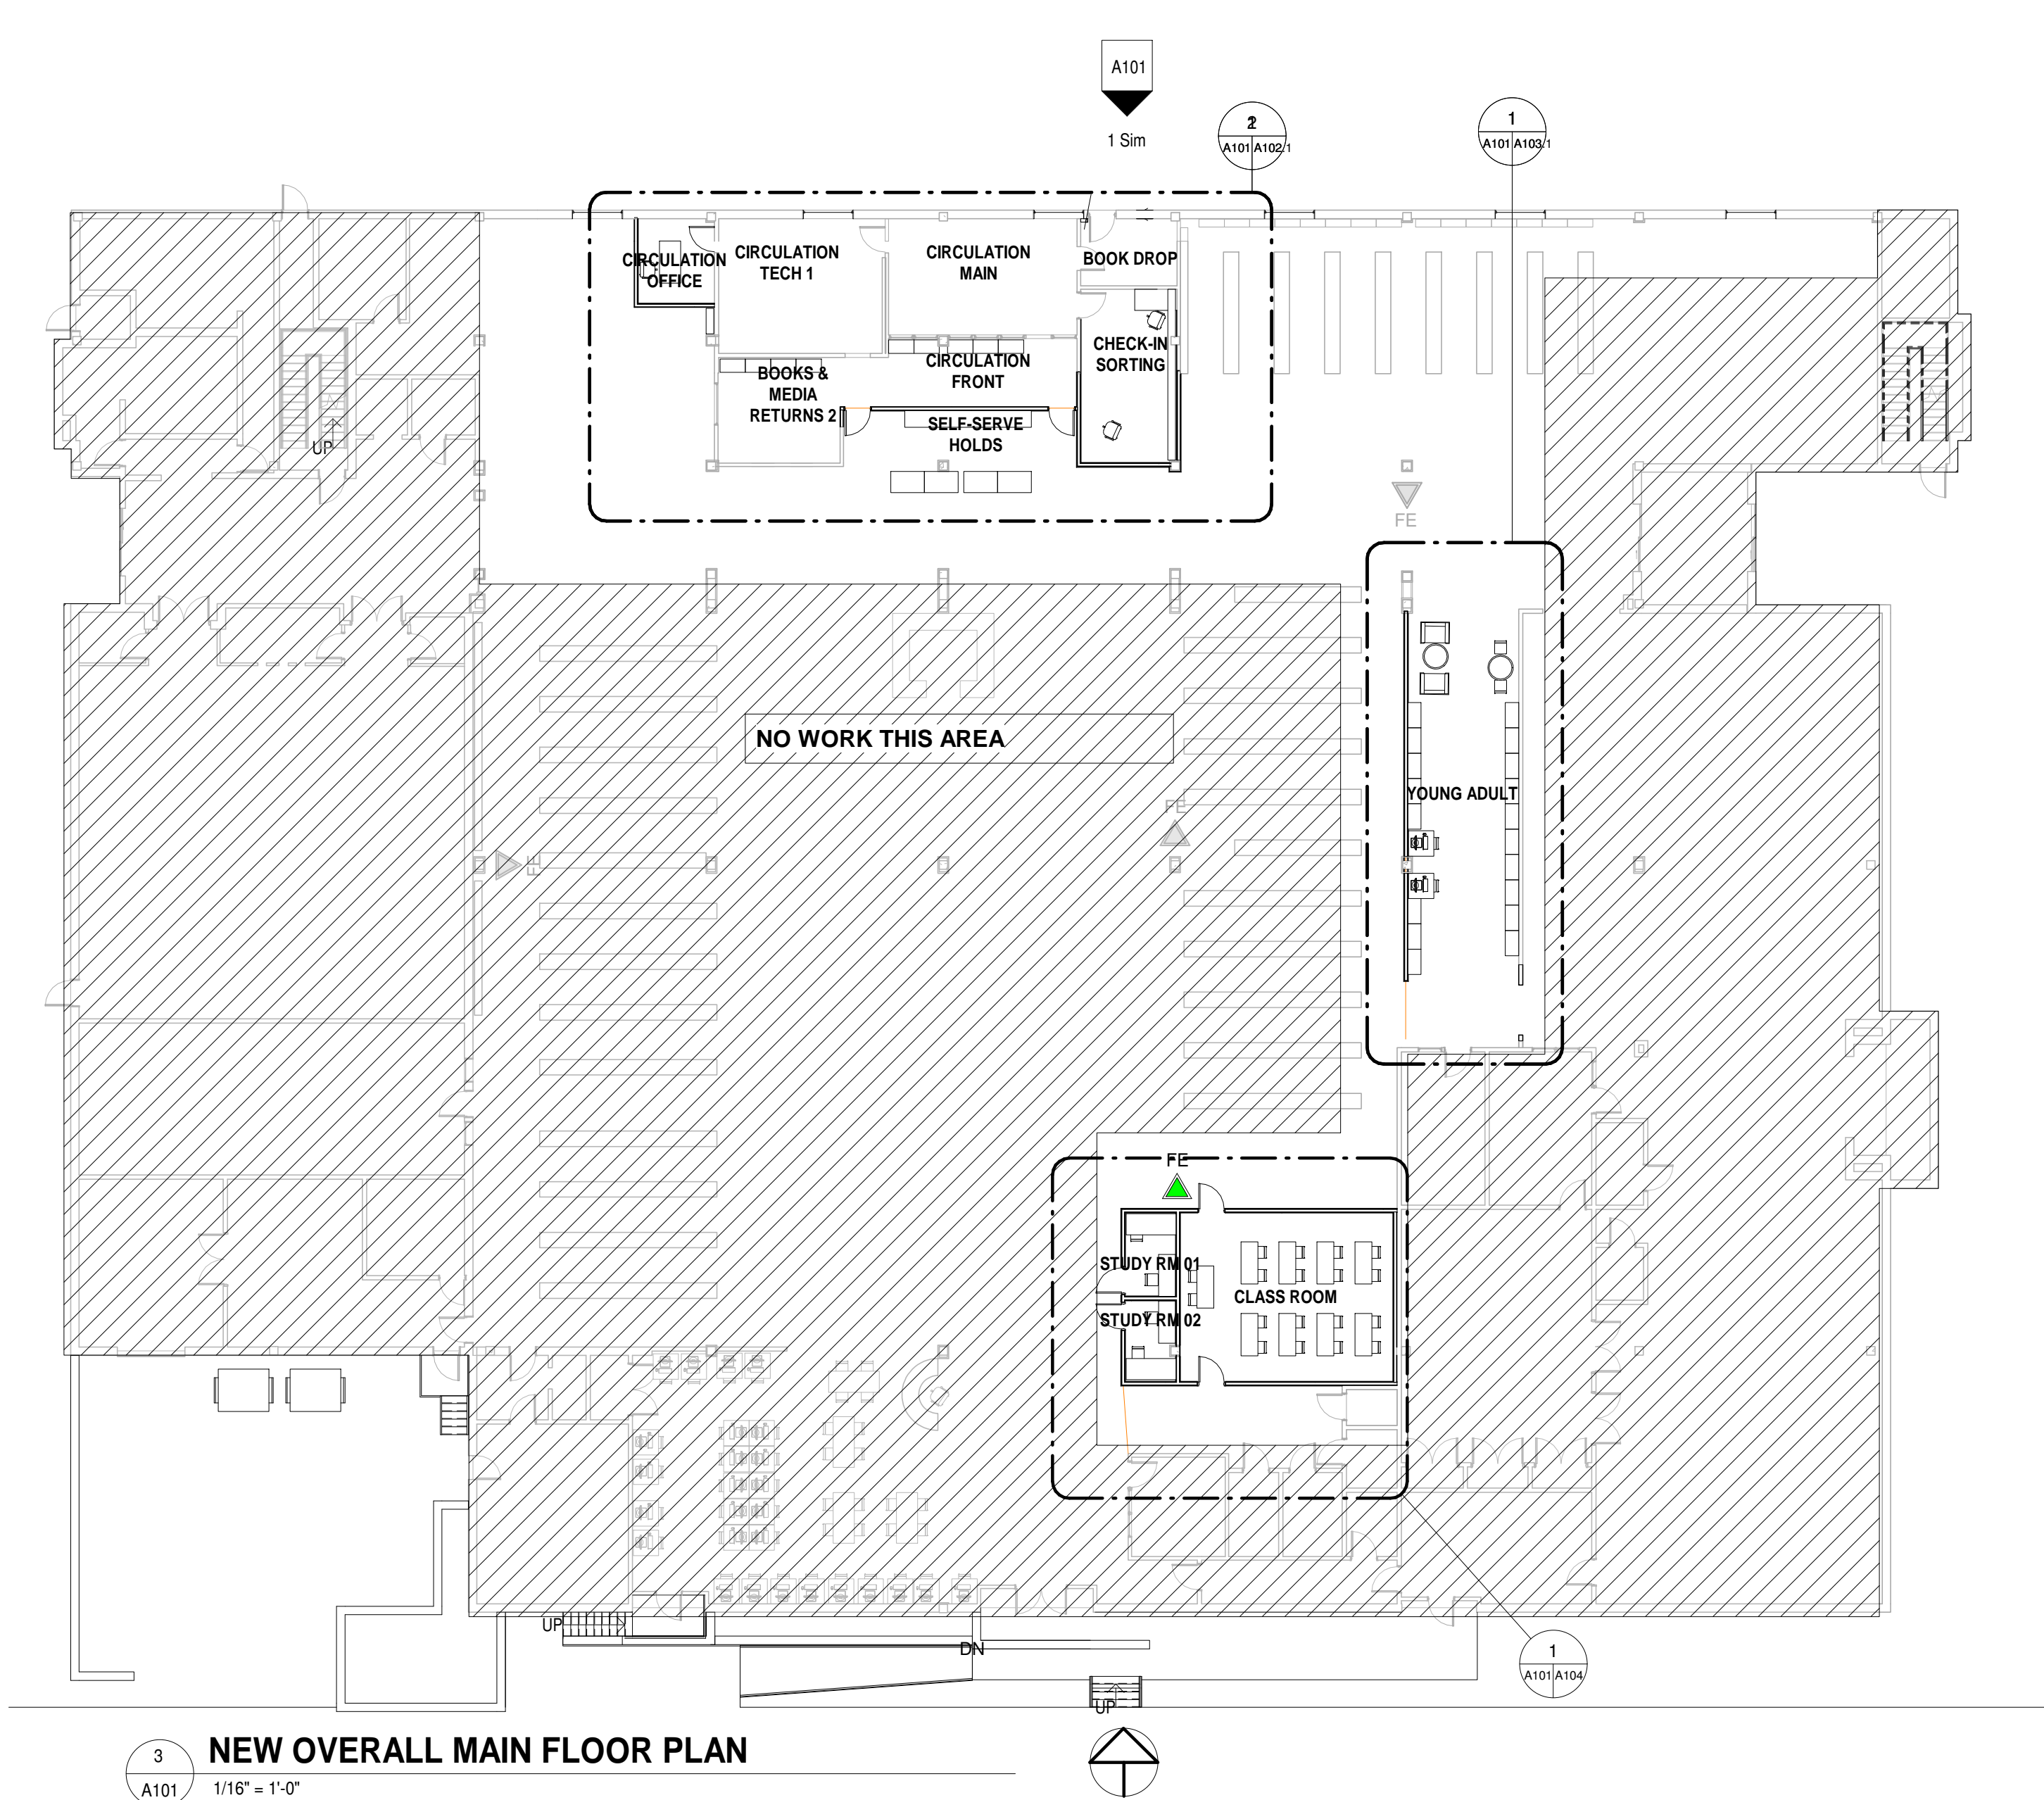

| REVISION | REVISION DATE | ISSUED FOR |
|----------|---------------|------------|
| | | |
| | | |

THE TAMARA PEACOCK COMPANY
Architects

104 1st Ave E. Hendersonville, NC 28792
 Phone: 828.696.4000 Fax: 954.728.9225

PROJECT NAME:
Henderson Co. Public Library
 301 N. WASHINGTON ST.
 HENDERSONVILLE, NC 28792

SHEET NAME:
NEW OVERALL FLOOR PLAN

PROJ. NO.: 1804 DATE: 8/3/2018
 SHEET NO.: 1 OF 35 2:46-35 PM

A101

1. THE CONTRACTOR SHALL ACQUAINT THEMSELVES WITH THE EXISTING STRUCTURE PRIOR TO CONSTRUCTION.
2. ANY CONDITIONS NOT SHOWN ON DRAWINGS SHALL BE BROUGHT TO THE IMMEDIATE ATTENTION OF ARCHITECT PRIOR TO CONSTRUCTION.
3. WRITTEN DIMENSIONS TAKE PRECEDENCE OVER SCALED DIMENSIONS.
4. THE CONTRACTOR SHALL FIELD VERIFY ALL DIMENSIONS AND REPORT DISCREPANCIES TO THIS OFFICE PRIOR TO CONSTRUCTION.
5. ALL WORKMANSHIP SHALL BE NEAT, CLEAN, TRUE AND CORRECT.
6. THE CONTRACTOR SHALL PROVIDE THE NECESSARY TEMPORARY CLOSING OF ALL NEW OPENINGS IN WALLS, ROOFS OR FLOORS AT THE END OF EACH DAY'S WORK TO KEEP THE BUILDING WEATHER TIGHT AND SECURE.
7. ARCHITECT SHALL NOT BE RESPONSIBLE OR LIABLE FOR THE INTEGRITY OR CORRECTNESS OF THE EXISTING BUILDING AND ITS COMPONENTS.
8. THE CONTRACTOR SHALL PROVIDE PROPER SHORING OF ALL STRUCTURAL MEMBERS THAT WILL REMAIN, PRIOR TO THE REMOVAL OF EXISTING SUPPORTS. THE CONTRACTOR SHALL PATCH, REPAIR OR REPLACE EXISTING WORK DAMAGED BY NEW CONSTRUCTION.
9. THE CONTRACTOR SHALL VERIFY ROUGH OPENING SIZES OF DOORS AND WINDOWS PRIOR TO CONSTRUCTION.
10. THE CONTRACTOR SHALL PROVIDE ADEQUATE PROTECTION TO ALL EXISTING WORK, FURNISHINGS AND FIXTURES/APPLIANCES THAT ARE TO BE RETAINED, SO THAT THEY WILL NOT BE DAMAGED.
11. EXISTING CEILINGS MUST BE PROPERLY SHORED PRIOR TO REMOVAL OF ANY EXISTING BEARING POINTS, POSTS OR COLUMNS.


GENERAL DEMOLITION NOTES

| | |
|--|--|
| | EXISTING COLUMN WITH GWB ENCLOSURE |
| | EXISTING 12 INCH WALL |
| | EXISTING EXTERNAL BRICK WITH 2X4 MTL STUD WALL |
| | EXISTING WALL 2X4 MTL STUD WALL |
| | NEW WALL 2X4 MTL STUD WALL |
| | AREA OF A.C.T. BEING REMOVED FOR WALL |

WALL LEGEND


SCOPE OF WORK CIRCULATION:

1. Demolish walls as shown (storage of existing A.C.T., Books, Shelves, Furniture, Lights, Switches, etc to be coordinated).
2. Add Office, retrofitting HVAC duct, and lights to new office space (storage of existing A.C.T., Books, Shelves, Furniture, Lights, Switches, etc to be coordinated).
4. Install (6) new windows on the North Elevation.

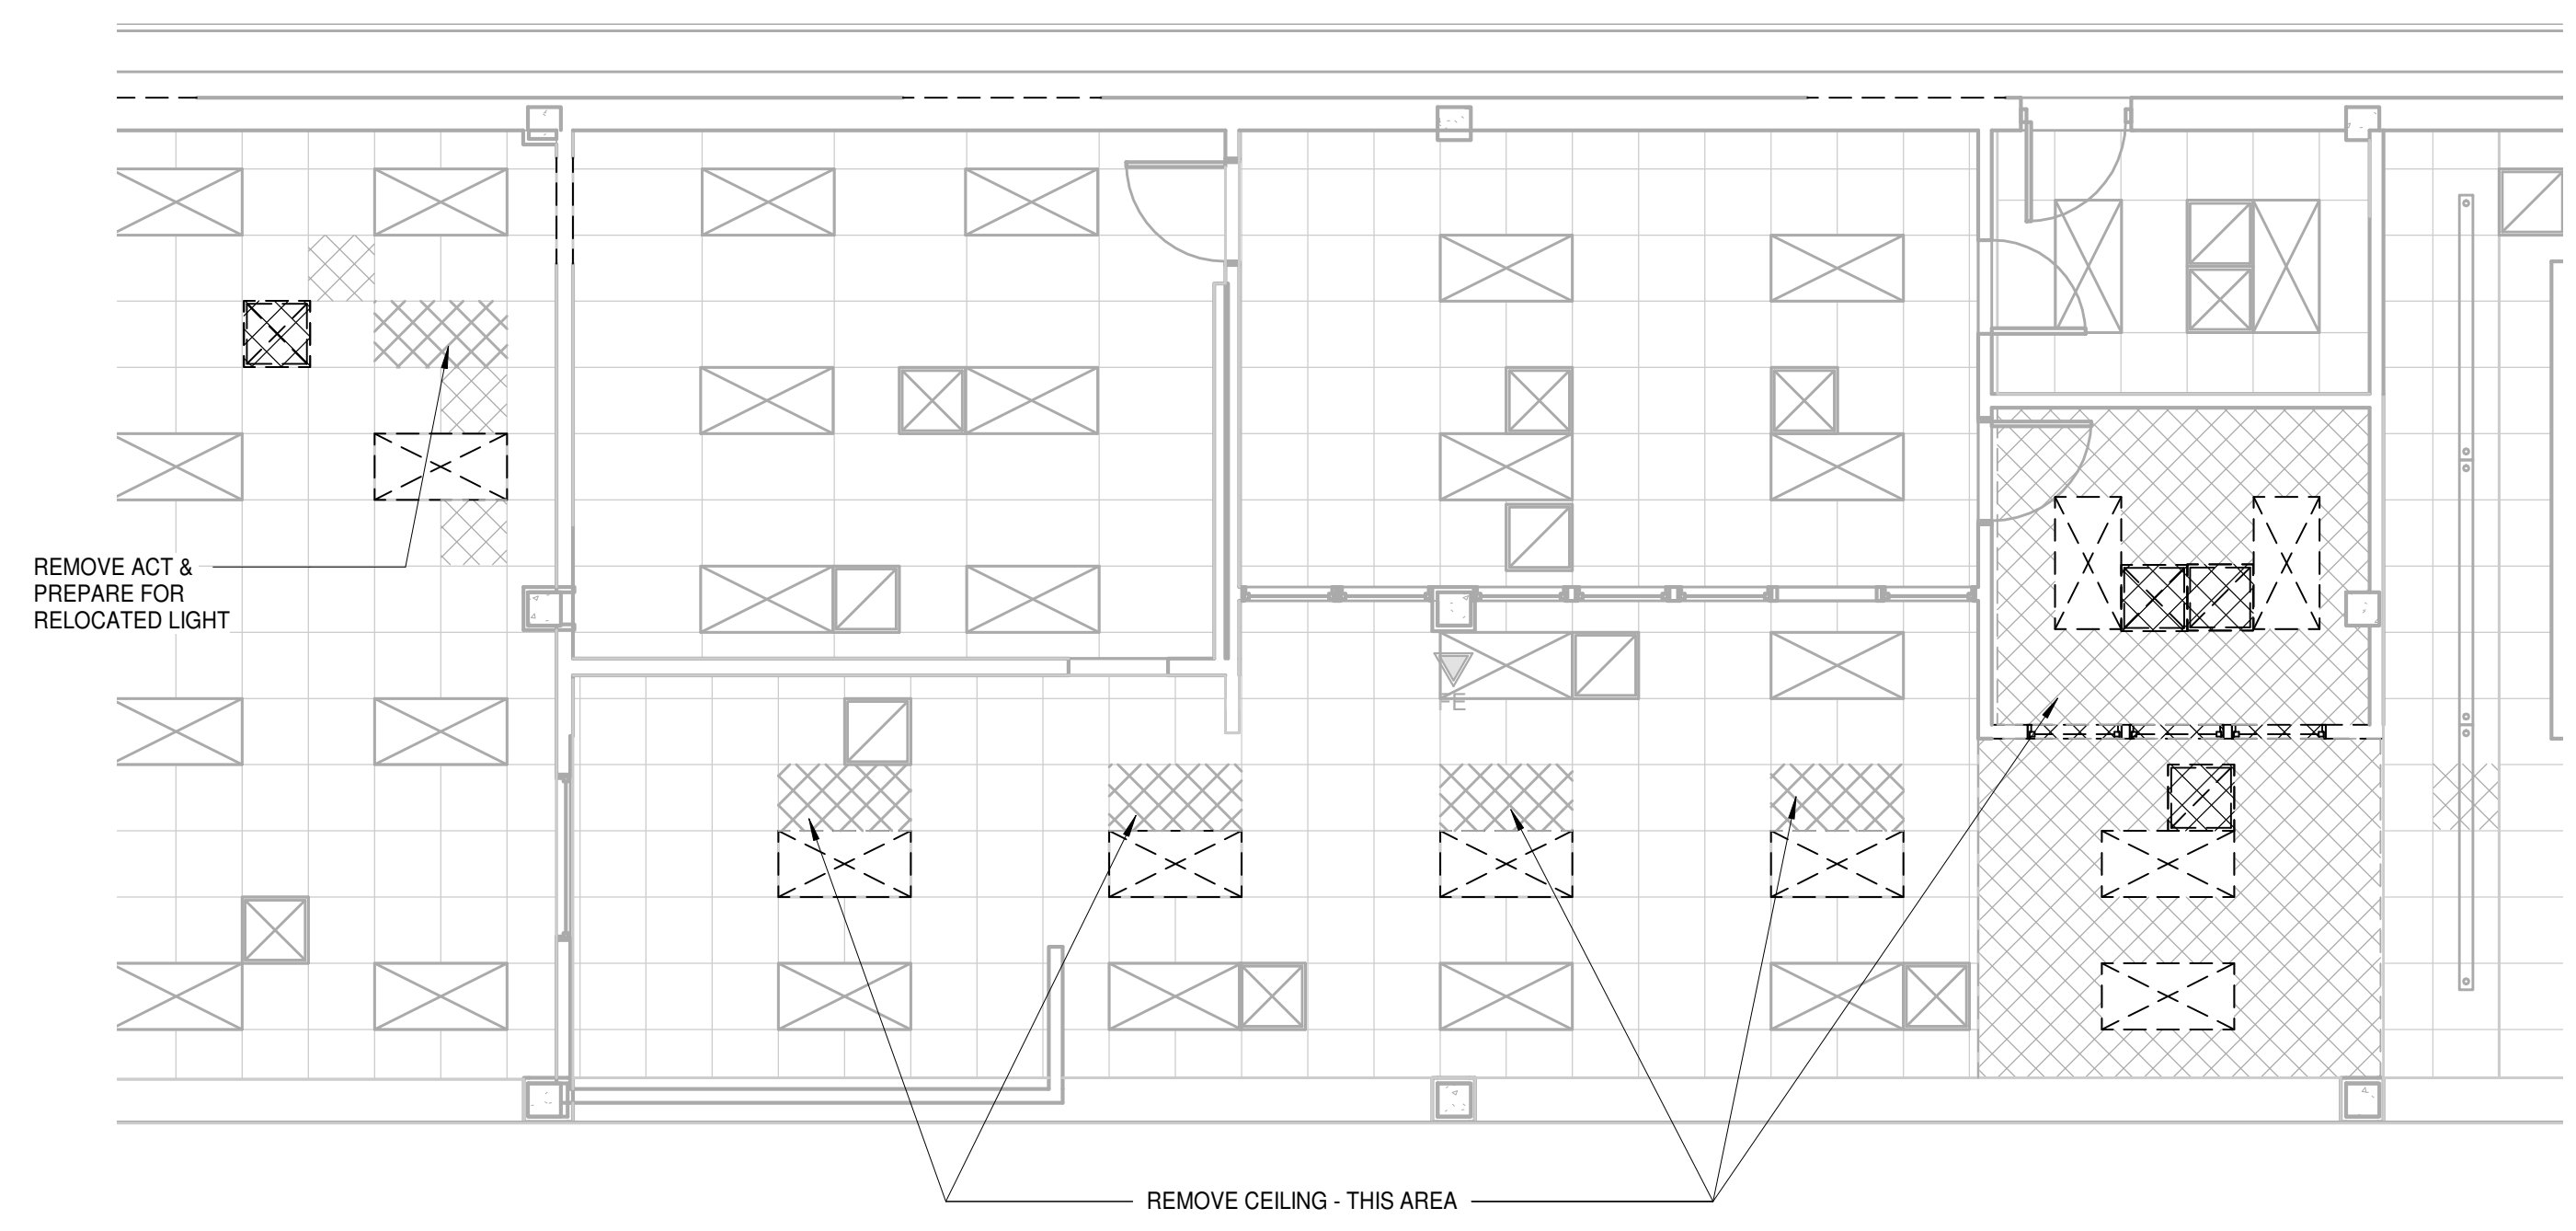


NOTE: SAVE LIGHTS FOR REUSE.

2 DEMO CIRCULATION RCP
3/16" = 1'-0"

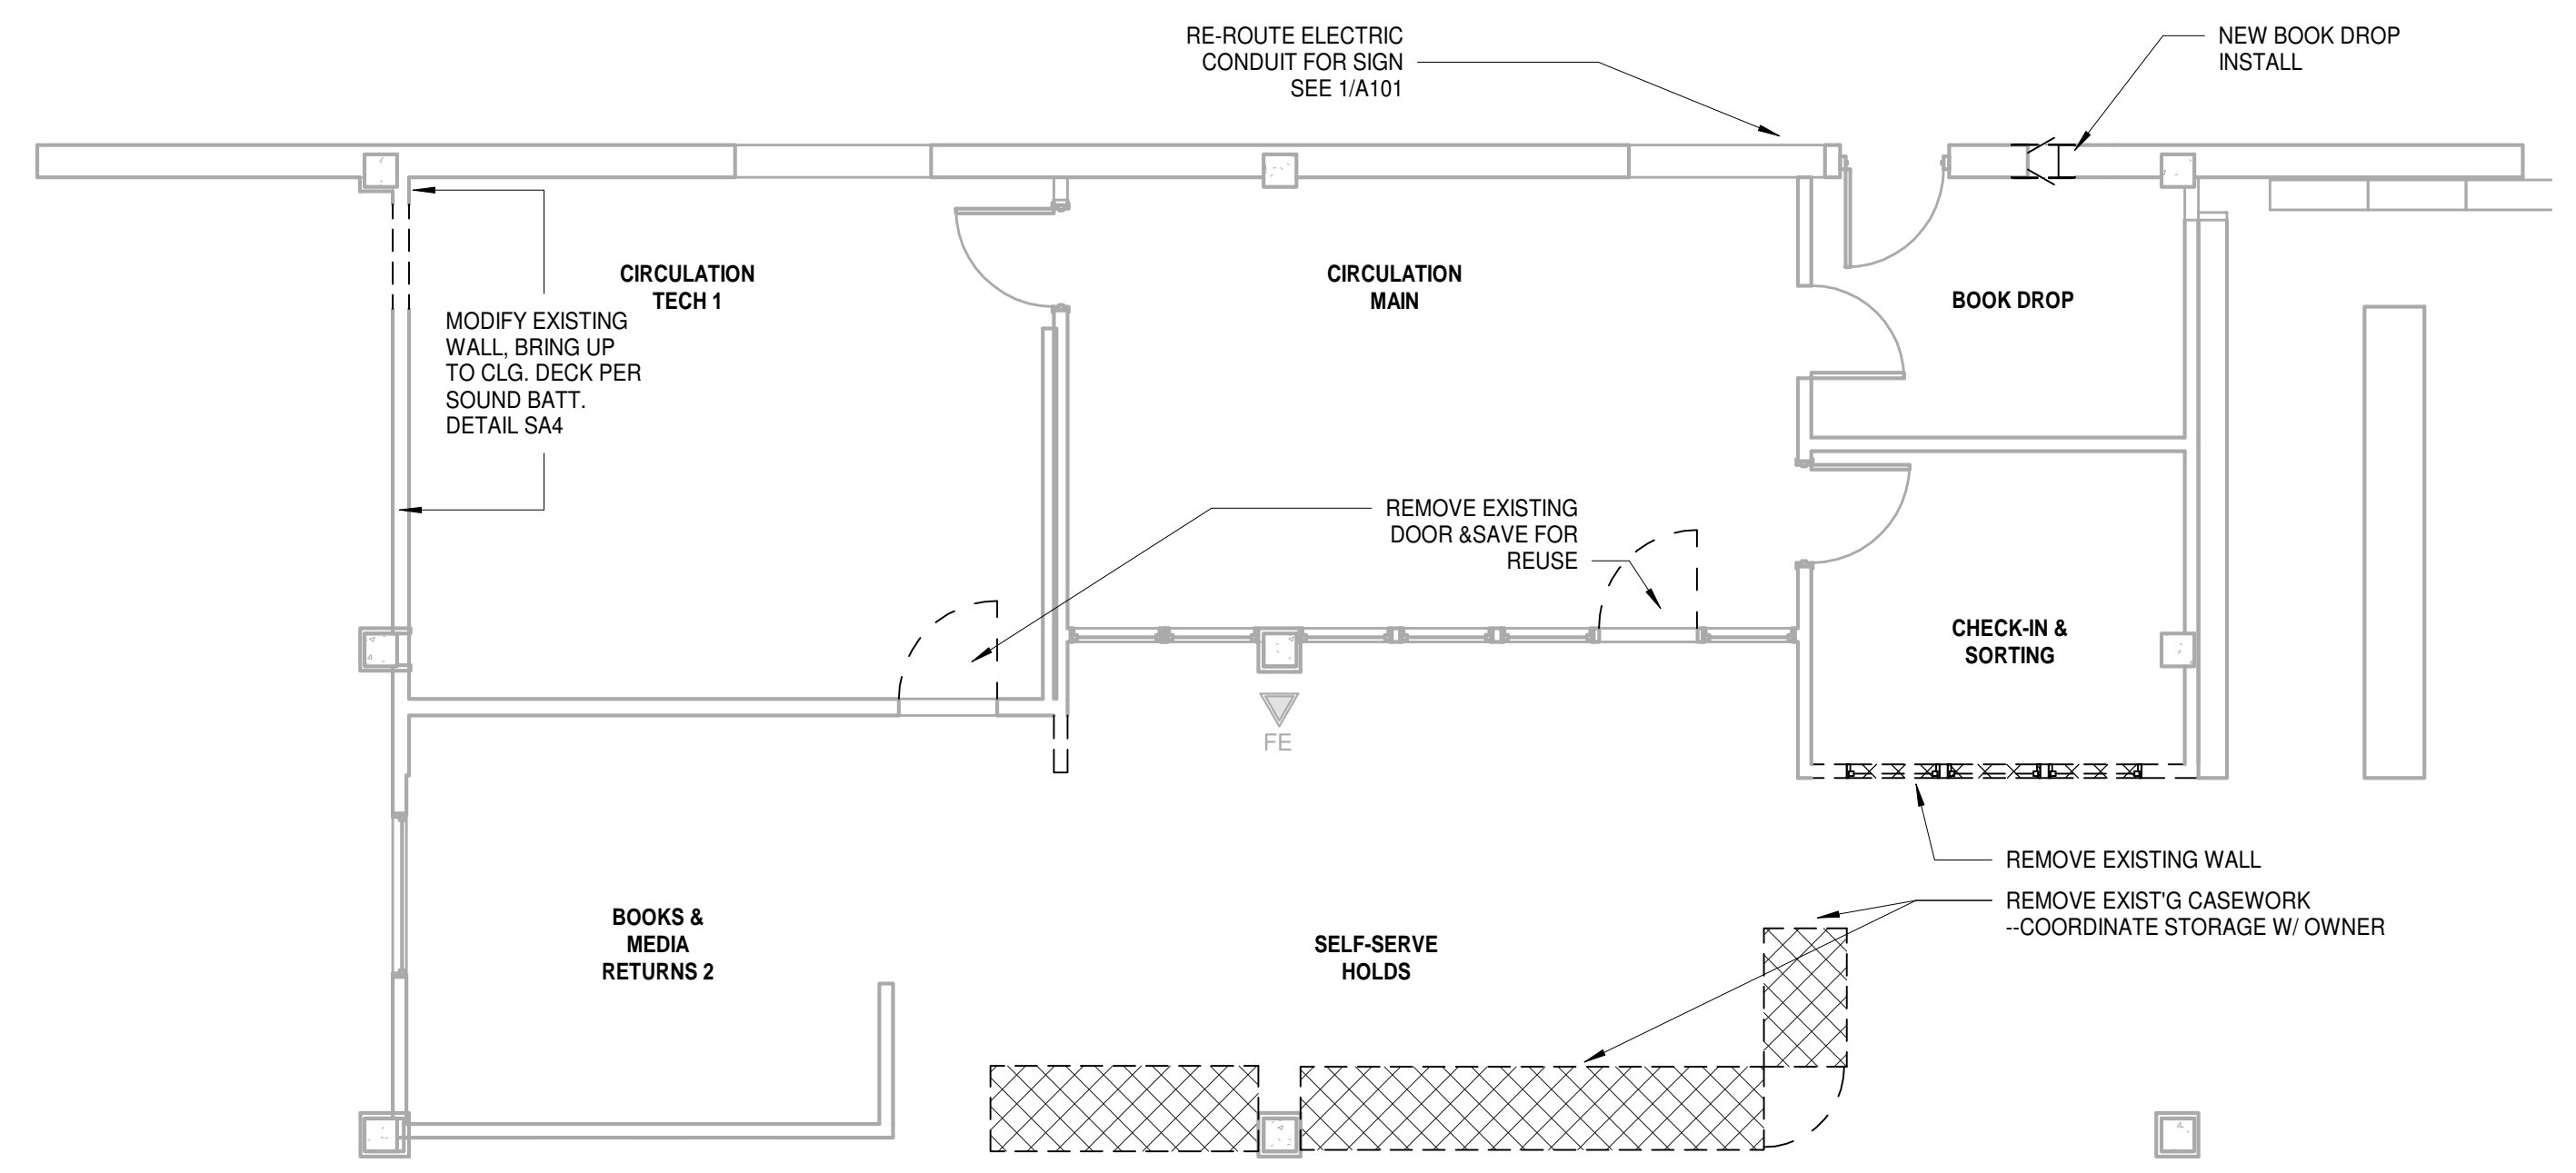

1 DEMO PLAN CIRCULATION AREA
3/16" = 1'-0"

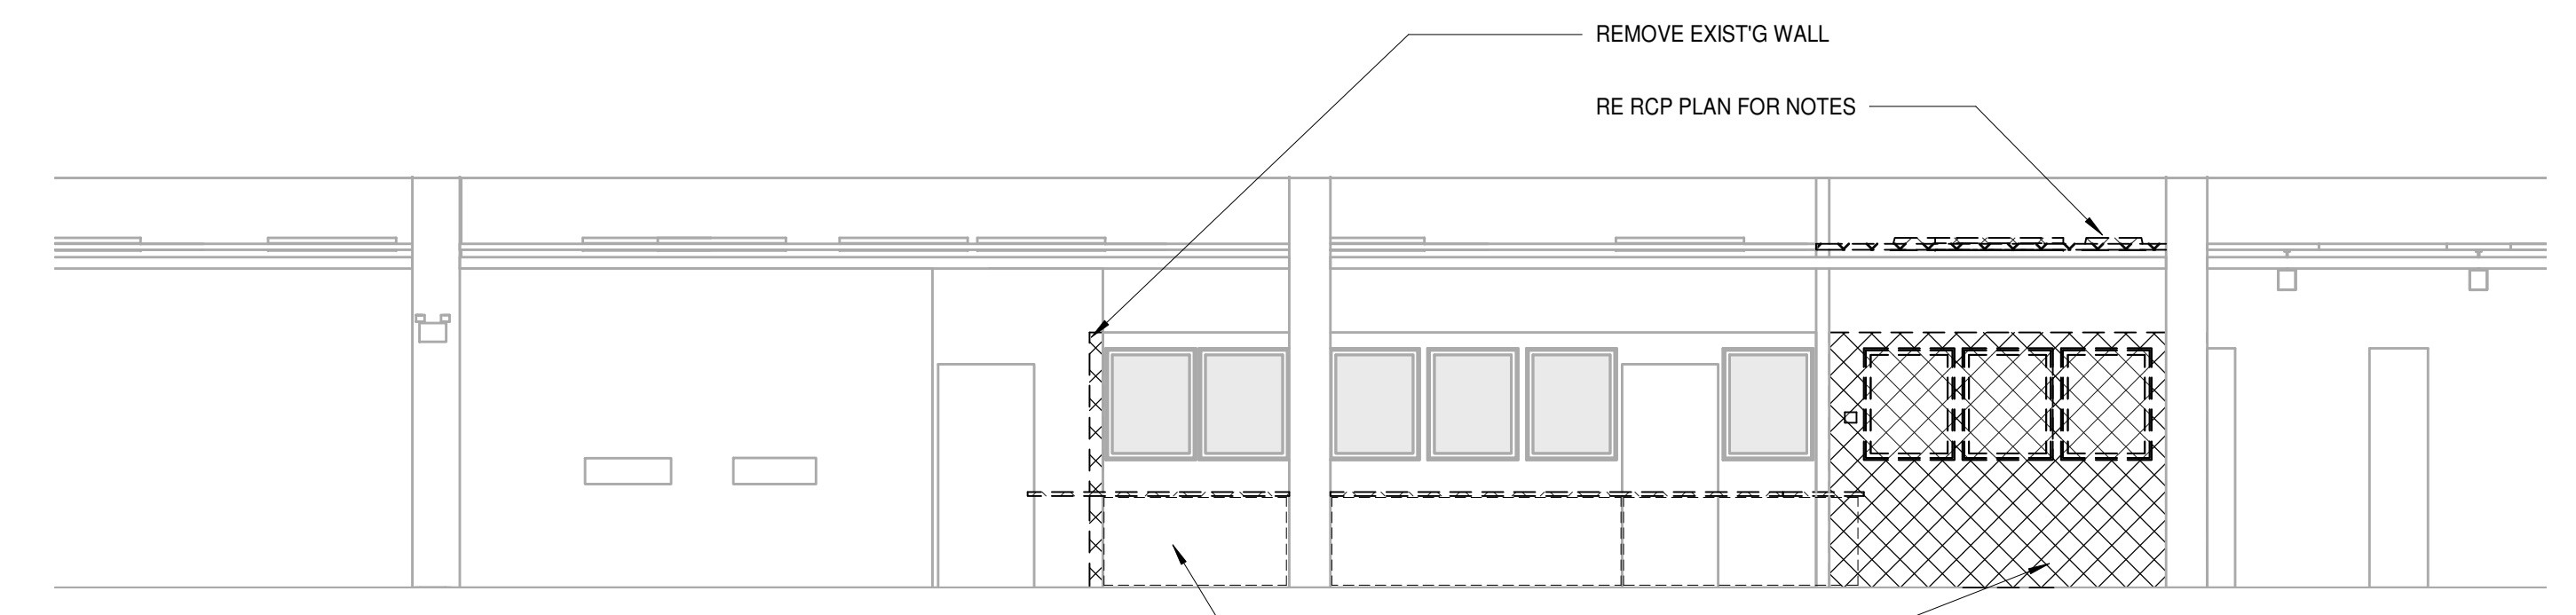

3 DEMO ELEVATION AT CIRCULATION AREA
3/16" = 1'-0"

TAMARA PEACOCK, R.A.
LICENSE NO. 12126

PROJ. DESIGNER CAPT. APPROVER
DRAWN BY: AUTHOR
REVISED BY: CHECKER

| | |
|---------------|--|
| ISSUED FOR | |
| REVISION | |
| REVISION DATE | |

THE TAMARA PEACOCK COMPANY
Architects

104 1st Ave E. Hendersonville, NC 28792
Phone: 828.696.4000 Fax: 954.728.9225

PROJECT NAME:
Henderson Co. Public Library
301 N. WASHINGTON ST.
HENDERSONVILLE, NC 28792

SHEET NAME:
CIRCULATION AREA DEMO


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DATE: 8/3/2018
SHEET NO.: 24-6-36
SHEET NO.: PM

A102


BID SET
7-2018

| | |
|--|--|
| | EXISTING COLUMN WITH GWB ENCLOSURE |
| | EXISTING 12 INCH WALL |
| | EXISTING EXTERNAL BRICK WITH 2X4 MTL STUD WALL |
| | EXISTING WALL 2X4 MTL STUD WALL |
| | NEW WALL 2X4 MTL STUD WALL |
| | AREA OF A.C.T. BEING REMOVED FOR WALL |


WALL LEGEND

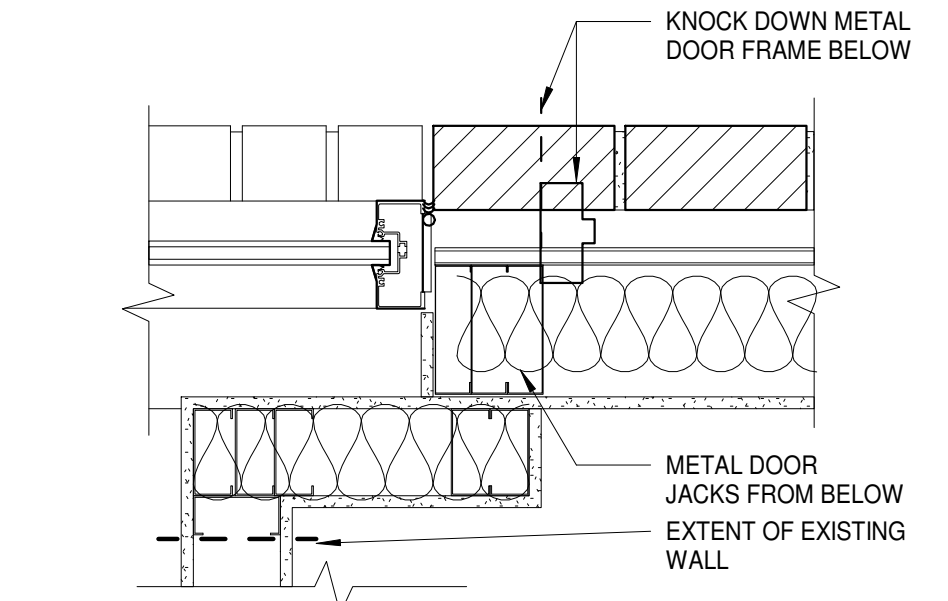


7 WALL @ NEW WINDOW
A102.1 1 1/2" = 1'-0"

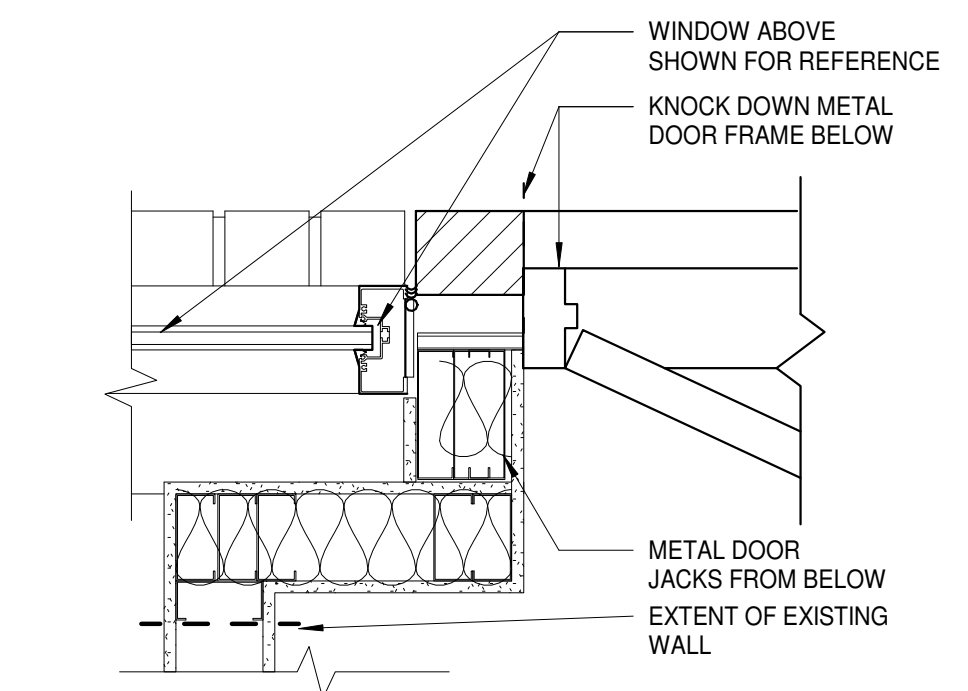


8 WALL @ NEW WINDOW BOOK DROP
A102.1 1 1/2" = 1'-0"

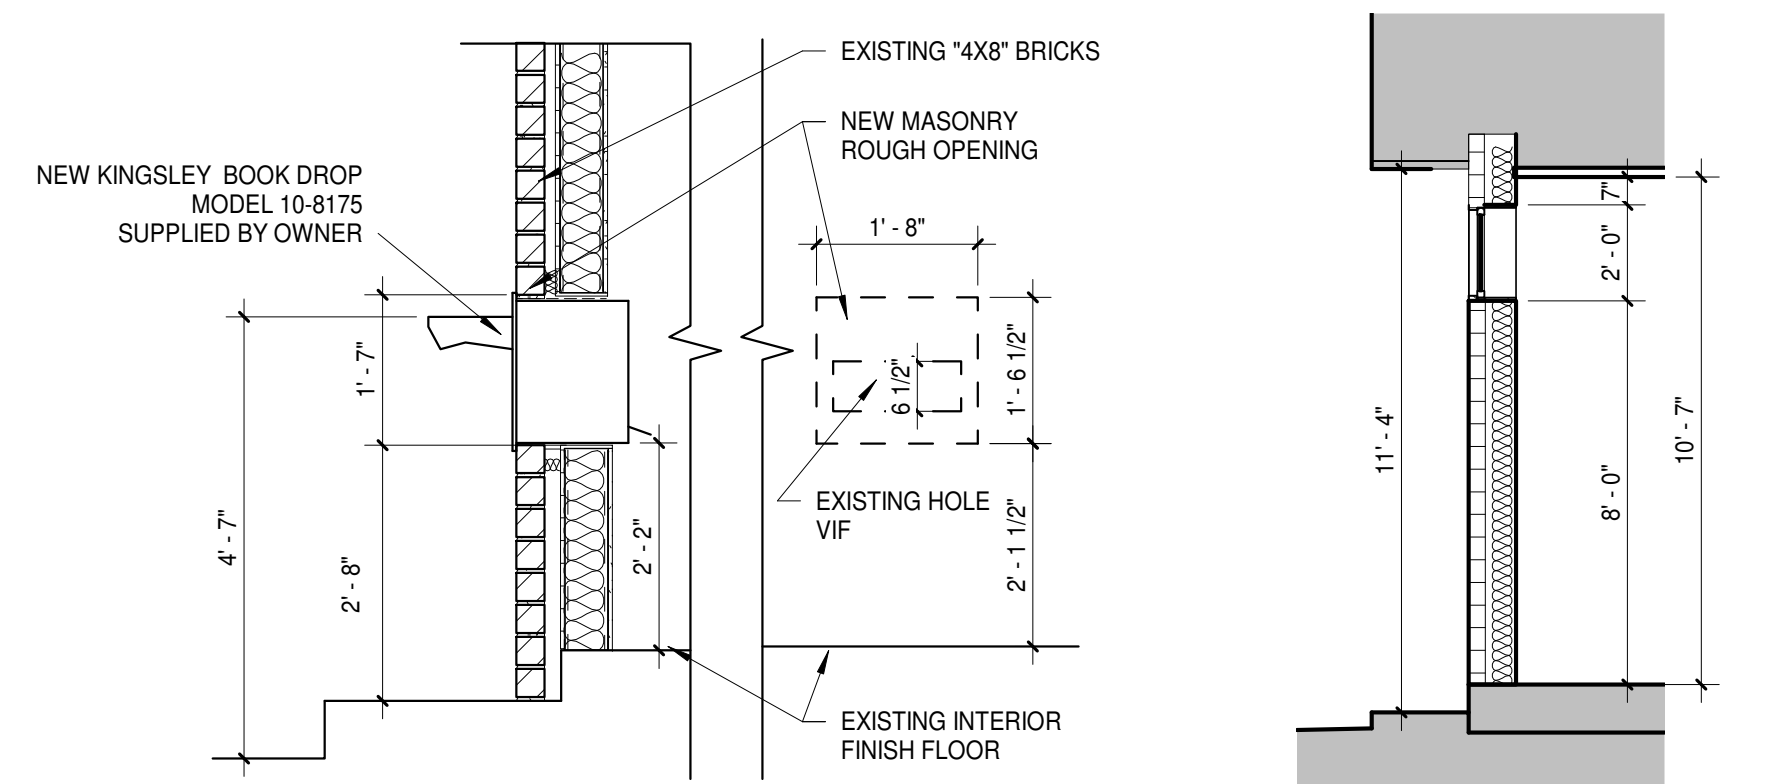


6 DROP BOX
A102.1 1/2" = 1'-0"

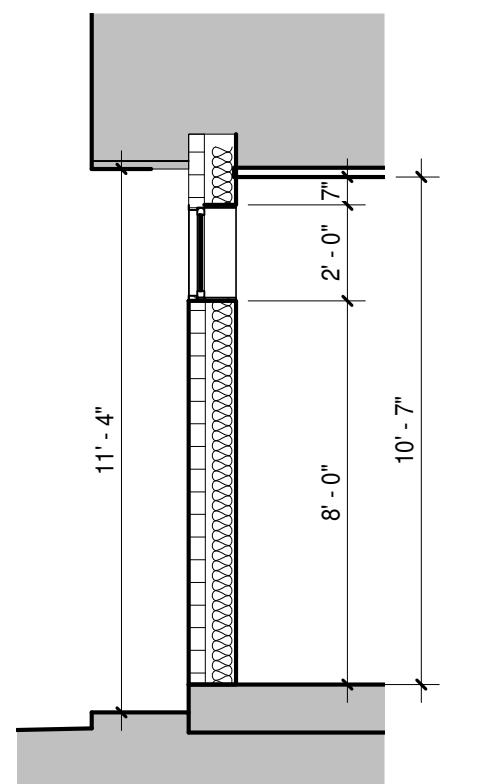


5 CIRCULATION SECTION
A102.1 1/4" = 1'-0"

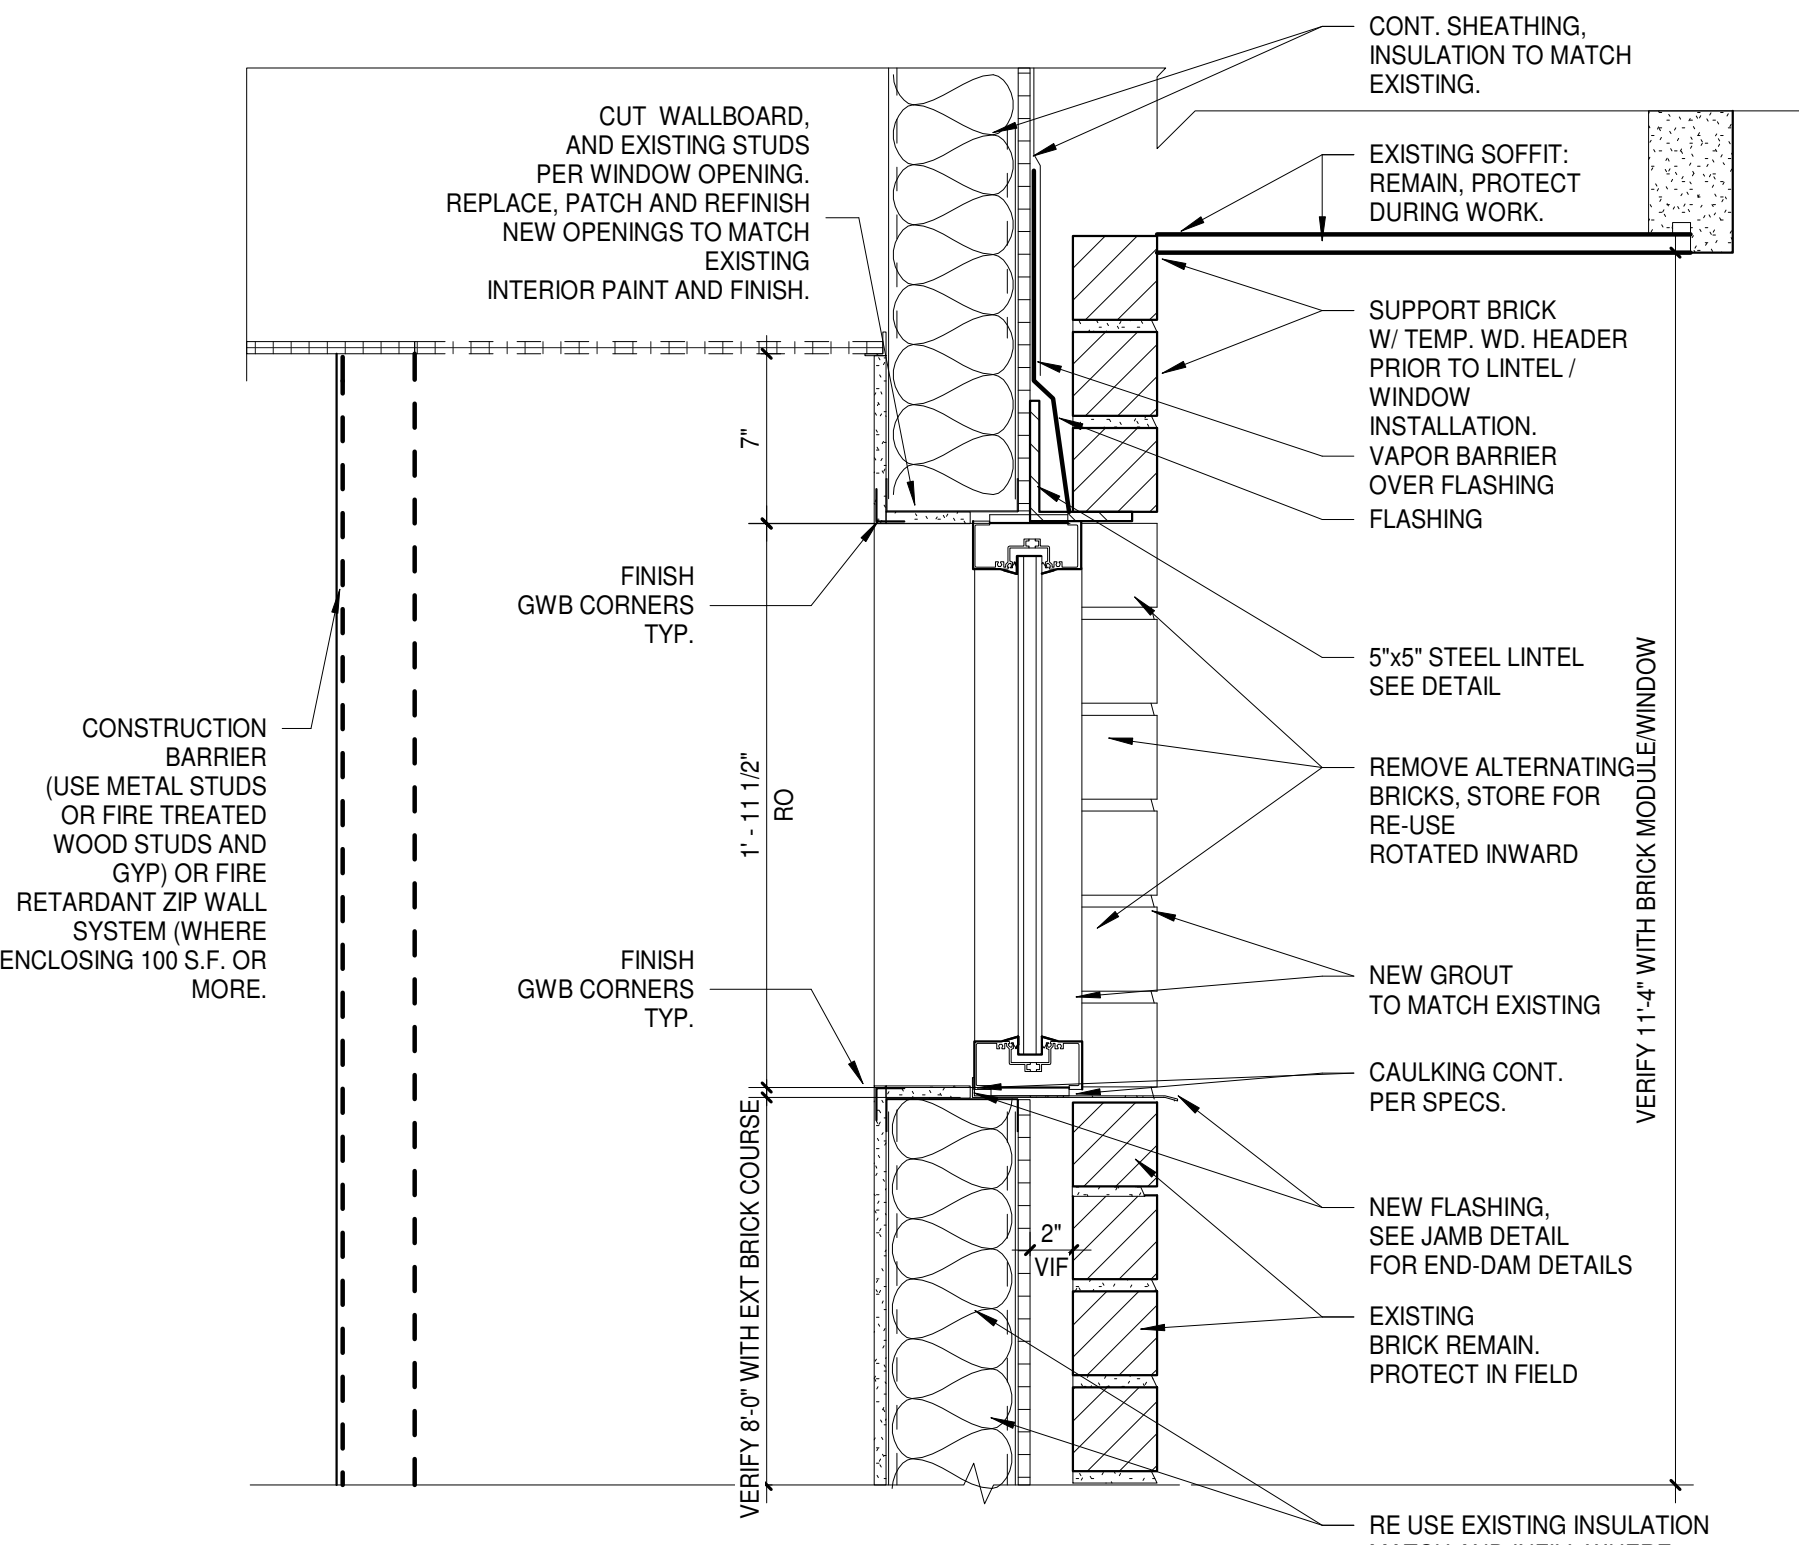


4 NEW EXTERIOR WINDOWS DETAIL
A102.1 1 1/2" = 1'-0"

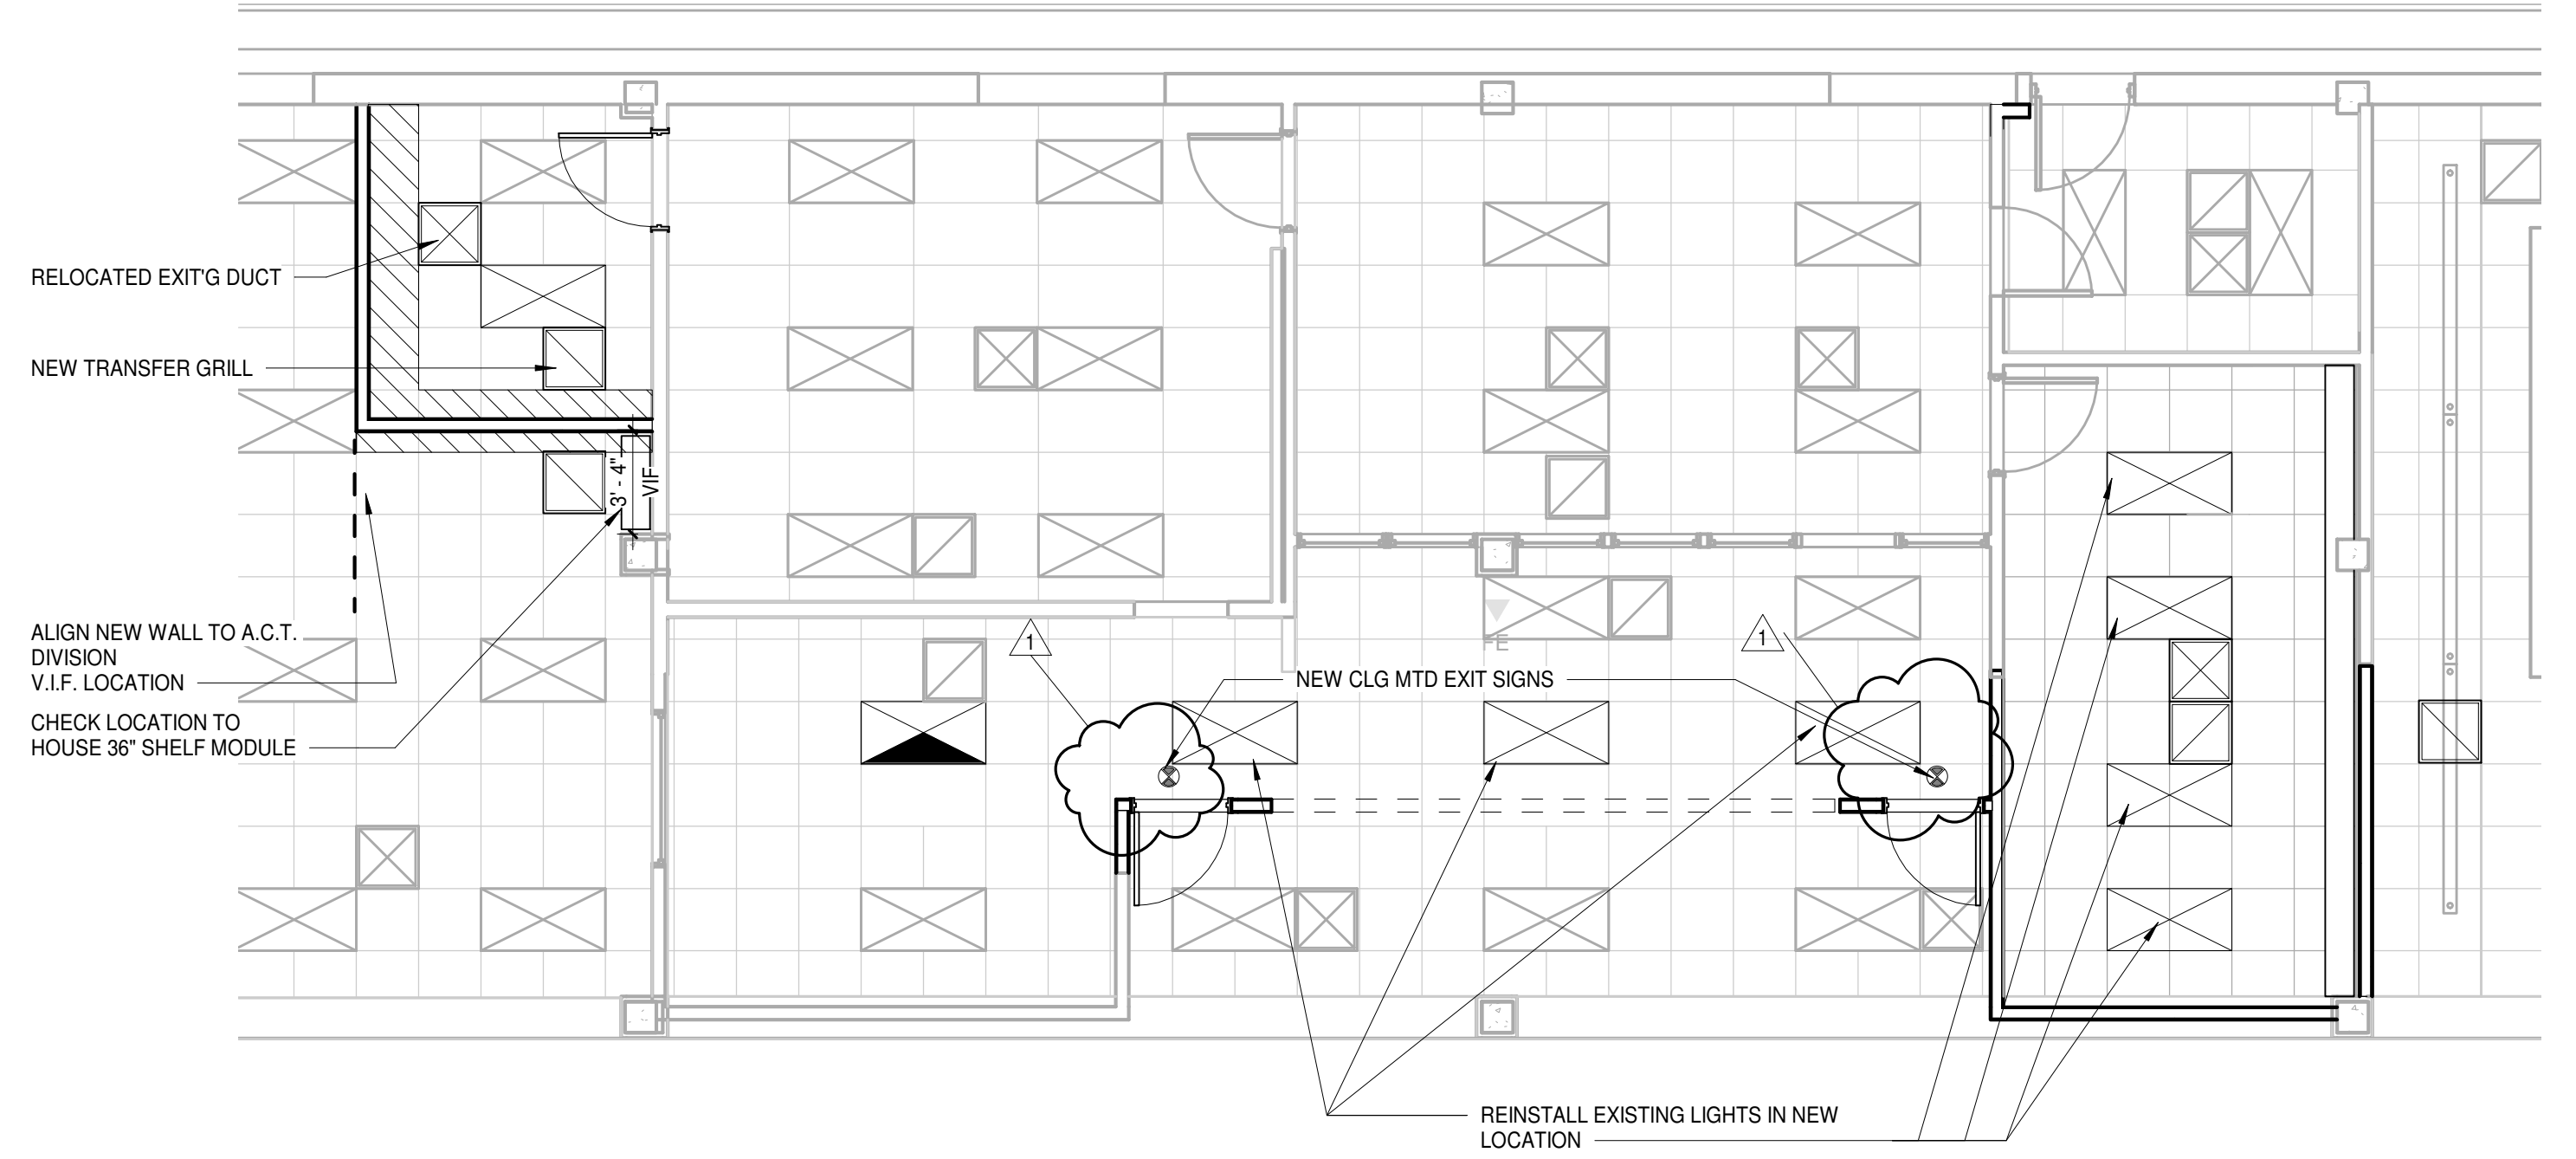

3 NEW CIRCULATION RCP
A102.1 3/16" = 1'-0"

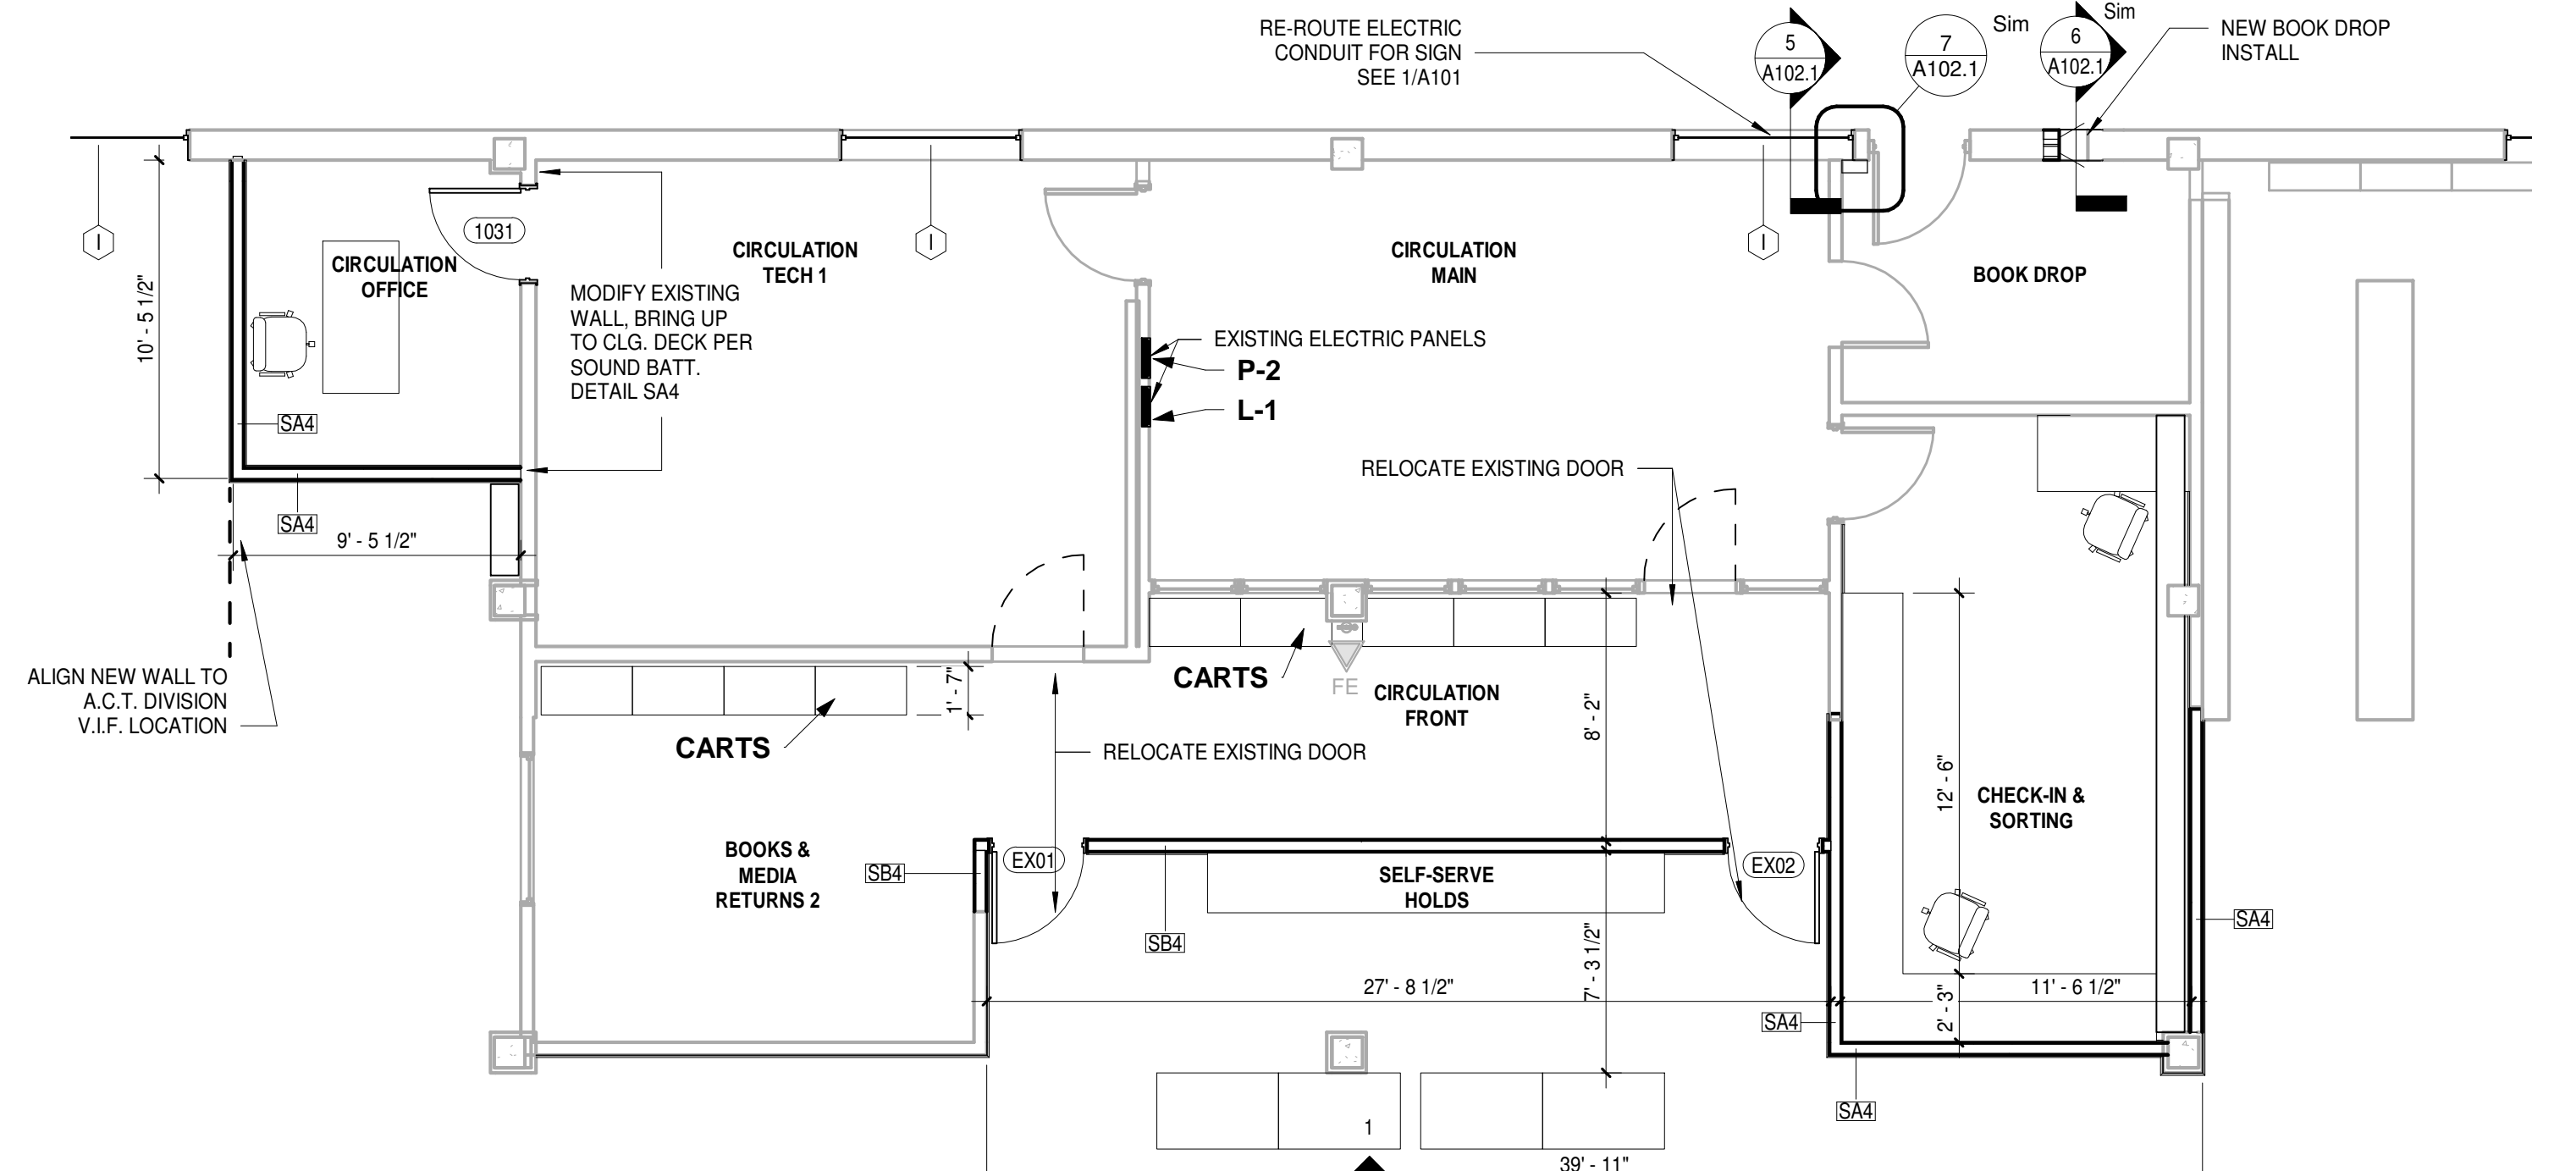

2 NEW CIRCULATION AREA PLAN
A102.1 3/16" = 1'-0"

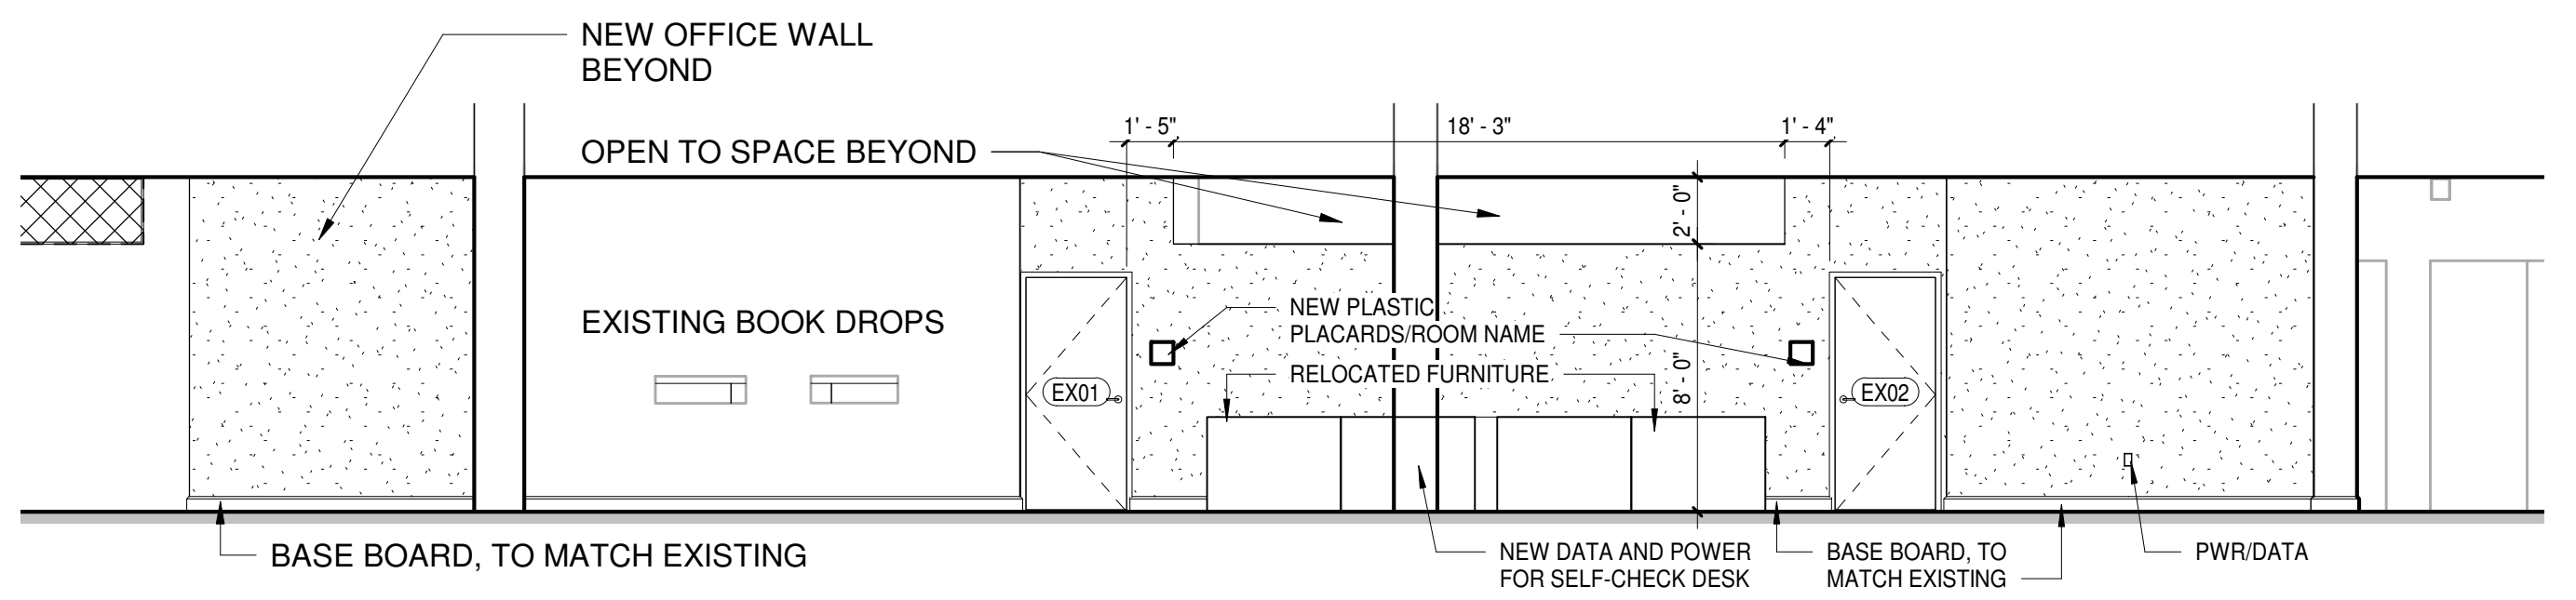

1 ELEVATION CIRCULATION AREAS
A102.1 3/16" = 1'-0"

TAMARA PEACOCK, R.A.
LICENSE NO. 12126

| | |
|----------------|---------------|
| PROJ. DESIGNER | DRAWN BY |
| CAPT. APPROVER | REVISOR BY |
| ISSUED FOR | CHECKER |
| REVISION | REVISION DATE |
| | 7/17/2018 |
| | DW |

THE TAMARA PEACOCK COMPANY
Architects

104 1st Ave E. Hendersonville, NC 28792
Phone: 828.696.4000 Fax: 954.728.9225

PROJECT NAME:
Henderson Co. Public Library
301 N. WASHINGTON ST.
HENDERSONVILLE, NC 28792

SHEET NAME:
CIRCULATION AREA NEW WORK

PROJ. No. 1804 DATE: 8/3/2018
2:46:36 PM
SHEET No. 1

A102.1

BID SET
7-2018

1. THE CONTRACTOR SHALL ACQUAINT THEMSELVES WITH THE EXISTING STRUCTURE PRIOR TO CONSTRUCTION.
2. ANY CONDITIONS NOT SHOWN ON DRAWINGS SHALL BE BROUGHT TO THE IMMEDIATE ATTENTION OF ARCHITECT PRIOR TO CONSTRUCTION.
3. WRITTEN DIMENSIONS TAKE PRECEDENCE OVER SCALED DIMENSIONS.
4. THE CONTRACTOR SHALL FIELD VERIFY ALL DIMENSIONS AND REPORT DISCREPANCIES TO THIS OFFICE PRIOR TO CONSTRUCTION.
5. ALL WORKMANSHIP SHALL BE NEAT, CLEAN, TRUE AND CORRECT.
6. THE CONTRACTOR SHALL PROVIDE THE NECESSARY TEMPORARY CLOSING OF ALL NEW OPENINGS IN WALLS, ROOFS OR FLOORS AT THE END OF EACH DAYS WORK TO KEEP THE BUILDING WEATHER TIGHT AND SECURE.
7. ARCHITECT SHALL NOT BE RESPONSIBLE OR LIABLE FOR THE INTEGRITY OR CORRECTNESS OF THE EXISTING BUILDING AND ITS COMPONENTS.
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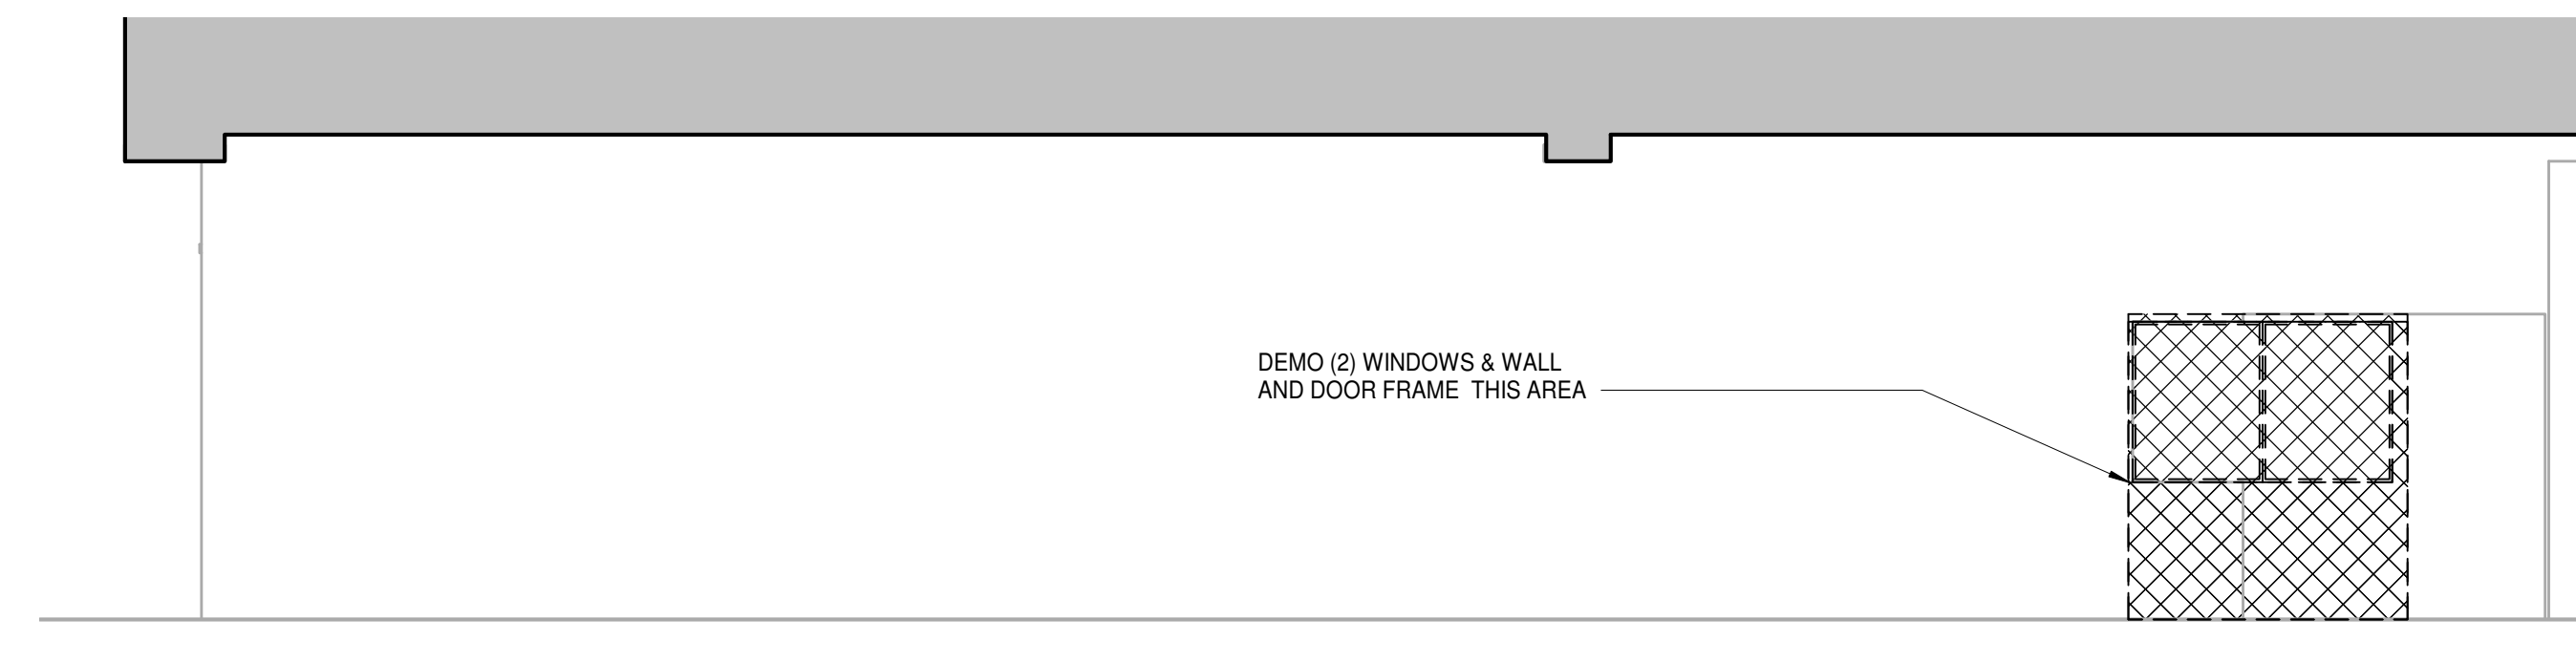
GENERAL DEMOLITION NOTES
6" = 1'-0"

| | |
|--|--|
| | EXISTING COLUMN WITH GWB ENCLOSURE |
| | EXISTING 12 INCH WALL |
| | EXISTING EXTERNAL BRICK WITH 2X4 MTL STUD WALL |
| | EXISTING WALL 2X4 MTL STUD WALL |
| | NEW WALL 2X4 MTL STUD WALL |
| | AREA OF A.C.T. BEING REMOVED FOR WALL |


WALL LEGEND

SCOPE OF WORK YOUNG ADULT AREA:

1. Demolish windows as shown (storage of existing A.C.T., Books, Shelves, Furniture, Lights, Switches, etc to be coordinated).
2. Add Wall and windows, retrofitting HVAC duct, and lights to new locations (storage of existing A.C.T., Books, Shelves, Furniture, Lights, Switches, etc to be coordinated).



2 DEMO ELEVATION YOUNG ADULT AREA
A103 1/4" = 1'-0"

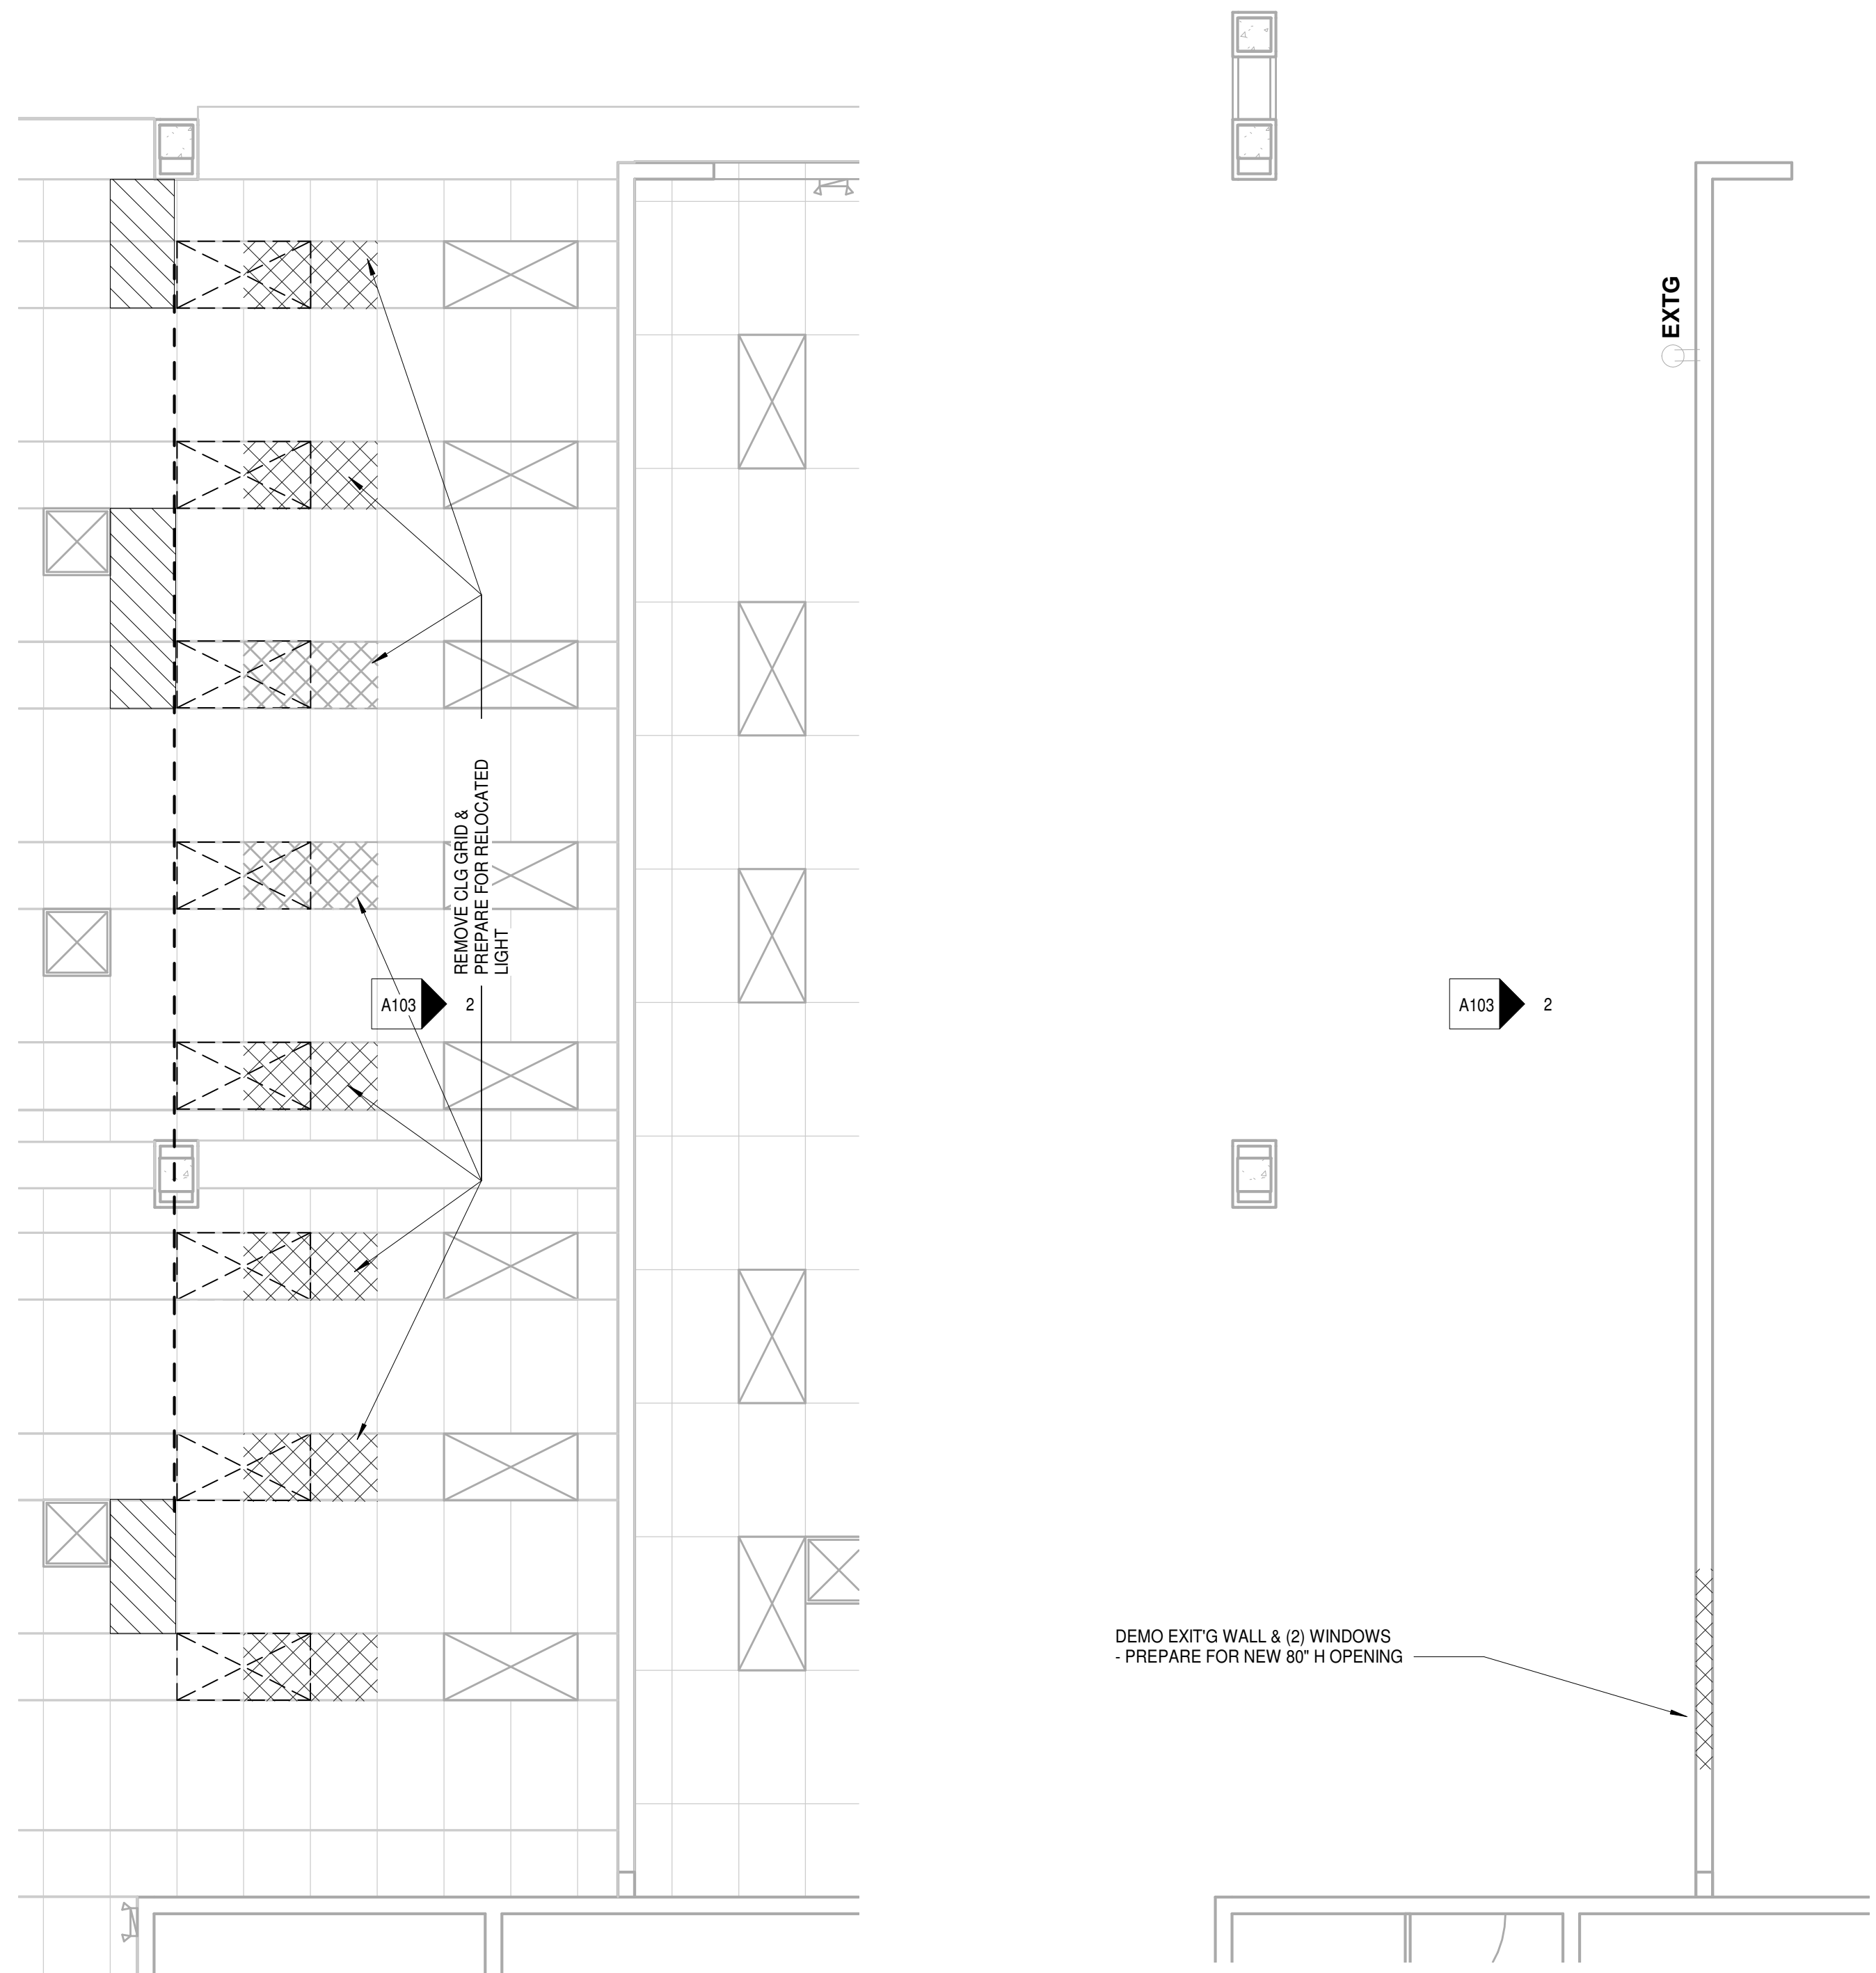

3 DEMO RCP YOUNG ADULT AREA
A103 1/4" = 1'-0"

1 DEMO PLAN YOUNG ADULT AREA
A103 1/4" = 1'-0"

TAMARA PEACOCK, R.A.
LICENSE NO. 12126

PROJ. DESIGNER
CAPT. APPROVER

DRAWN BY
REVISOR BY
CHECKER

| ISSUED FOR | REVISION DATE | REVISION |
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THE TAMARA PEACOCK COMPANY
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Phone: 828.696.4000 Fax: 954.728.9225

PROJECT NAME:
Henderson Co. Public Library
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HENDERSONVILLE, NC 28792


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YOUNG ADULT AREA DEMO

PROJ. NO.: 1804
DATE: 8/3/2018
SHEET NO.: 246-37 PM
A103


BID SET
7-2018

| | |
|--|--|
| | EXISTING COLUMN WITH GWB ENCLOSURE |
| | EXISTING 12 INCH WALL |
| | EXISTING EXTERNAL BRICK WITH 2X4 MTL STUD WALL |
| | EXISTING WALL 2X4 MTL STUD WALL |
| | NEW WALL 2X4 MTL STUD WALL |
| | AREA OF A.C.T. BEING REMOVED FOR WALL |


WALL LEGEND

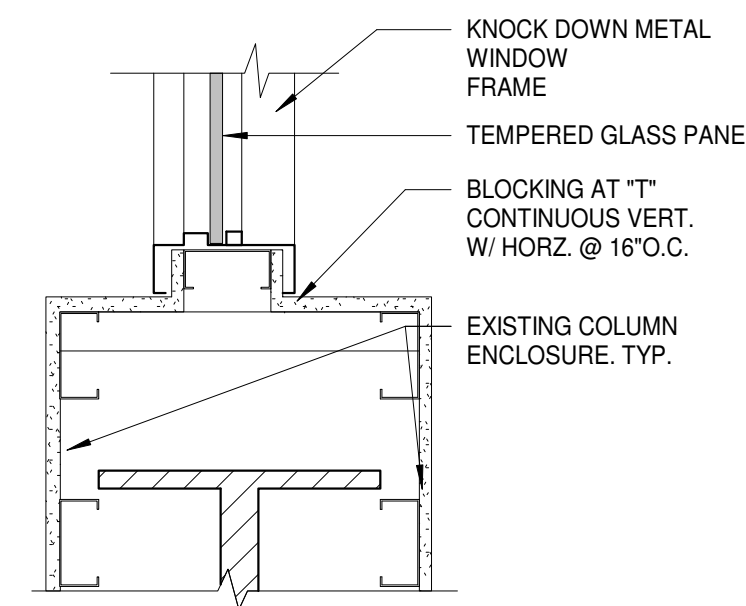


6 JAMB TO WALL DETAIL
A103.1 1/2" = 1'-0"

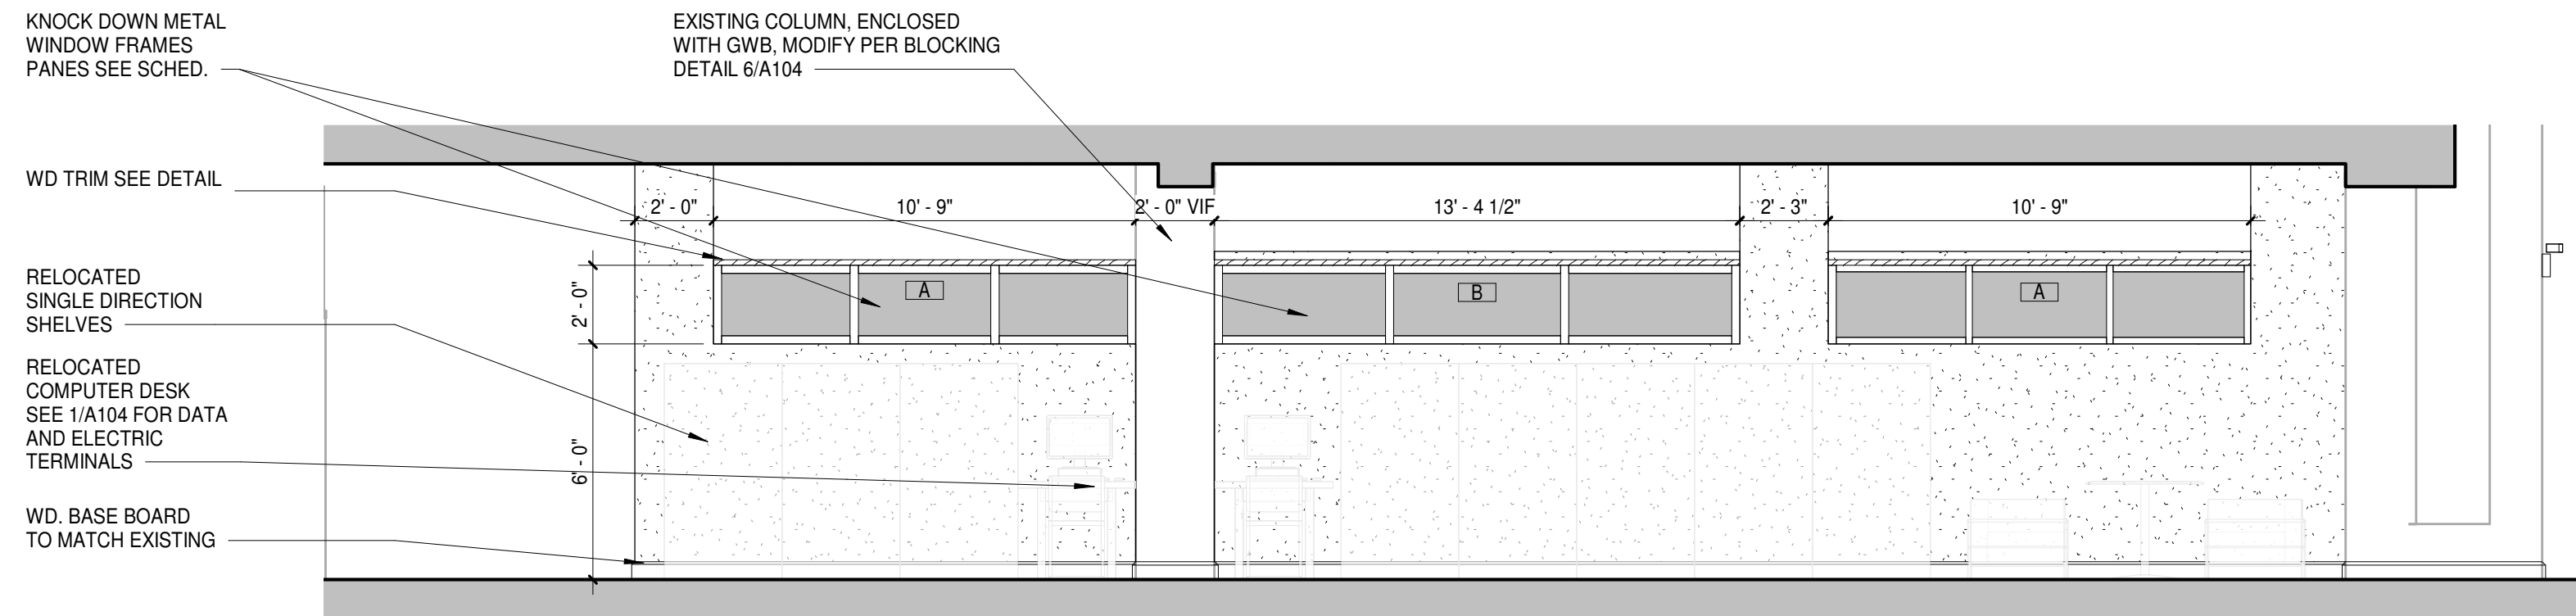


3 ELEVATION YOUNG ADULT AREA
A103.1 1/4" = 1'-0"

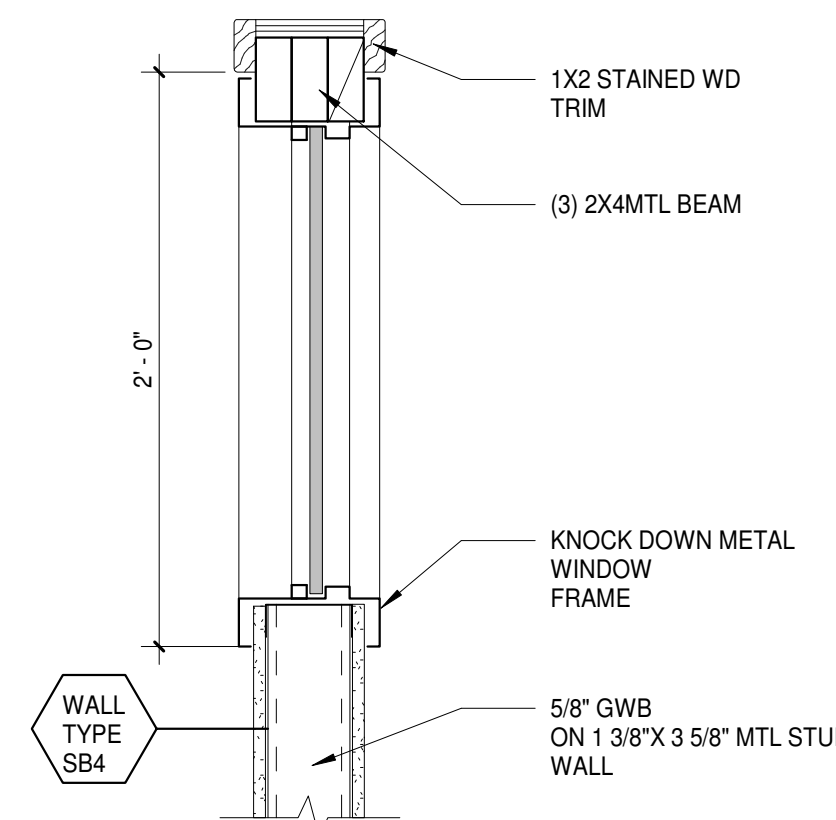


5 SILL AT PARTITION DETAIL
A103.1 1/2" = 1'-0"

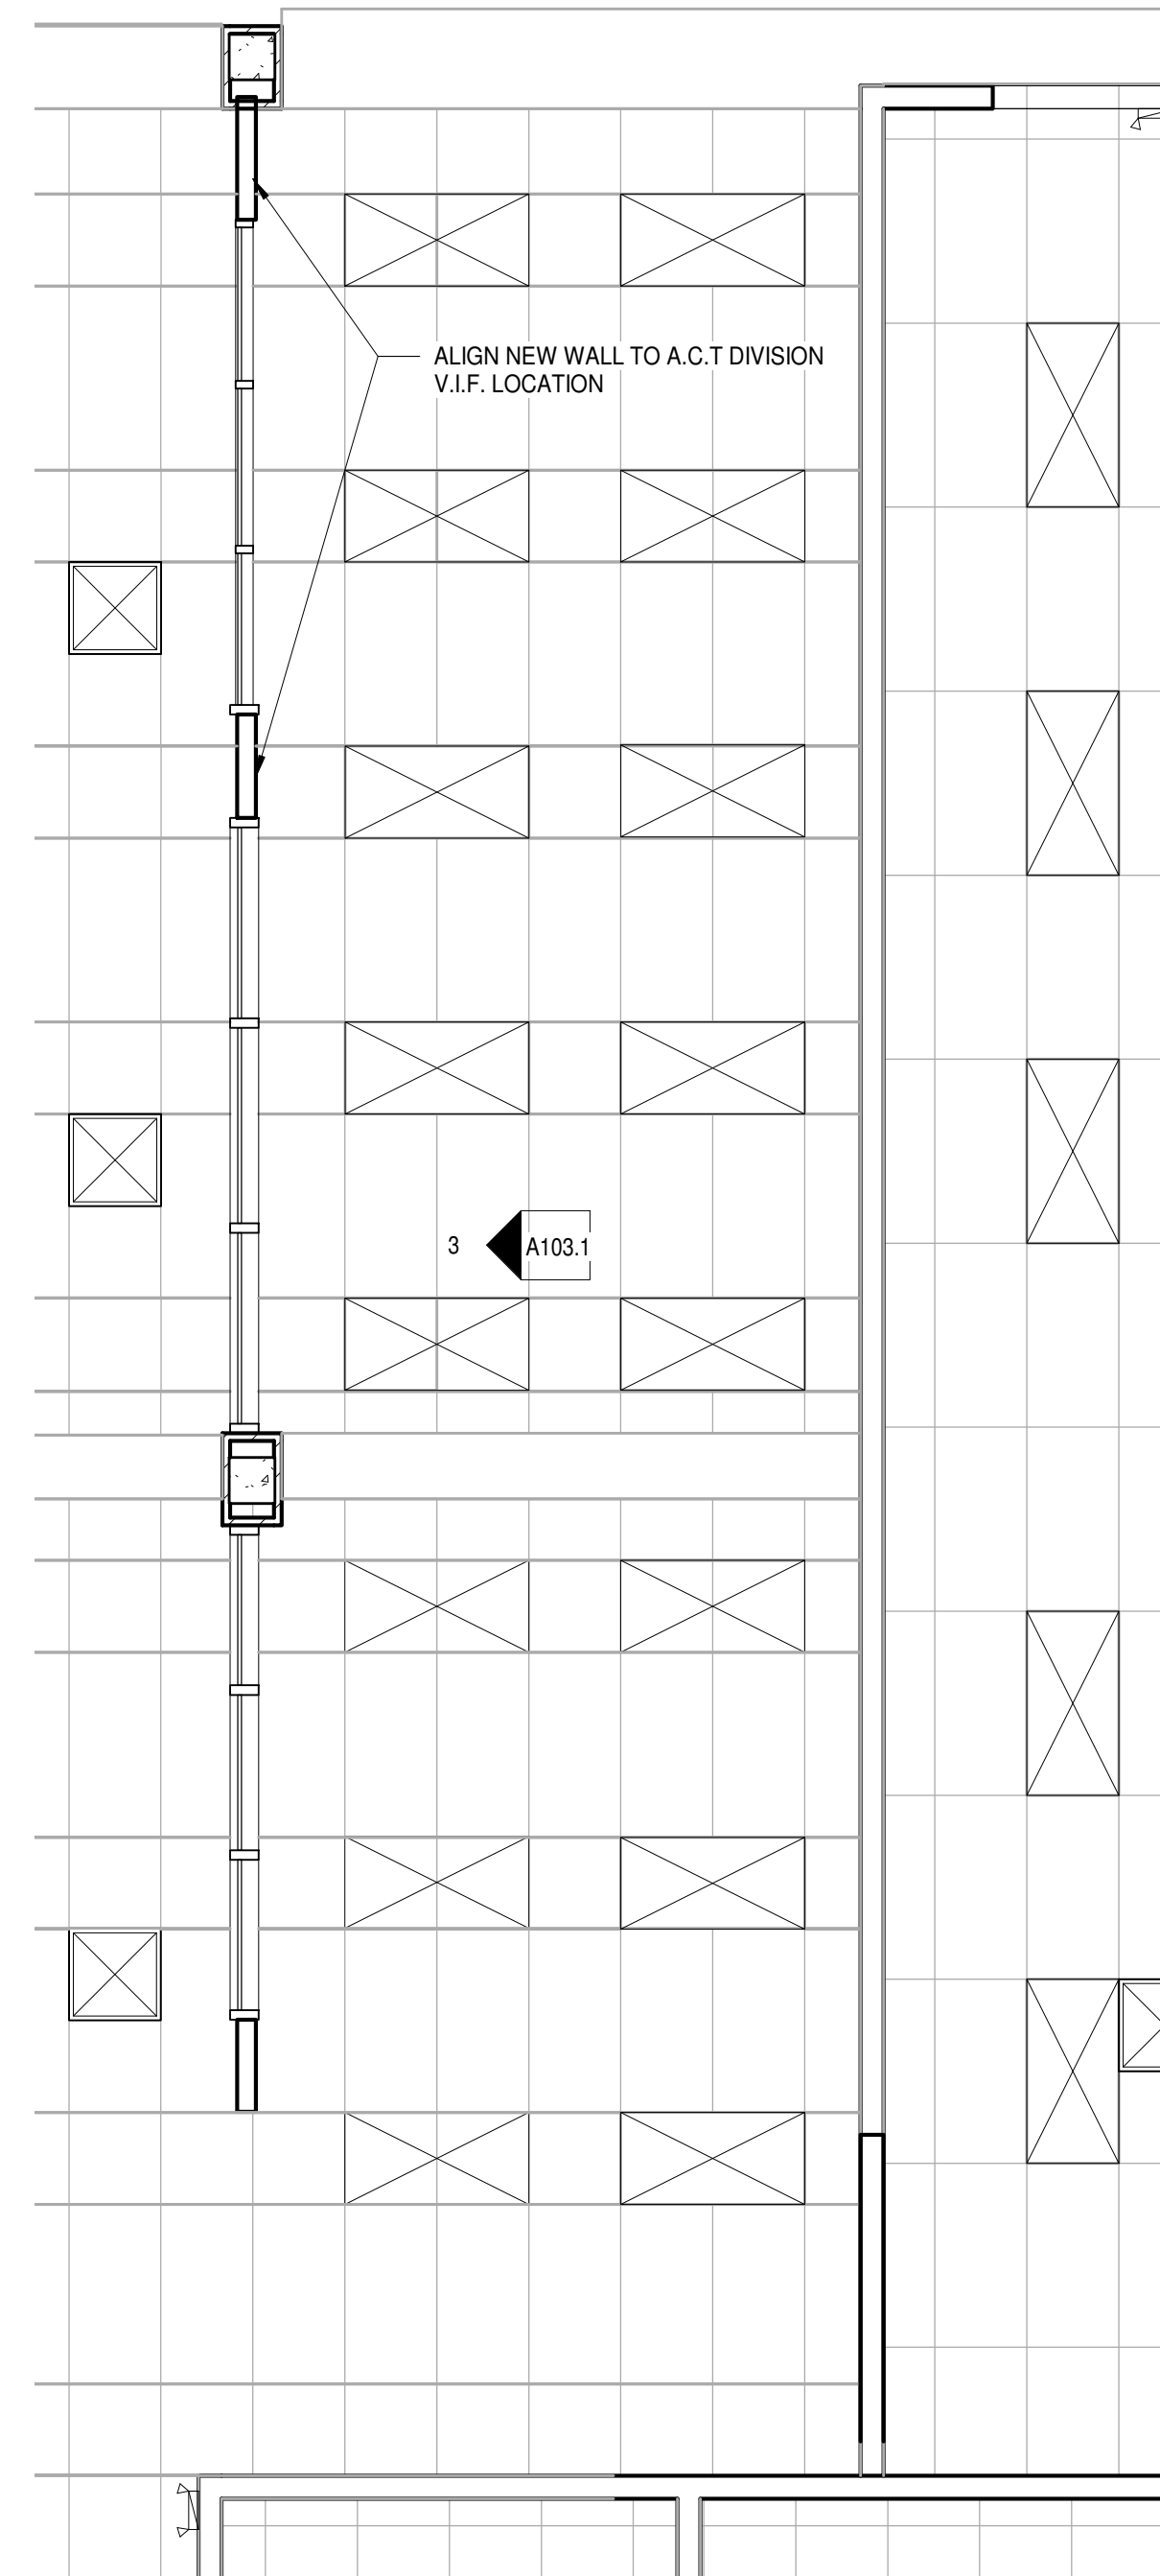

2 YOUNG ADULT AREA RCP
A103.1 1/4" = 1'-0"

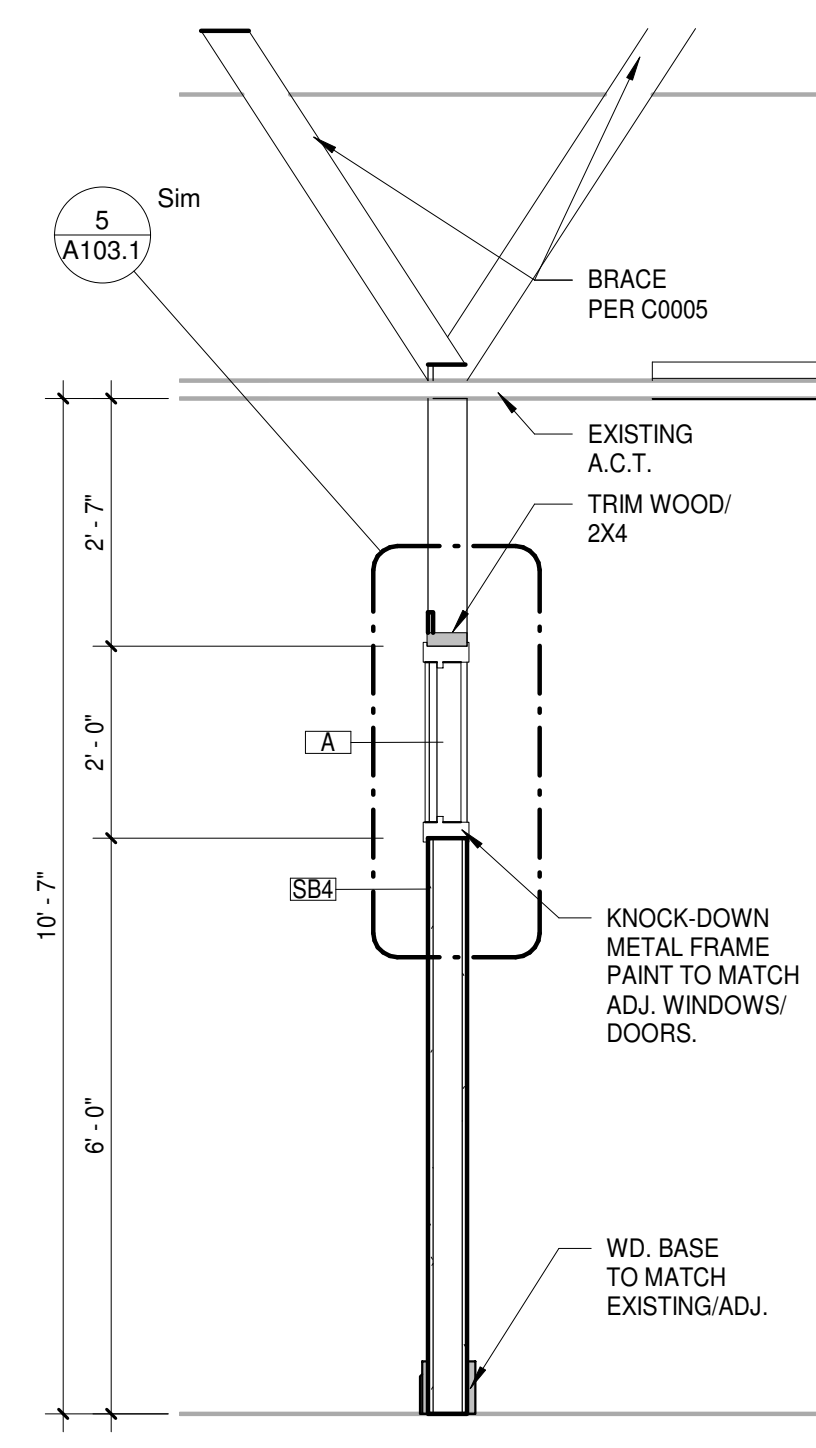

4 Y.A. SCREENWALL SECTION
A103.1 1/2" = 1'-0"

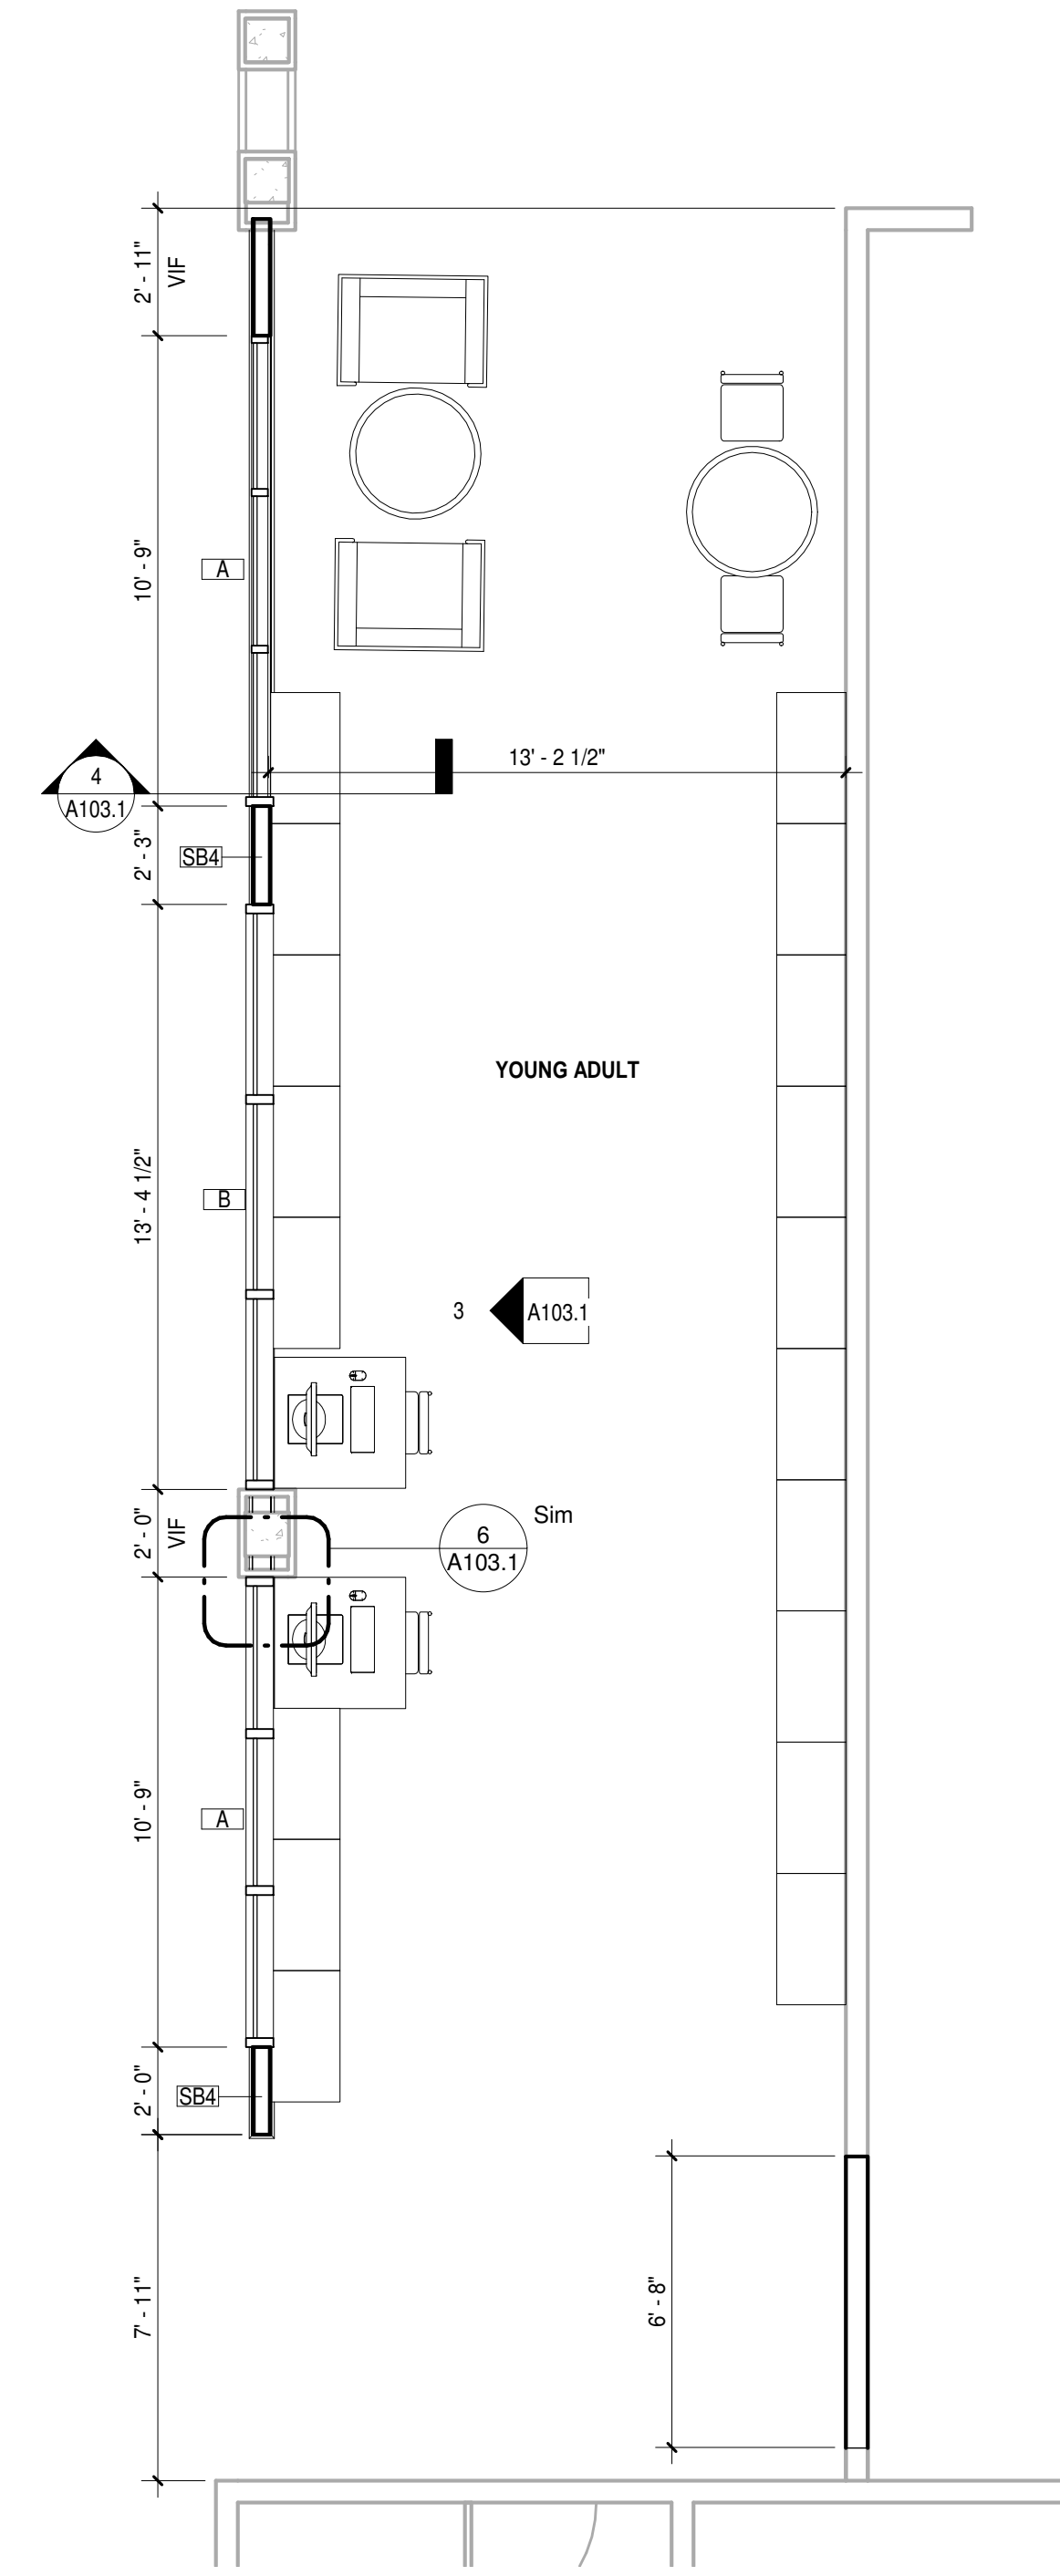

1 NEW YOUNG ADULT AREA
A103.1 1/4" = 1'-0"

TAMARA PEACOCK, R.A.
LICENSE NO. 12126

| | |
|----------------|--------------------|
| DESIGNER | AUTHOR |
| CAPT. APPROVER | REVISOR BY CHECKER |

ISSUED FOR

REVISION

REVISION DATE

THE TAMARA PEACOCK COMPANY
Architects

104 1st Ave E. Hendersonville, NC 28792
Phone: 828.696.4000 Fax: 954.728.9225

PROJECT NAME:
Henderson Co. Public Library
301 N. WASHINGTON ST.
HENDERSONVILLE, NC 28792


SHEET NAME:
YOUNG ADULT AREA NEW WORK

PROJ. NO. 1804 DATE: 8/3/2018
2:46-35 PM
SHEET NO. 1


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BID SET
7-2018


1. THE CONTRACTOR SHALL ACQUANT THEMSELVES WITH THE EXISTING STRUCTURE PRIOR TO CONSTRUCTION.
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9. THE CONTRACTOR SHALL VERIFY ROUGH OPENING SIZES OF DOORS AND WINDOWS PRIOR TO CONSTRUCTION.
10. THE CONTRACTOR SHALL PROVIDE ADEQUATE PROTECTION TO ALL EXISTING WORK, FURNISHINGS AND FIXTURES/APPLIANCES THAT ARE TO BE RETAINED, SO THAT THEY WILL NOT BE DAMAGED.
11. EXISTING CEILINGS MUST BE PROPERLY SHORED PRIOR TO REMOVAL OF ANY EXISTING BEARING POINTS, POSTS OR COLUMNS.

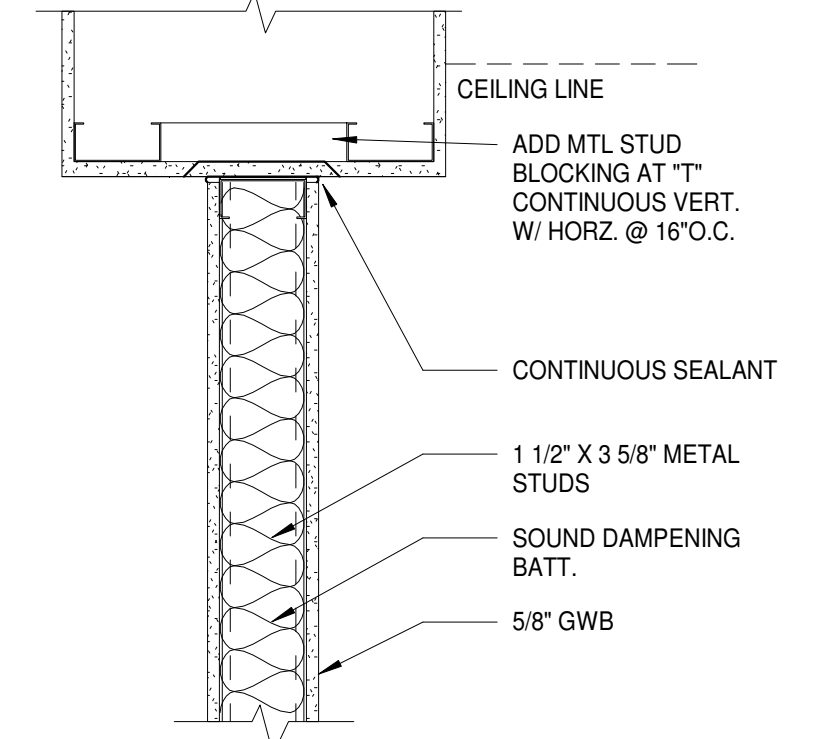


8 A104 ACoustic PARTITION DETAIL GWB
1 1/2" = 1'-0"

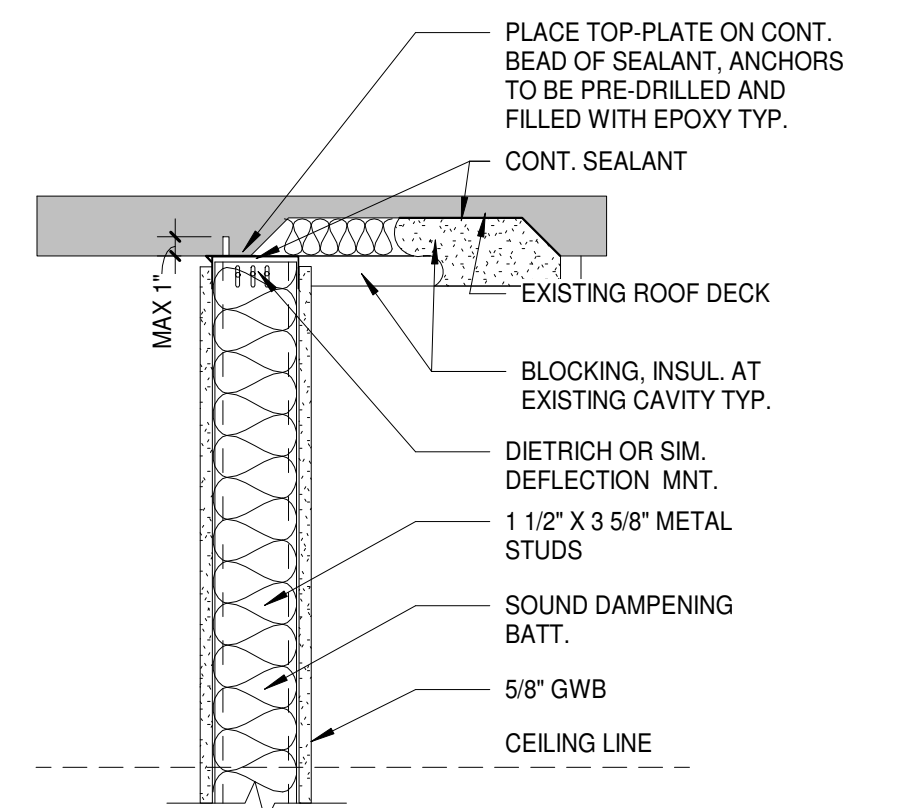

7 A104 ACoustic PARTITION DETAIL @ SLAB
1 1/2" = 1'-0"

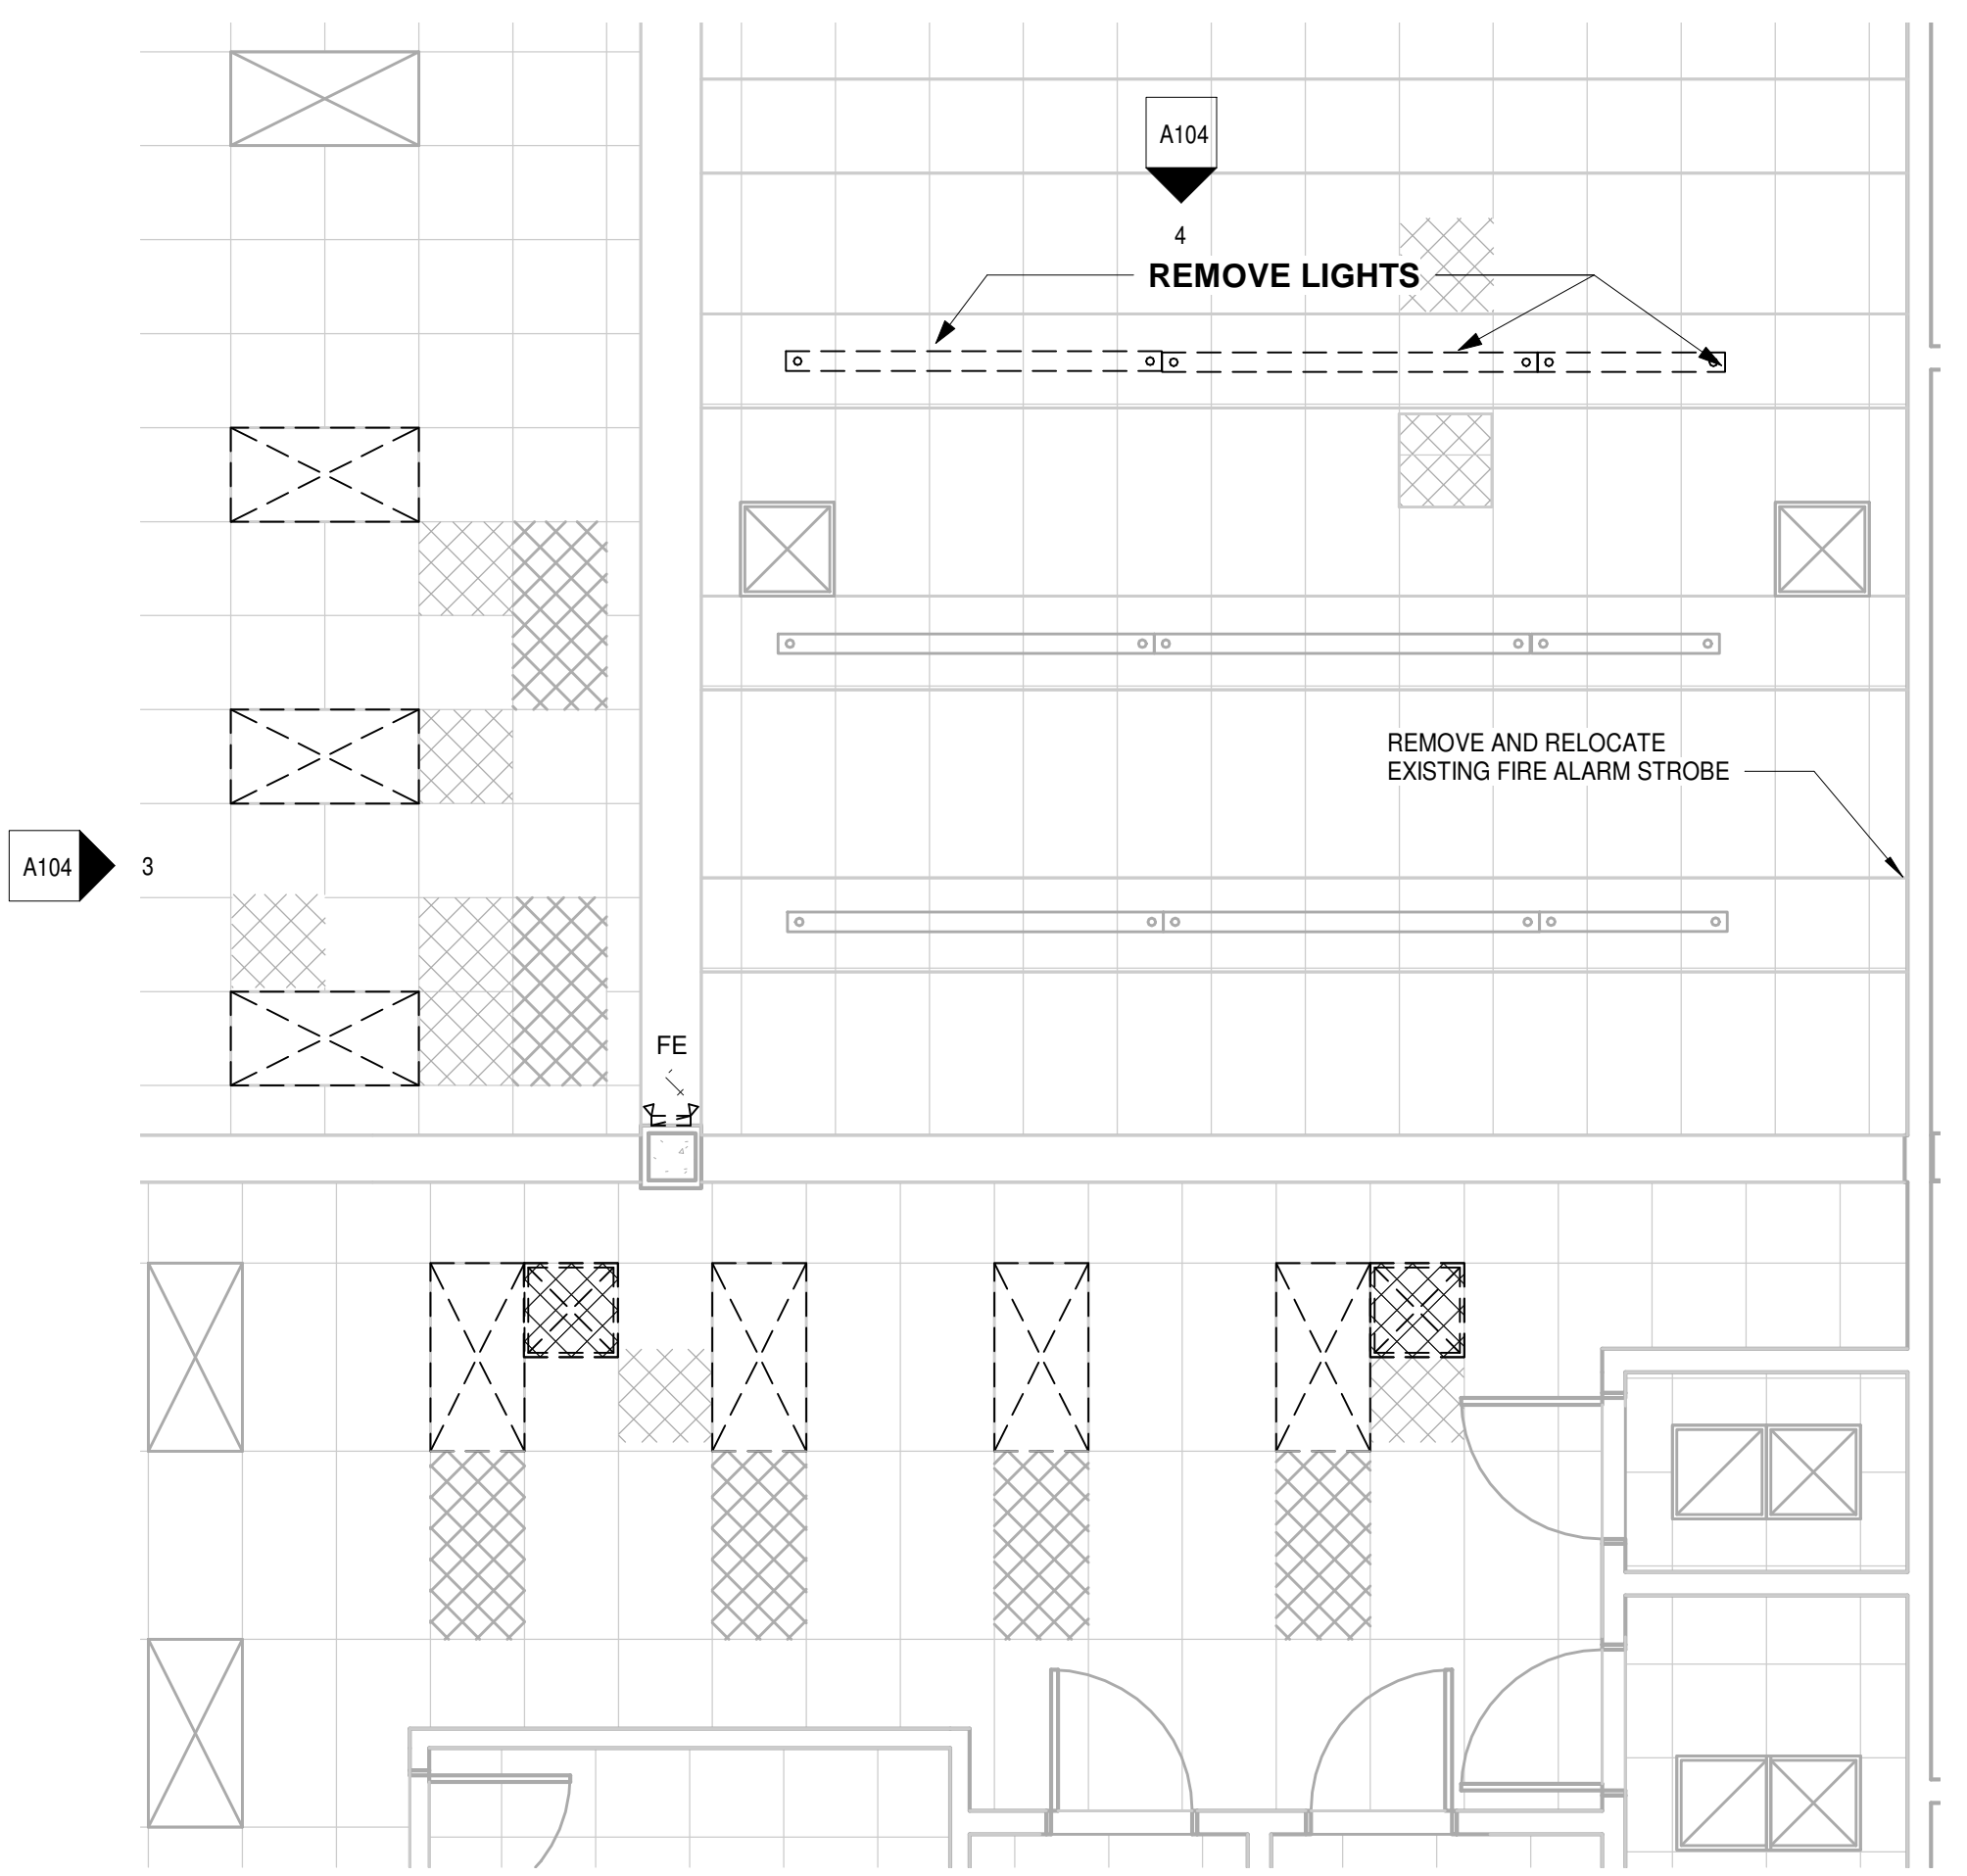

5 A104 CLASSROOM RCP DEMO
1/4" = 1'-0"

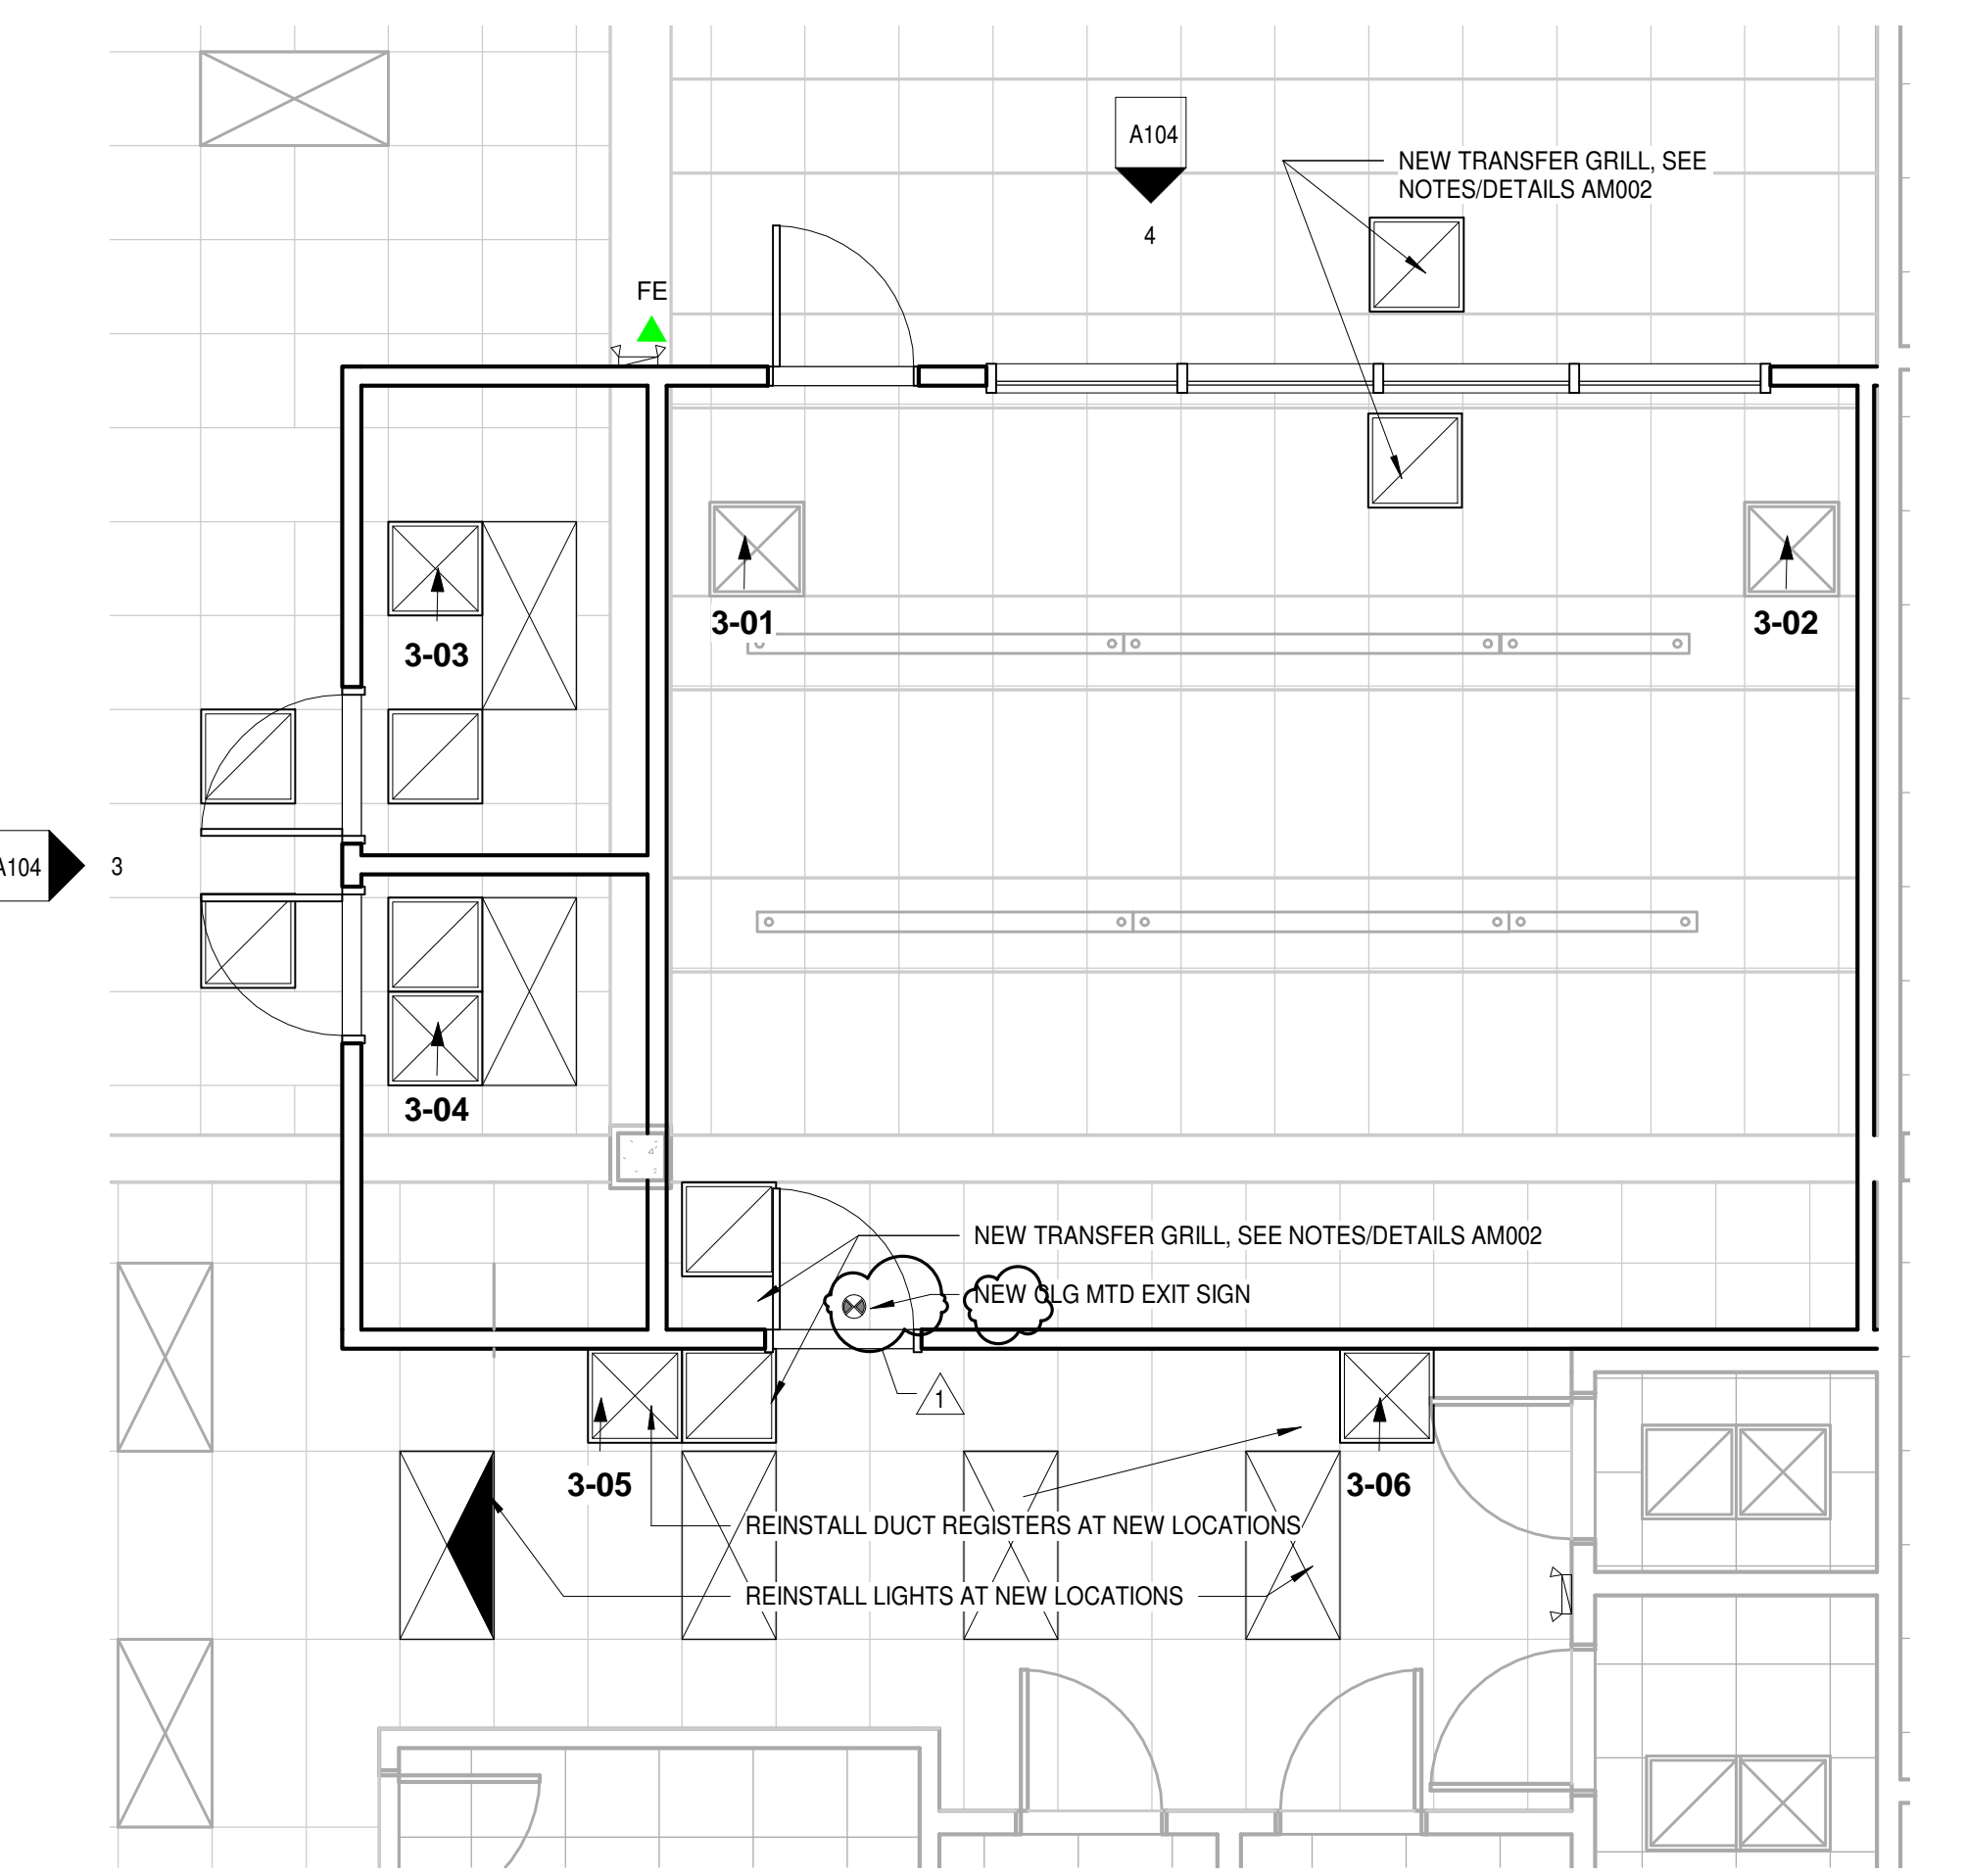

2 A104 NEW CLASSROOM RCP
1/4" = 1'-0"


GENERAL DEMOLITION NOTES
NTS

| | |
|--|--|
| | EXISTING COLUMN WITH GWB ENCLOSURE |
| | EXISTING 12 INCH WALL |
| | EXISTING EXTERNAL BRICK WITH 2X4 MTL STUD WALL |
| | EXISTING WALL 2X4 MTL STUD WALL |
| | NEW WALL 2X4 MTL STUD WALL |
| | AREA OF A.C.T. BEING REMOVED FOR WALL |


WALL LEGEND

SCOPE OF WORK CLASSROOM/ STUDY ROOMS:


1. Demolish Ceiling as shown (storage of existing A.C.T., Books, Shelves, Furniture, Lights, Switches, etc to be coordinated).
2. Add Classroom and Study Rooms as shown, retrofitting HVAC duct, and lights to new locations (storage of existing A.C.T., Books, Shelves, Furniture, Lights, Switches, etc to be coordinated).

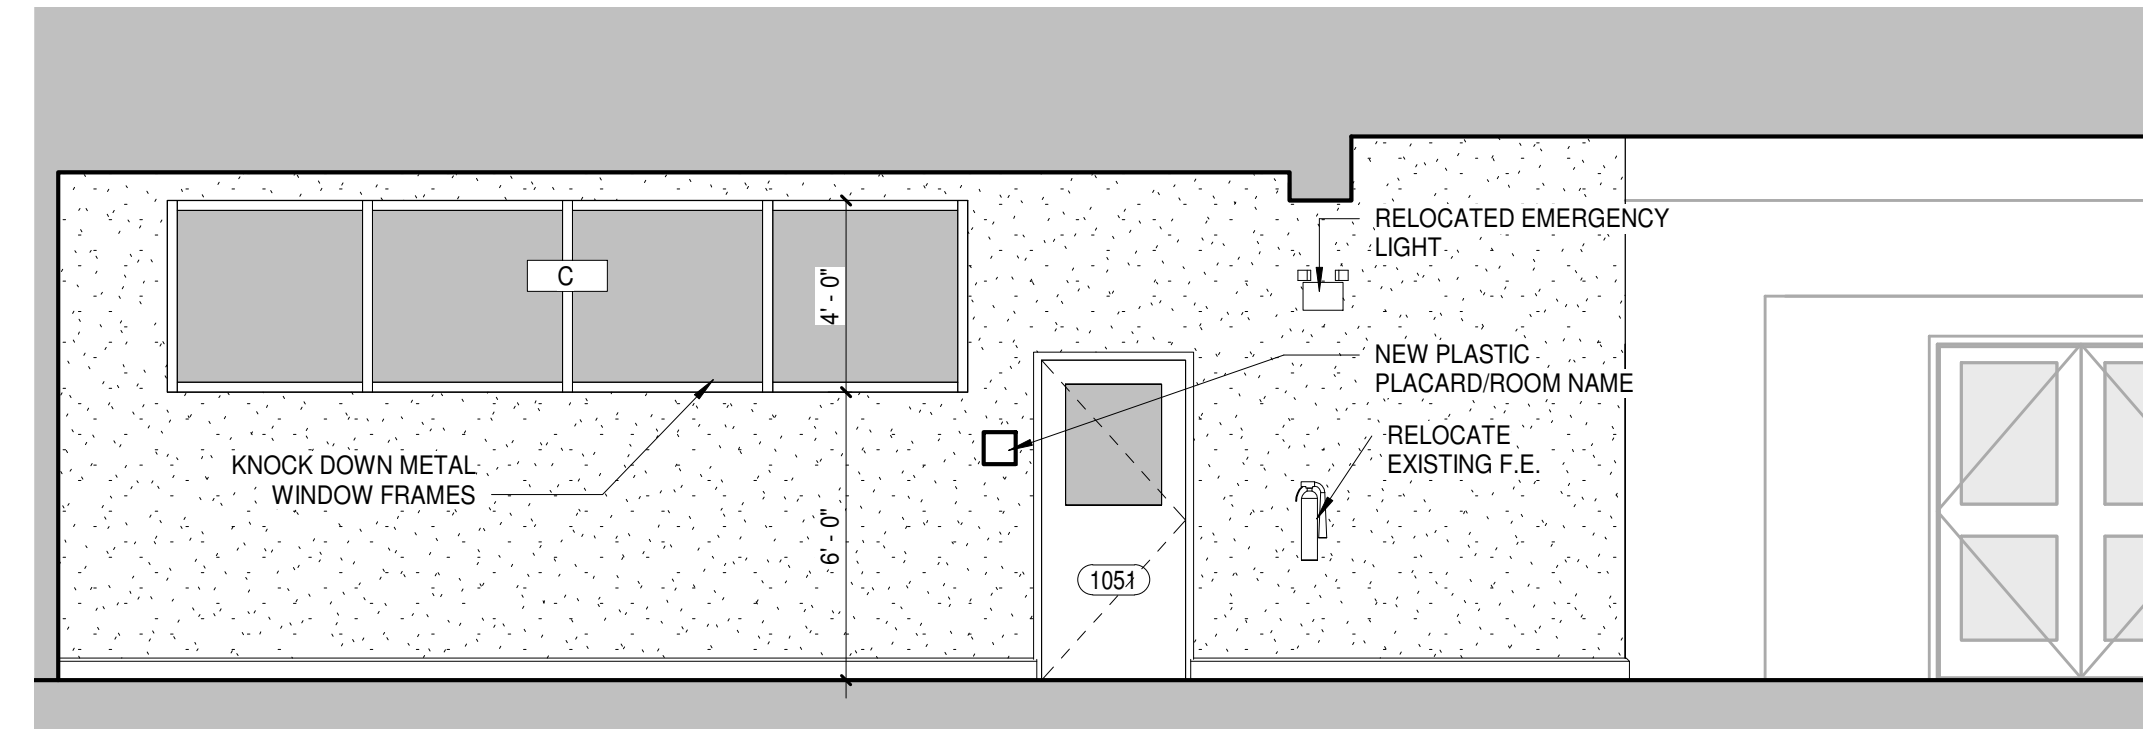


4 A104 ELEVATION CLASSROOM
1/4" = 1'-0"

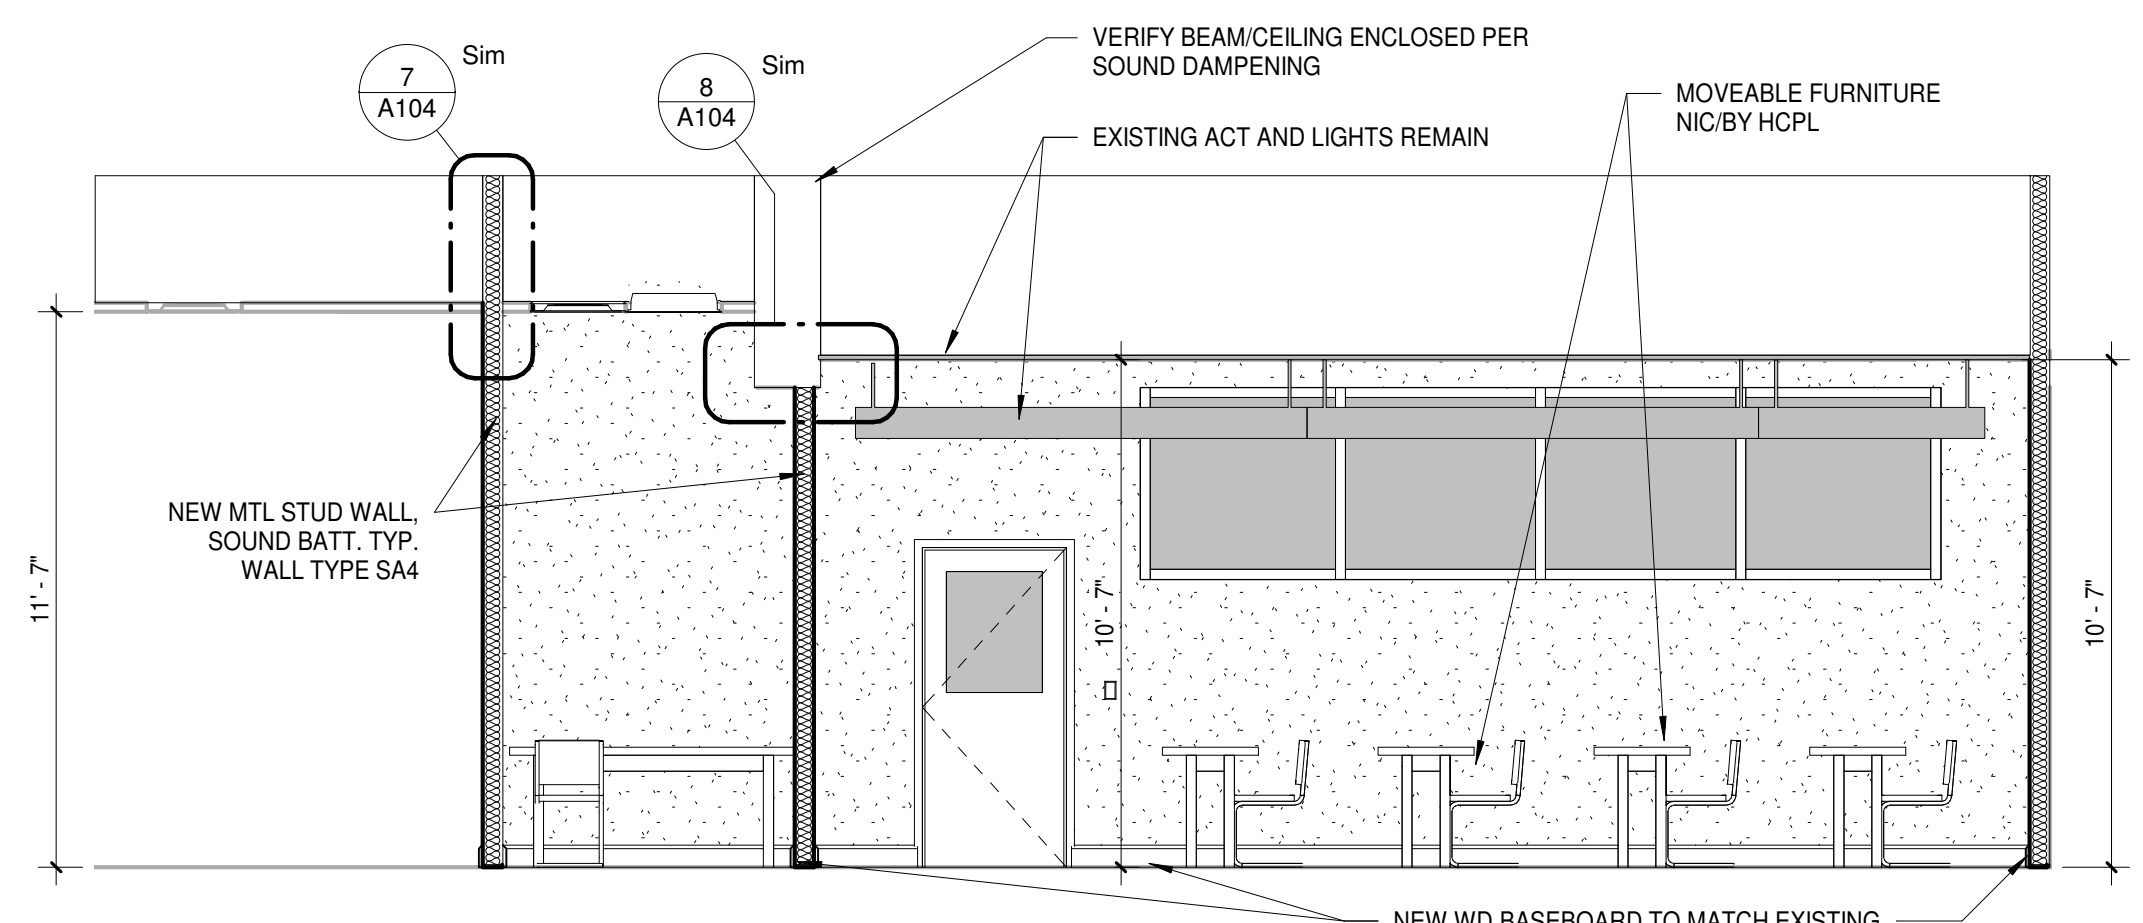

6 A104 CLASSROOM SECTION
1/4" = 1'-0"

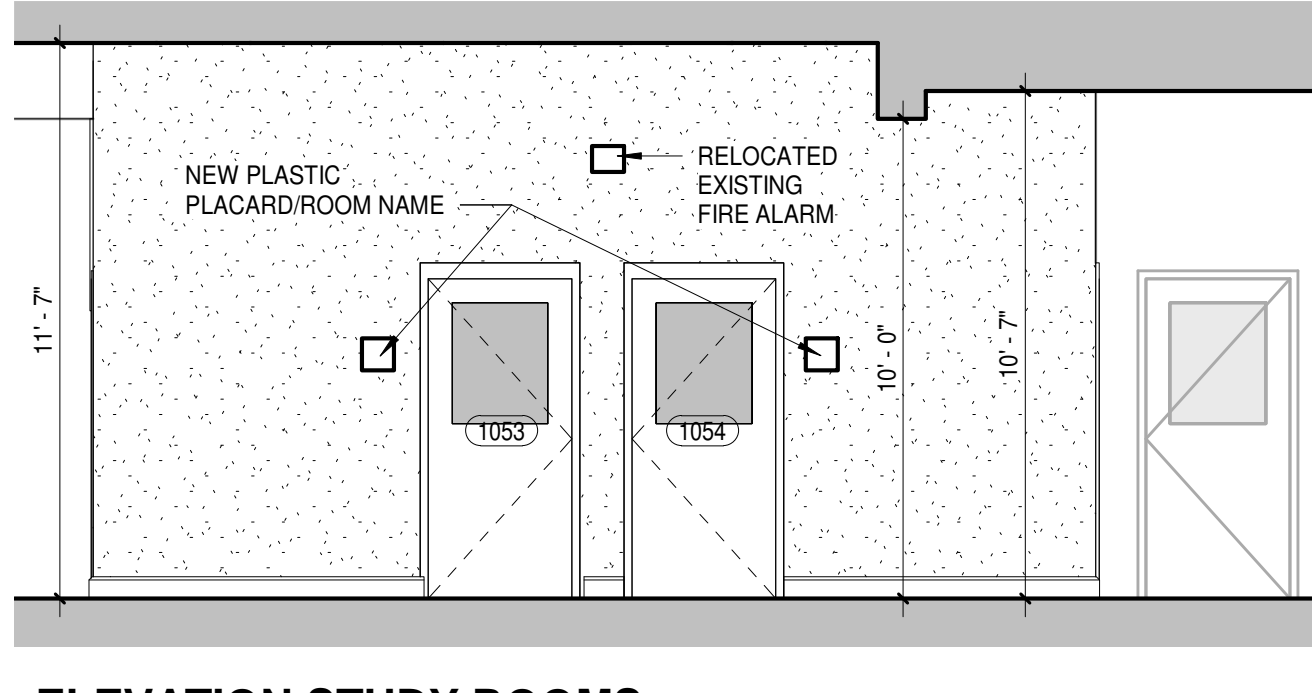

3 A104 ELEVATION STUDY ROOMS
1/4" = 1'-0"

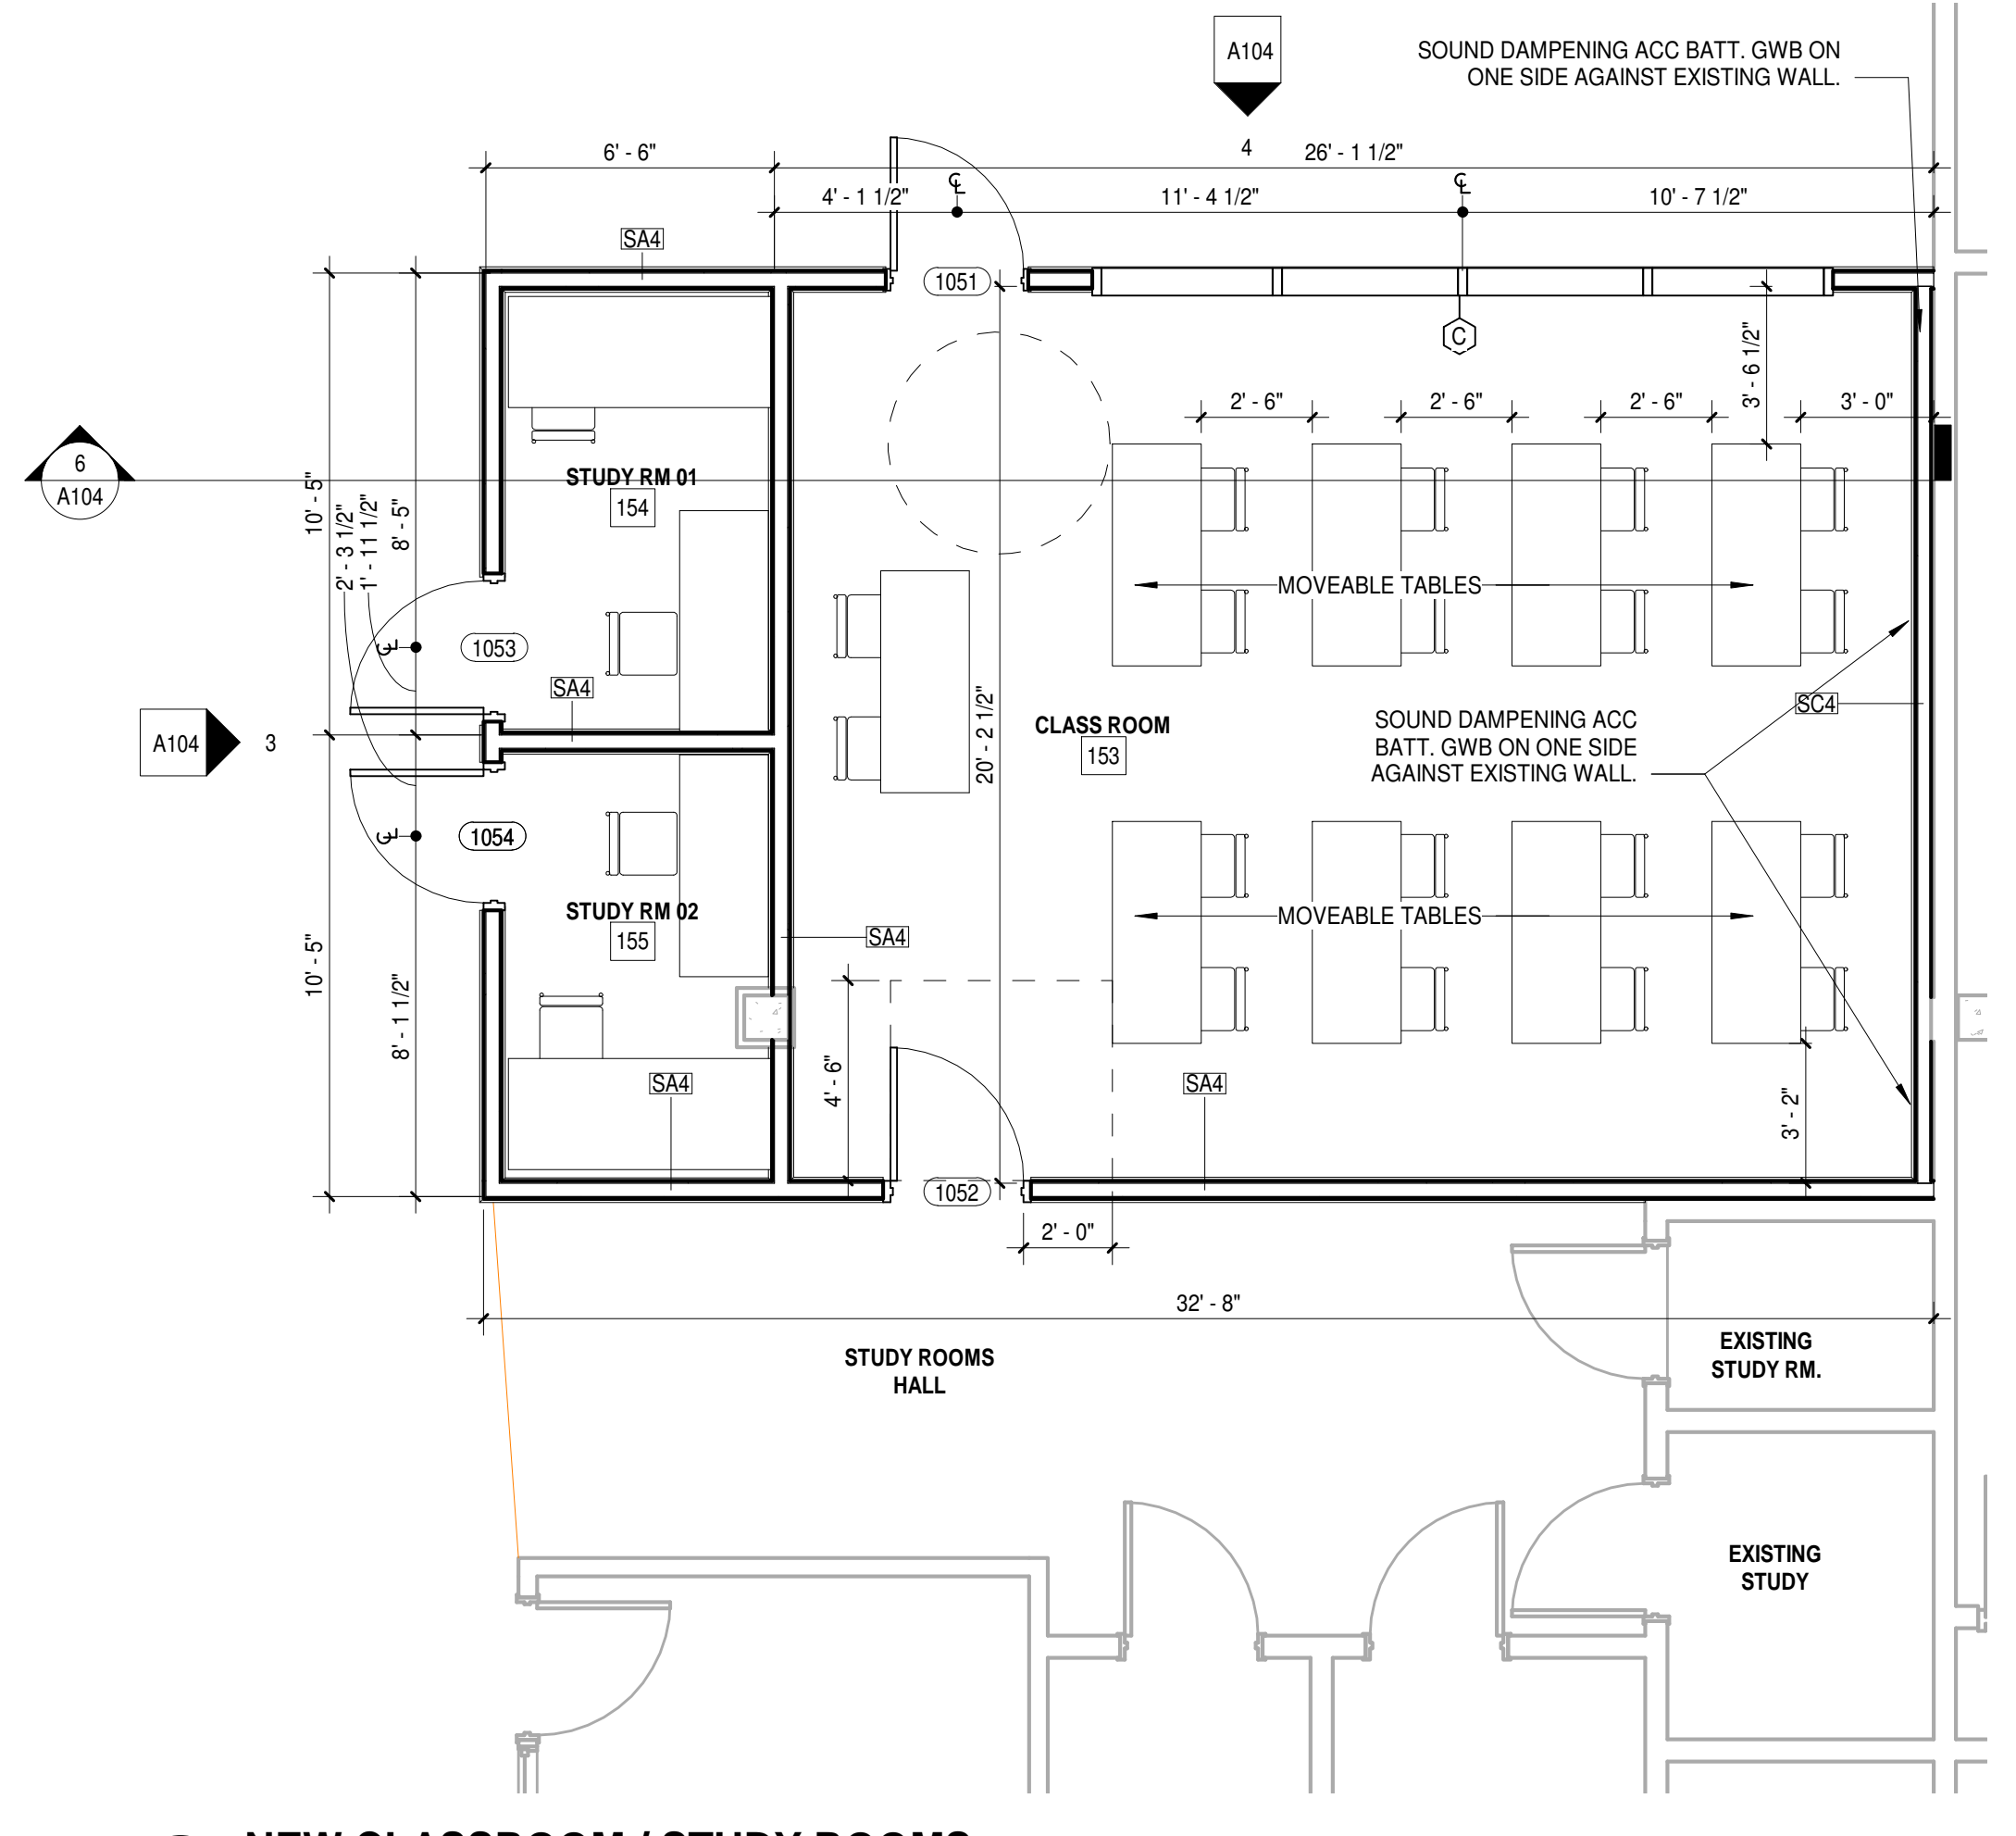

1 A104 NEW CLASSROOM / STUDY ROOMS
1/4" = 1'-0"
NOTE: ALL FURNITURE TO BE SUPPLIED BY HCPL.

BID SET
7-2018

TAMARA PEACOCK, R.A.
LICENSE NO. 12126

PROJ. DESIGNER: CAPT. APPROVER: DW
DRAWN BY: AUTHOR: REVISION BY: CHECKER:

ISSUED FOR: DW
REVISION DATE: 7/17/2018
REVISION: 1

THE TAMARA PEACOCK COMPANY
Architects


104 1st Ave E. Hendersonville, NC 28792
Phone: 828.696.4000 Fax: 954.728.9225

PROJECT NAME:
Henderson Co. Public Library Classroom Area Layouts
301 N. WASHINGTON ST. HENDERSONVILLE, NC 28792

SHEET NAME:
ENLARGED CLASSROOM AREA LAYOUTS

PROJ. No.: 1804 DATE: 8/3/2018
SHEET No.: 214-6-44 PM

A104

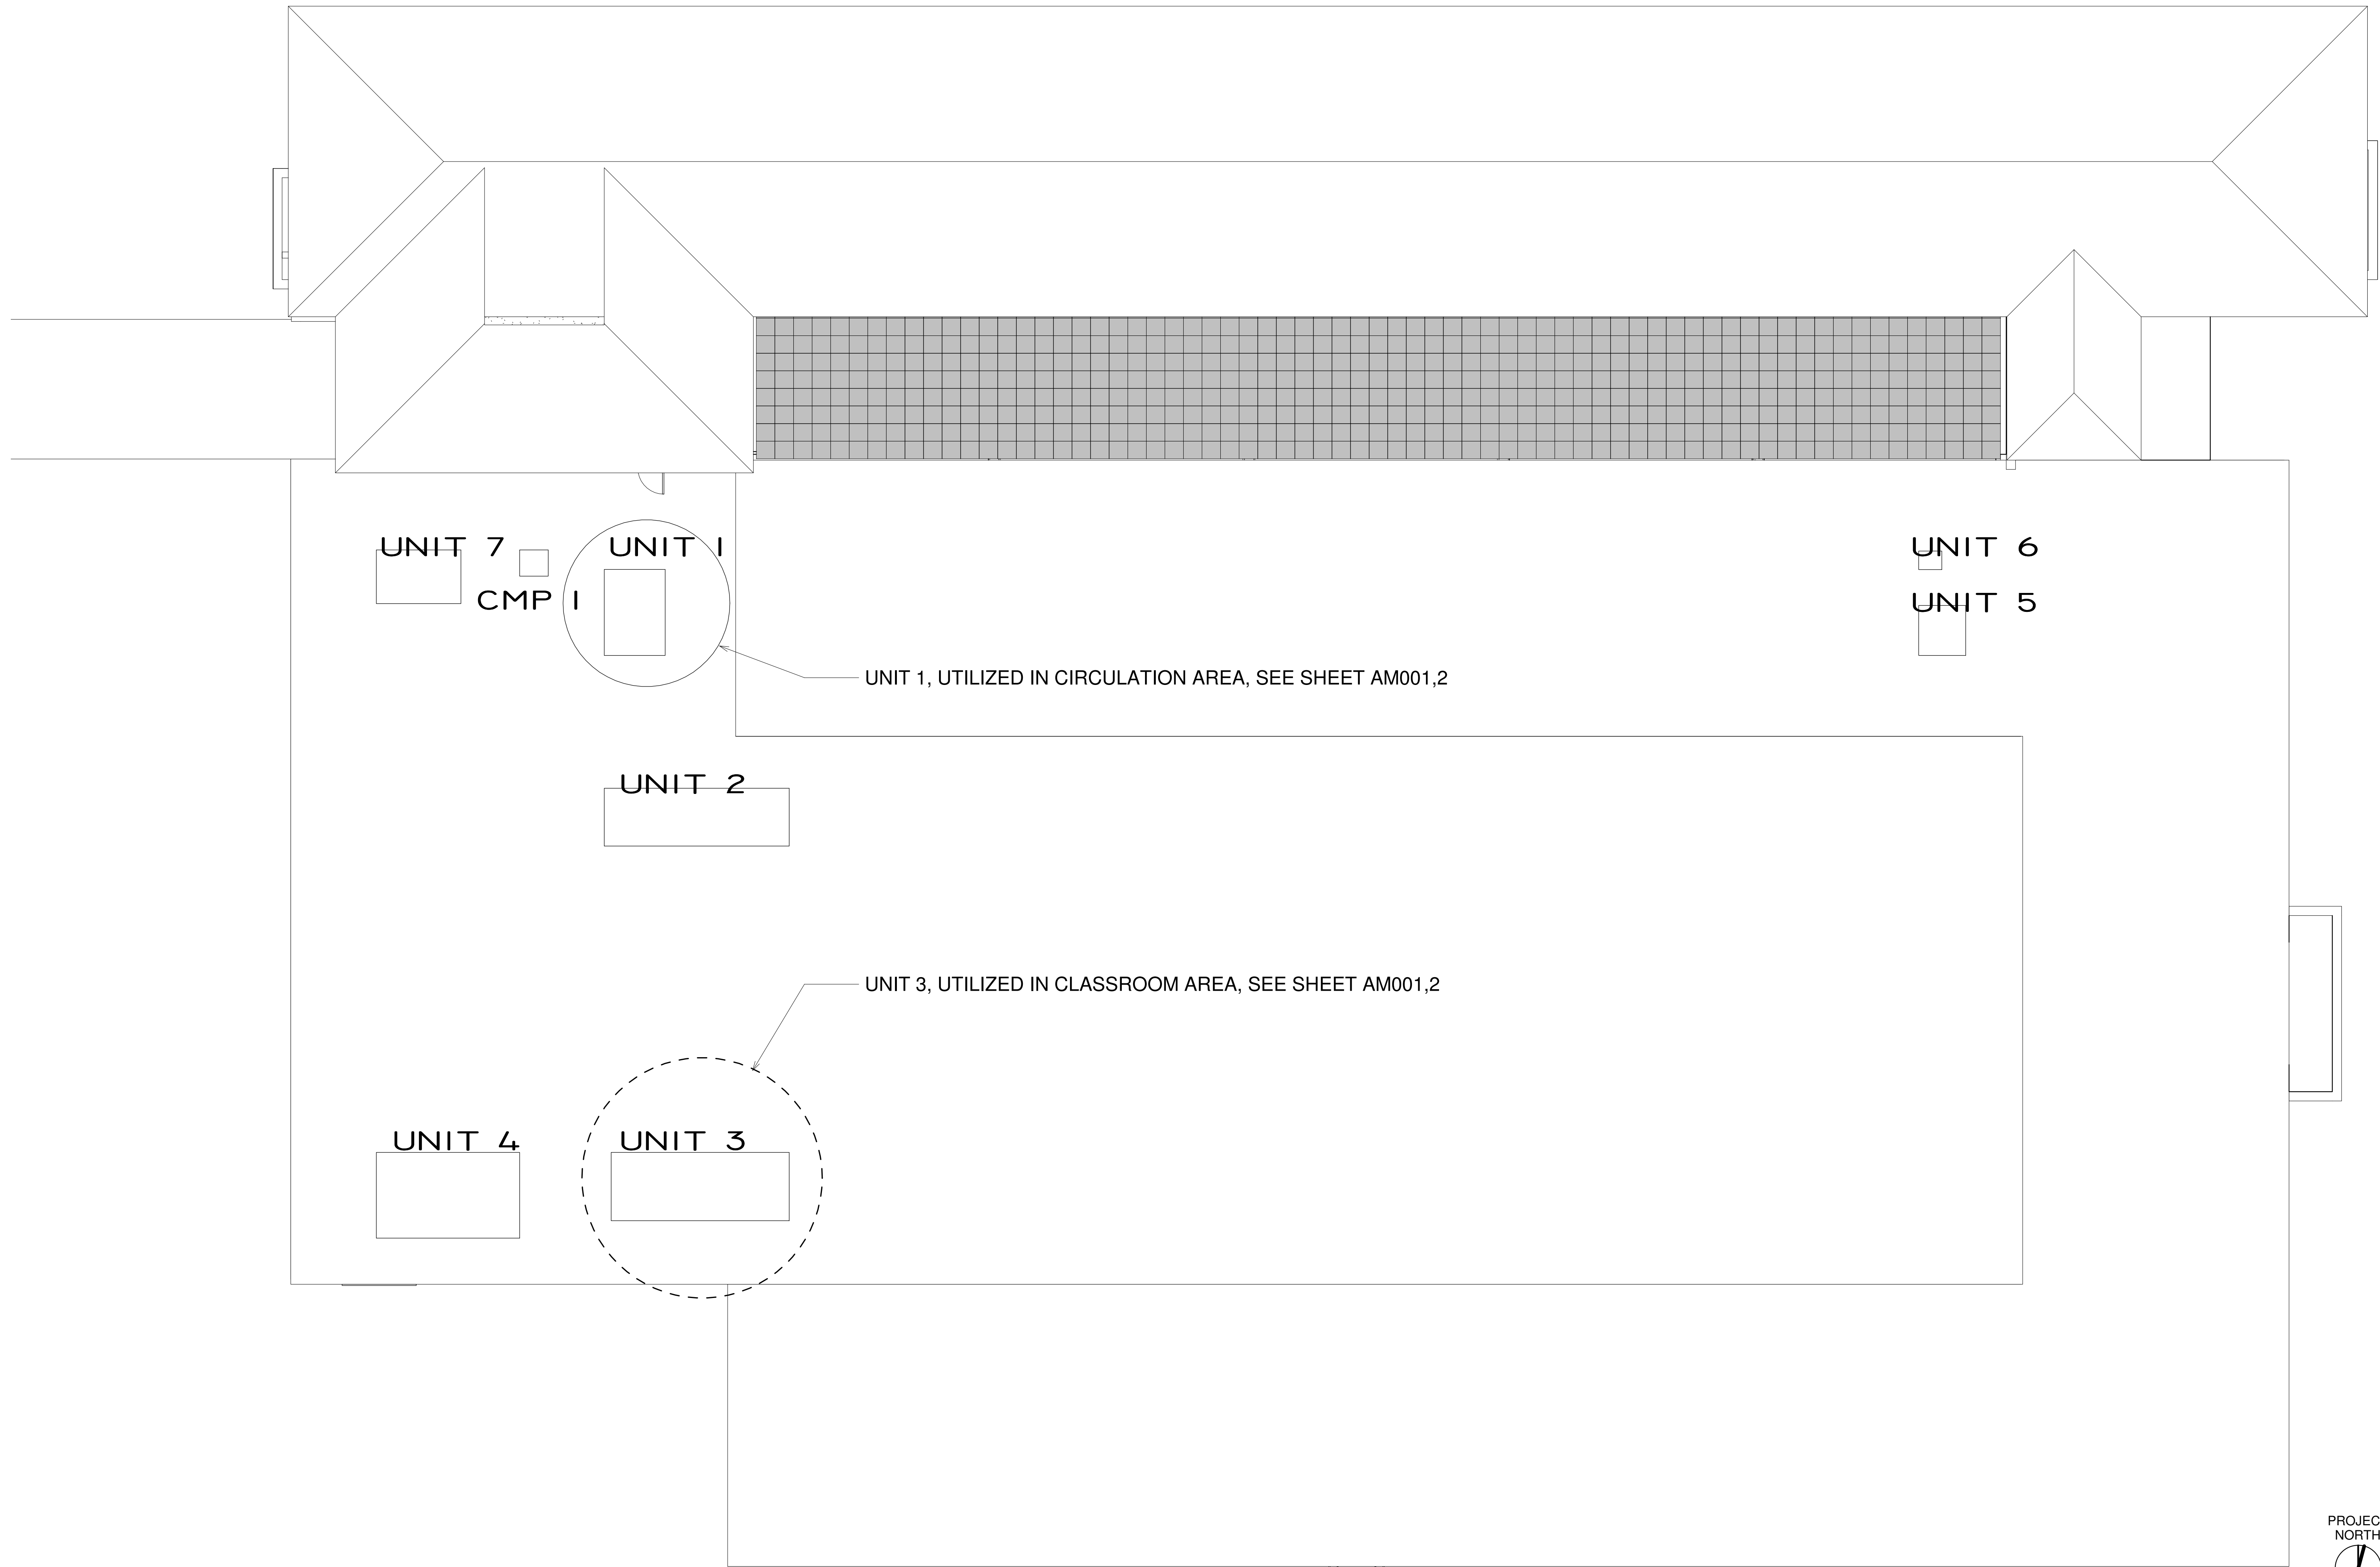

TAMARA PEACOCK, R.A.
LICENSE No. 12126

| | |
|----------------|------------|
| PROJ. DESIGNER | DRAWN BY |
| CAPT. APPROVER | REVISOR BY |
| | CHECKER |

| REVISION | REVISION DATE | ISSUED FOR |
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THE TAMARA PEACOCK COMPANY
Architects

104 1st Ave E, Hendersonville, NC 28792
Phone: 828.696.4000 Fax: 954.728.9225

PROJECT NAME:
Henderson Co. Public Library
301 N. WASHINGTON ST.
HENDERSONVILLE, NC 28792


SHEET NAME:
ROOF PLAN

PROJ. No. 1804 DATE: 8/3/2018
SHEET No. 1 2:46:42 PM
A301

1 ROOF PLAN
1/8" = 1'-0"

PROJECT NORTH

BID SET
7-2018

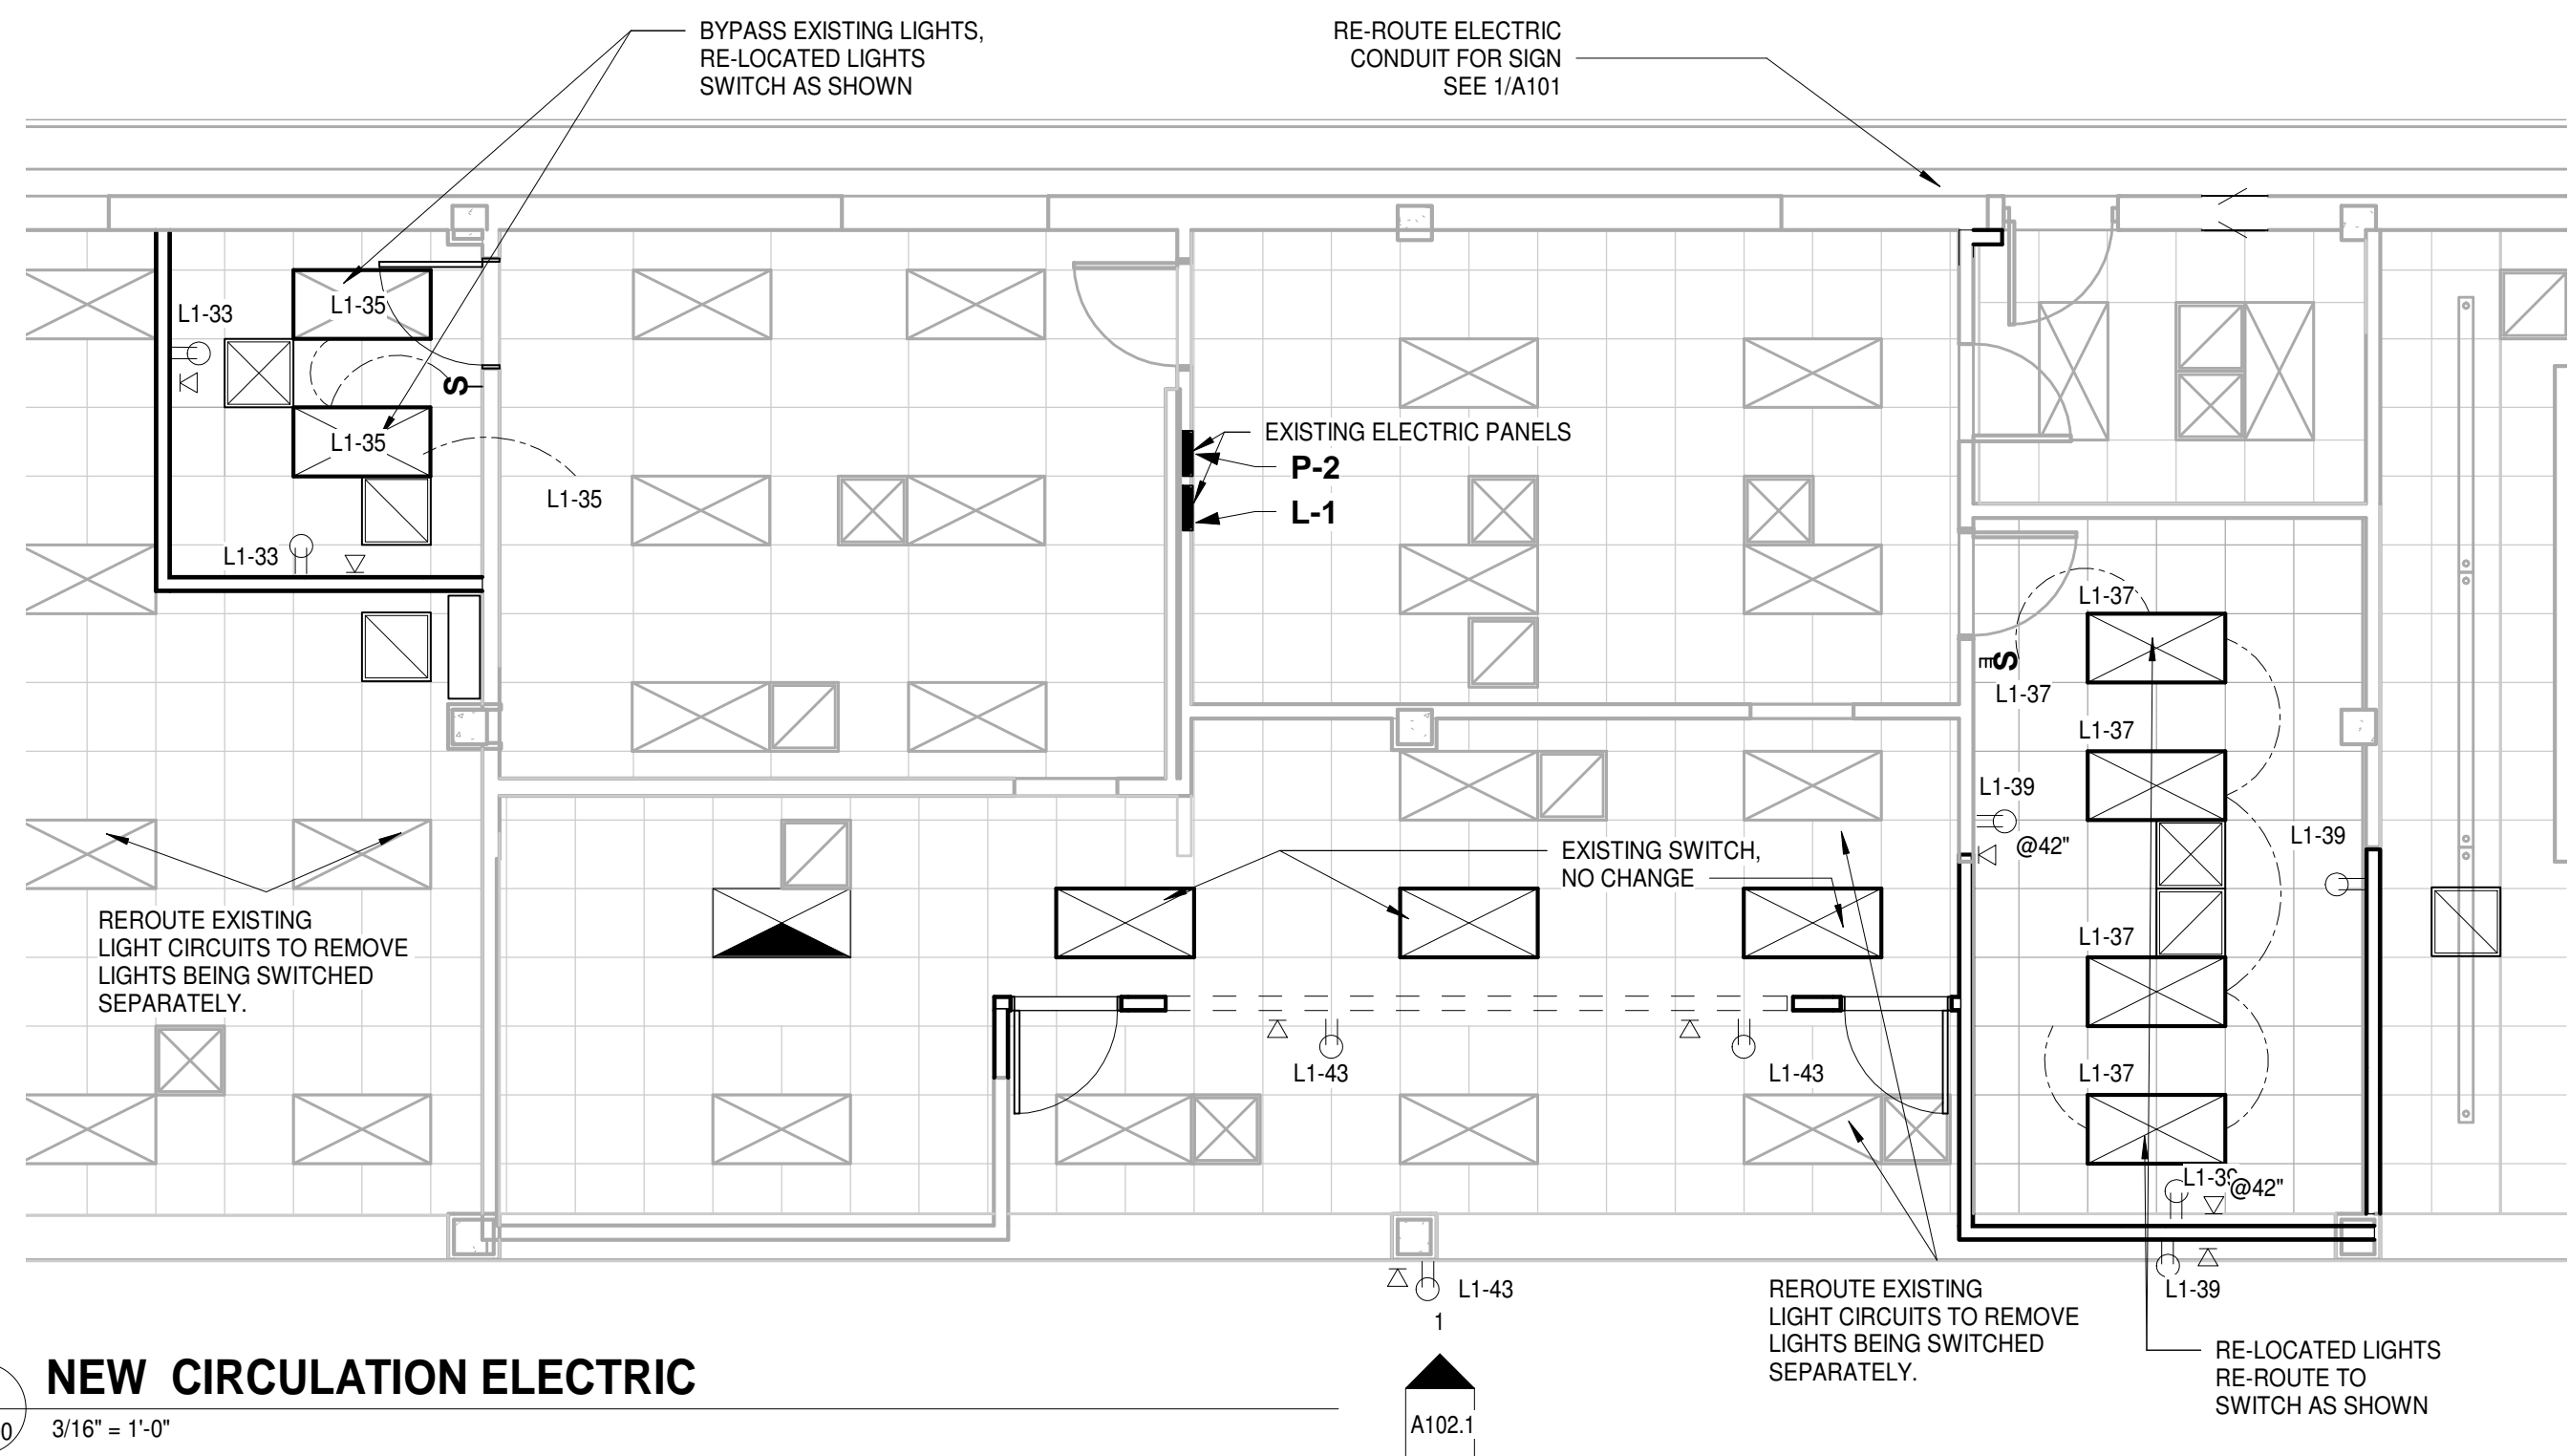

ELECTRICAL SYMBOLS LEGEND

NOTE: EXISTING ELECTRIC AND LIGHTING CIRCUITS TO BE BYPASSED. NEW LIGHTS, NEW SWITCHES, NEW BREAKER LOCATION

○-S- CIRCUIT CONDUCTORS CONCEALED IN WALL OR ABOVE CEILING.

○-S- JUNCTION BOX MOUNTED ABOVE CEILING, OR AT EQUIPMENT.

○-S- SINGLE POLE SWITCH, 20A, 120 OR 277 VOLT, 44" AFF TO CENTER.

○-S- *3" INDICATES 3-WAY SWITCH.

○-S- *4" INDICATES 4-WAY SWITCH.

○-S- *M" INDICATES 120V OR 277V (SEE EQUIPMENT), 20A MOTOR RATED TOGGLE SWITCH.

○-S- EXISTING SWITCH TO REMAIN.

○-S- DUPLEX RECEPTACLE, 20 AMP, 120 VOLT, 18" AFF TO CENTER. UON. SINGLE RECEPTACLE CIRCUITS SHALL BE 20 AMP.

○-S- *GFI" INDICATES GROUND FAULT INTERRUPTER TYPE


○-S- *WP" INDICATES WEATHERPROOF

○-S- *IG" INDICATES ISOLATED GROUND

○-S- DATA OUTLET LOCATION, 18" AFF TO CENTER (PLATE ONLY FOR FUTURE); UON. PROVIDE EMPTY

○-S- 3/4" CONDUIT WITH PULL STRINGS STUBBED OUT MIN. 3" ABOVE OR BEYOND ACCESSIBLE CEILING. LABEL CONDUIT ABOVE CEILING WHERE ACCESSIBLE.

○-S- FIRE ALARM SYSTEM ALARM INDICATING DEVICE, HORN/STROBE.

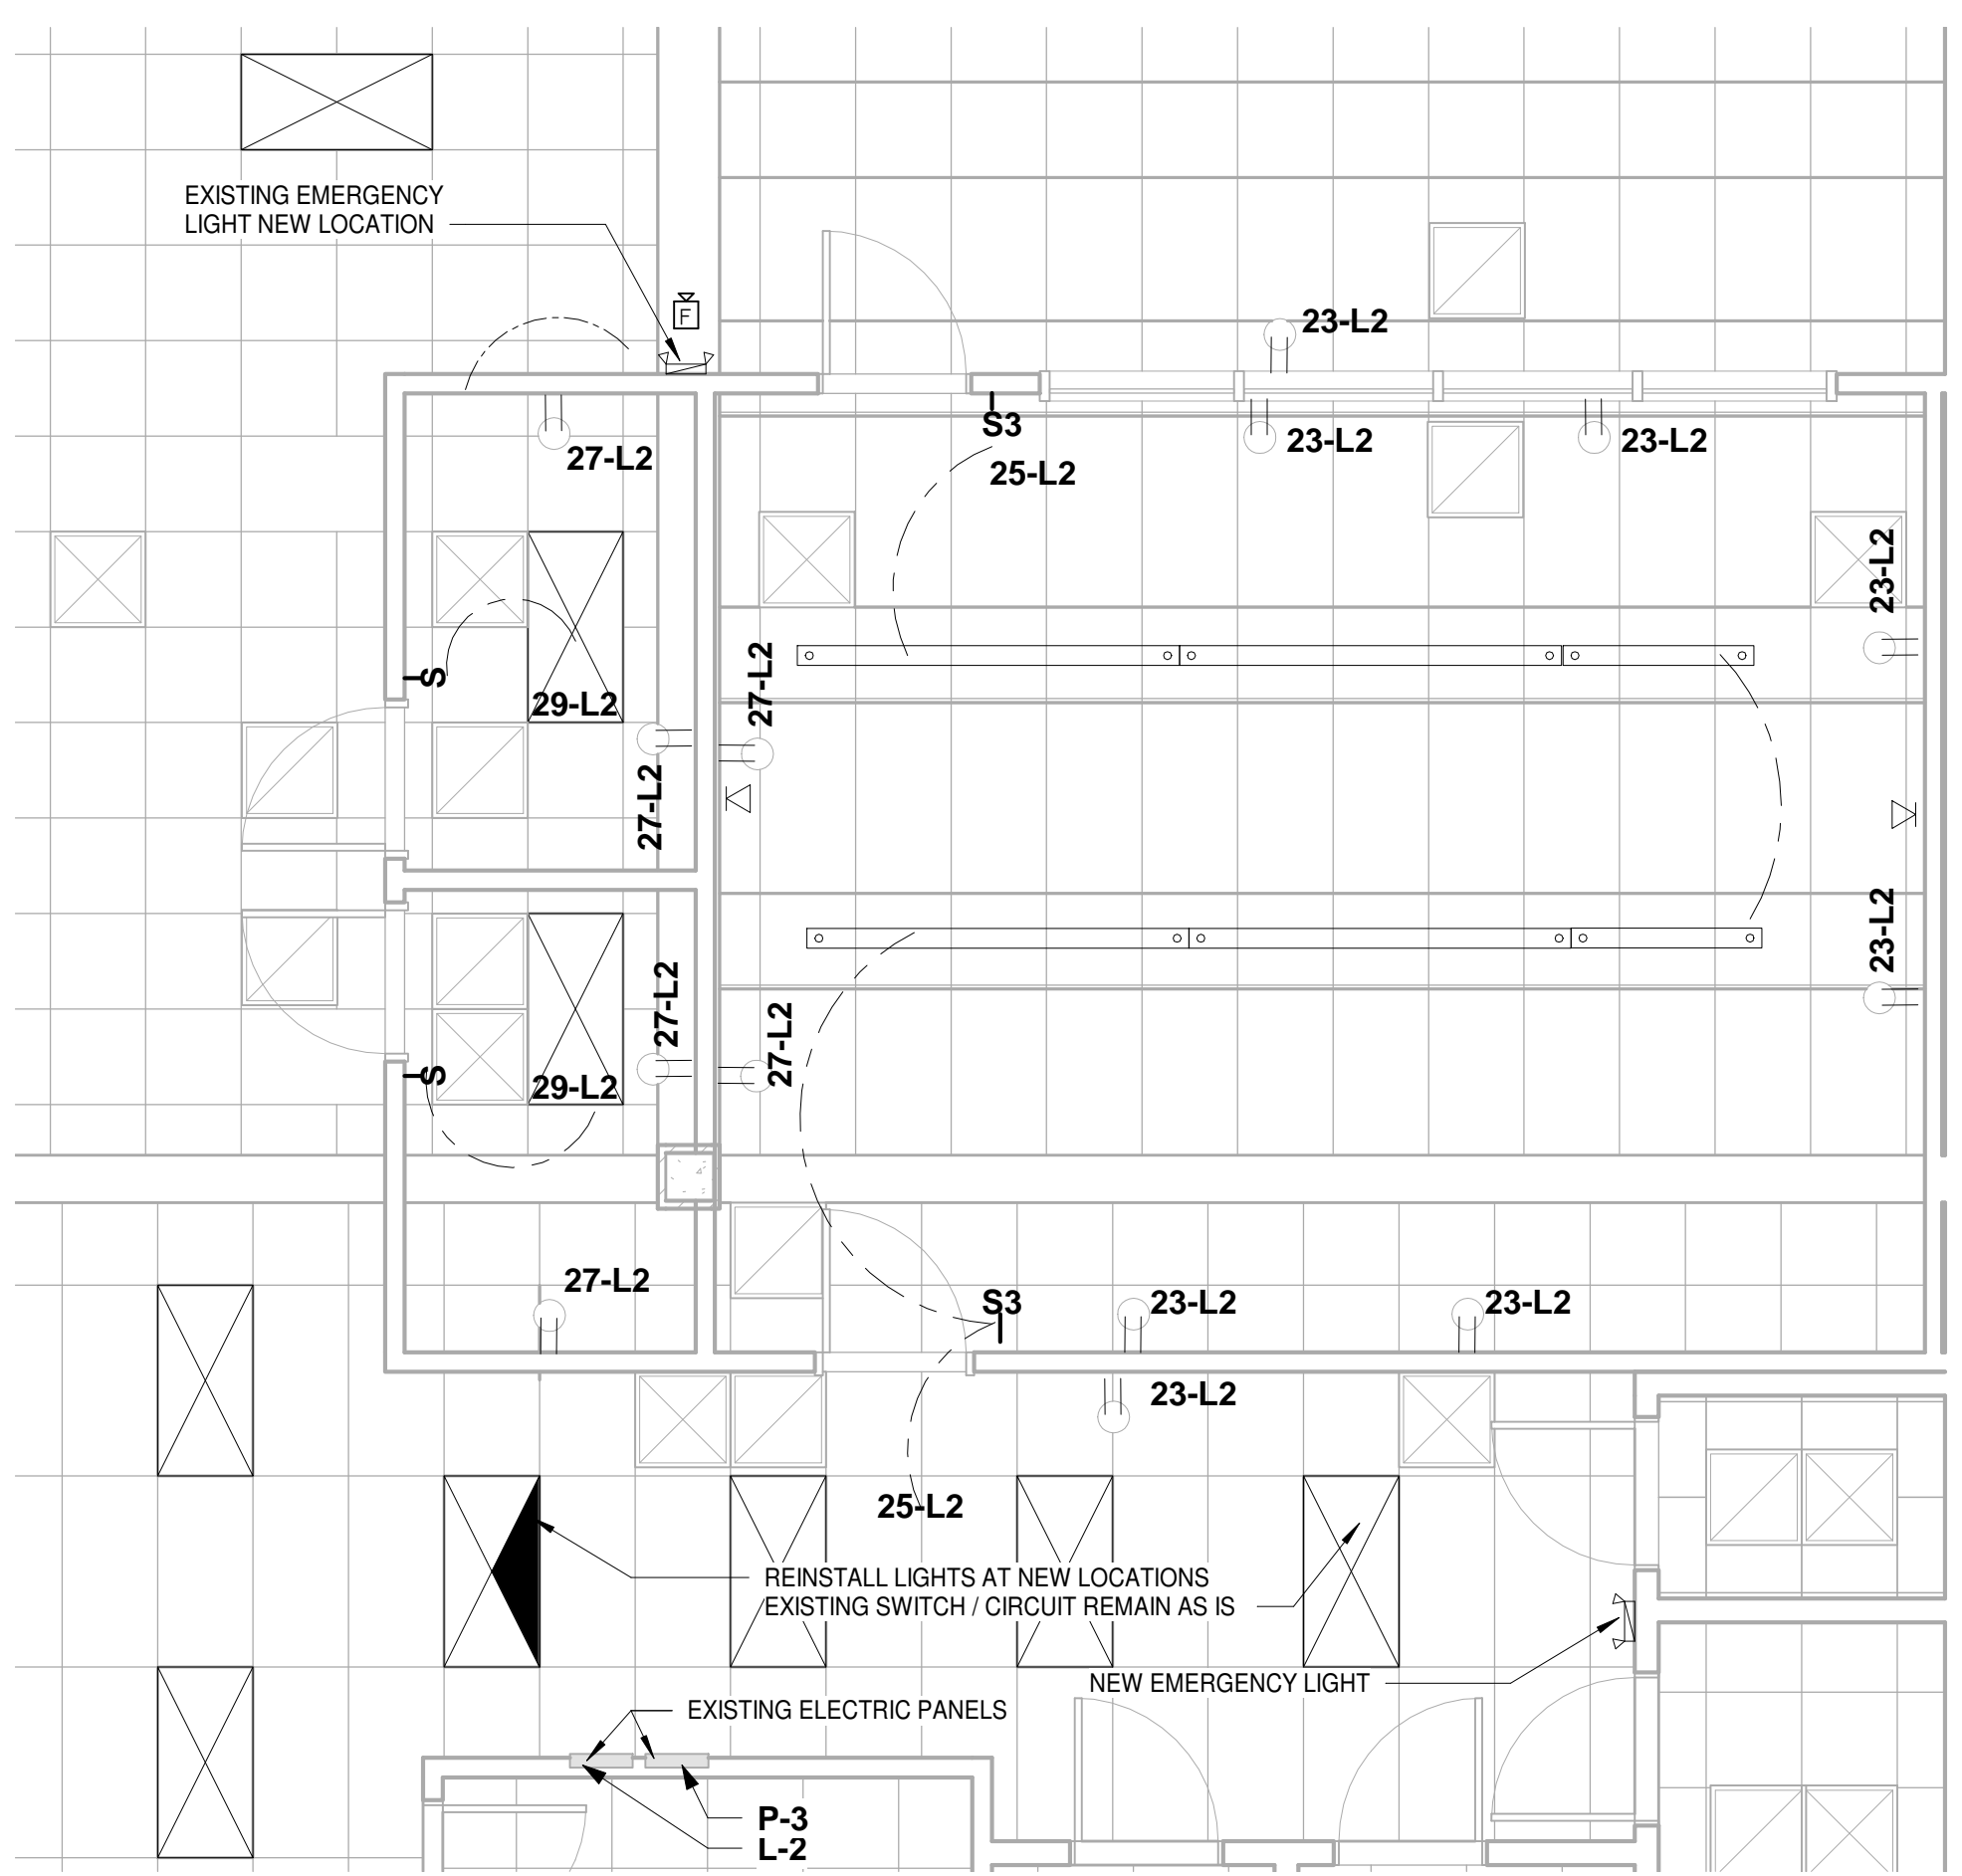

1
AE100 3/16" = 1'-0"

BRANCH PANEL: L2


LOCATION: CLASSROOM, STUDY ROOMS
 SUPPLY FROM: (TBD)
 MOUNTING: RECESSED
 ENCLOSURE: NEMA TYPE 1

VOLTS: 120/208 Wye
 PHASES: 3
 WIRES: 4

A.I.C. RATING:
 MAINS TYPE:
 MAINS RATING: 100 A
 MCB RATING: 100 A

NOTES: EXISTING ELECTRICAL PANEL & SERVICE

| CKT | CIRCUIT DESCRIPTION | TRIP | WIRE SIZE | WIRE TYPE | A | B | C | WIRE TYPE | WIRE SIZE | TRIP | CIRCUIT DESCRIPTION | CKT |
|-----------------------------|--------------------------|------|---------------------|-----------|---|---|---|-----------|---------------------|------|---------------------------|-----|
| 1 | EXISTING REMAIN | | | | | | | | | | EXISTING REMAIN | 2 |
| 3 | EXISTING REMAIN | | | | | | | | | | EXISTING REMAIN | 4 |
| 5 | EXISTING REMAIN | | | | | | | | | | EXISTING REMAIN | 6 |
| 7 | EXISTING REMAIN | | | | | | | | | | EXISTING REMAIN | 8 |
| 9 | EXISTING REMAIN | | | | | | | | | | EXISTING REMAIN | 10 |
| 11 | EXISTING REMAIN | | | | | | | | | | EXISTING REMAIN | 12 |
| 13 | EXISTING REMAIN | | | | | | | | | | EXISTING REMAIN | 14 |
| 15 | EXISTING REMAIN | | | | | | | | | | EXISTING REMAIN | 16 |
| 17 | EXISTING REMAIN | | | | | | | | | | EXISTING REMAIN | 18 |
| 19 | EXISTING REMAIN | | | | | | | | | | EXISTING REMAIN | 20 |
| 21 | EXISTING REMAIN | | | | | | | | | | EXISTING REMAIN | 22 |
| 23 | NEW OUTLETS IN CLASSROOM | 30 A | 1-#12, 1-#12, 1-#12 | CU-THWN | | | | CU-THWN | 1-#12, 1-#12, 1-#12 | 30 A | NEW OUTLETS IN YOUTH AREA | 24 |
| 25 | NEW LIGHTS IN CLASSROOM | 30 A | 1-#12, 1-#12, 1-#12 | CU-THWN | | | | | | | | 26 |
| 27 | NEW OUTLETS STUDY RMS. | 30 A | 1-#12, 1-#12, 1-#12 | CU-THWN | | | | | | | | 28 |
| 29 | NEW LIGHTS STUDY RMS. | 30 A | 1-#12, 1-#12, 1-#12 | CU-THWN | | | | | | | | 30 |
| TOTAL LOAD: EXISTING REMAIN | | | | | | | | | | | | |
| TOTAL AMPS: | | | | | | | | | | | | |

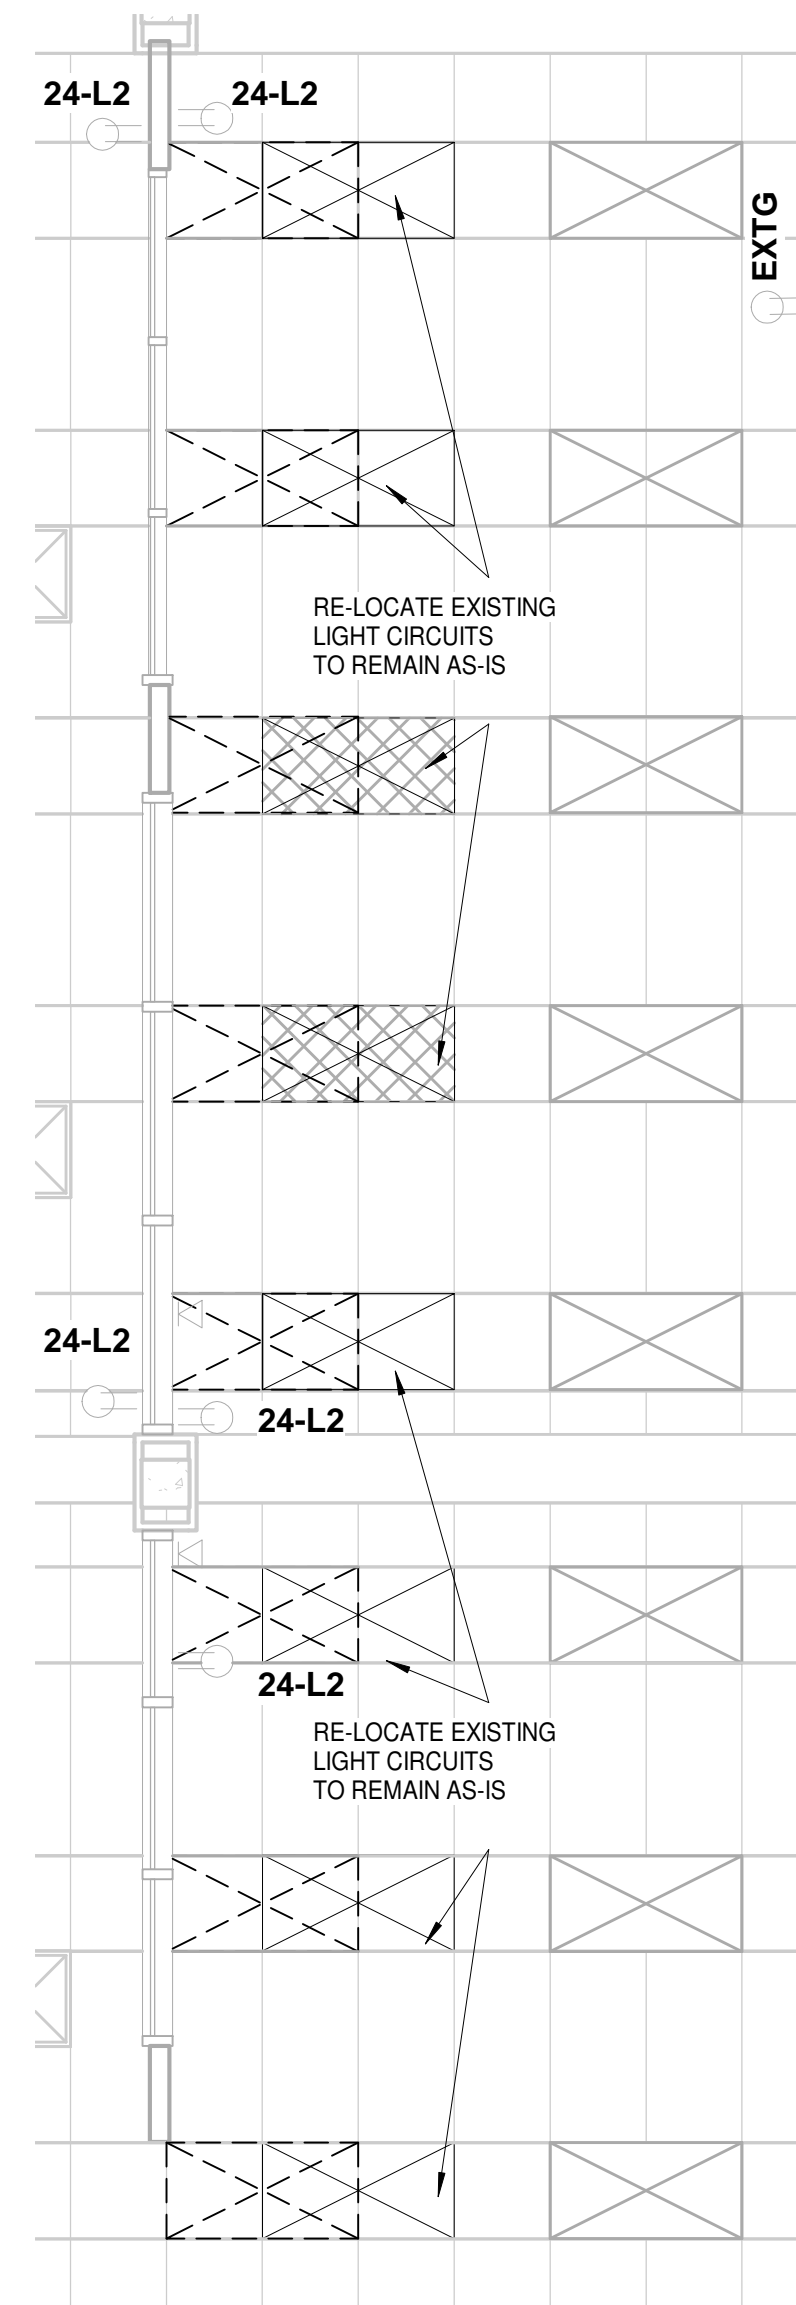

2
AE100 1/4" = 1'-0"

3
AE100 3/16" = 1'-0"

BRANCH PANEL: L1

LOCATION: CIRCULATION AREA
 SUPPLY FROM:
 MOUNTING: RECESSED
 ENCLOSURE:

VOLTS: 120/208 Wye
 PHASES: 3
 WIRES: 4

A.I.C. RATING:
 MAINS TYPE:
 MAINS RATING: 100 A
 MCB RATING: 100 A

NOTES: EXISTING ELECTRICAL PANEL & SERVICE

| CKT | CIRCUIT DESCRIPTION | TRIP | WIRE SIZE | WIRE TYPE | A | B | C | WIRE TYPE | WIRE SIZE | TRIP | CIRCUIT DESCRIPTION | CKT |
|-----------------------------|-------------------------------------|------|---------------------|-----------|---|---|---|-----------|-----------|------|-----------------------------------|-----|
| 1 | EXISTING REMAIN | | | | | | | | | | EXISTING REMAIN | 2 |
| 3 | EXISTING REMAIN | | | | | | | | | | EXISTING REMAIN | 4 |
| 5 | EXISTING REMAIN | | | | | | | | | | EXISTING REMAIN | 6 |
| 7 | EXISTING REMAIN | | | | | | | | | | EXISTING REMAIN | 8 |
| 9 | EXISTING REMAIN | | | | | | | | | | EXISTING REMAIN | 10 |
| 11 | EXISTING REMAIN | | | | | | | | | | EXISTING REMAIN | 12 |
| 13 | EXISTING REMAIN | | | | | | | | | | EXISTING REMAIN | 14 |
| 15 | EXISTING REMAIN | | | | | | | | | | EXISTING REMAIN | 16 |
| 17 | EXISTING REMAIN | | | | | | | | | | EXISTING REMAIN | 18 |
| 19 | EXISTING REMAIN | | | | | | | | | | EXISTING REMAIN | 20 |
| 21 | EXISTING REMAIN | | | | | | | | | | EXISTING REMAIN | 22 |
| 23 | EXISTING REMAIN | | | | | | | | | | EXISTING REMAIN | 24 |
| 25 | EXISTING REMAIN | | | | | | | | | | EXISTING REMAIN | 26 |
| 27 | EXISTING REMAIN | | | | | | | | | | EXISTING REMAIN | 28 |
| 29 | EXISTING REMAIN | | | | | | | | | | EXISTING REMAIN | 30 |
| 31 | EXISTING REMAIN | | | | | | | | | | EXISTING REMAIN | 32 |
| 33 | NEW OUTLETS IN CIRCULATION/OFFICE | 30 A | 1-#12, 1-#12, 1-#12 | | | | | | | | EXISTING REMAIN | 34 |
| 35 | NEW LIGHT IN CIRCULATION/OFFICE | 30 A | 1-#12, 1-#12, 1-#12 | | | | | | | | EXISTING REMAIN | 36 |
| 37 | NEW OUTLETS IN CIRCULATION/SHIPPING | 30 A | 1-#12, 1-#12, 1-#12 | | | | | | | | EXISTING REMAIN | 38 |
| 39 | NEW LIGHT IN CIRCULATION/SHIPPING | 30 A | 1-#12, 1-#12, 1-#12 | | | | | | | | EXISTING REMAIN | 40 |
| 41 | NEW LIGHT IN CIRCULATION/OFFICE | 30 A | 1-#12, 1-#12, 1-#12 | | | | | | | | NEW OUTLETS CIRCULATION CHECK OUT | 42 |
| TOTAL LOAD: EXISTING REMAIN | | | | | | | | | | | | |
| TOTAL AMPS: | | | | | | | | | | | | |

TAMARA PEACOCK, R.A.
 LICENSE NO. 12126

PROJECT NAME: Henderson Co. Public Library & 301 N. WASHINGTON ST. HENDERSONVILLE, NC 28792

PROJ. NO.: 1804 DATE: 8/3/2018
 DRAWN BY: DW REVISION BY: DW
 CAPT. BY: DW

ISSUED FOR: _____

REVISION: _____

REVISION DATE: _____

THE TAMARA PEACOCK COMPANY
Architects


104 1st Ave E. Hendersonville, NC 28792
 Phone: 828.696.4000 Fax: 954.728.9225

PROJECT NAME: Henderson Co. Public Library & 301 N. WASHINGTON ST. HENDERSONVILLE, NC 28792

SHEET NAME: ELECTRIC PLANS & NOTES

PROJ. NO.: 1804 DATE: 8/3/2018
 2:46:43 PM
 SHEET No.: AE100

BID SET
 7-2018

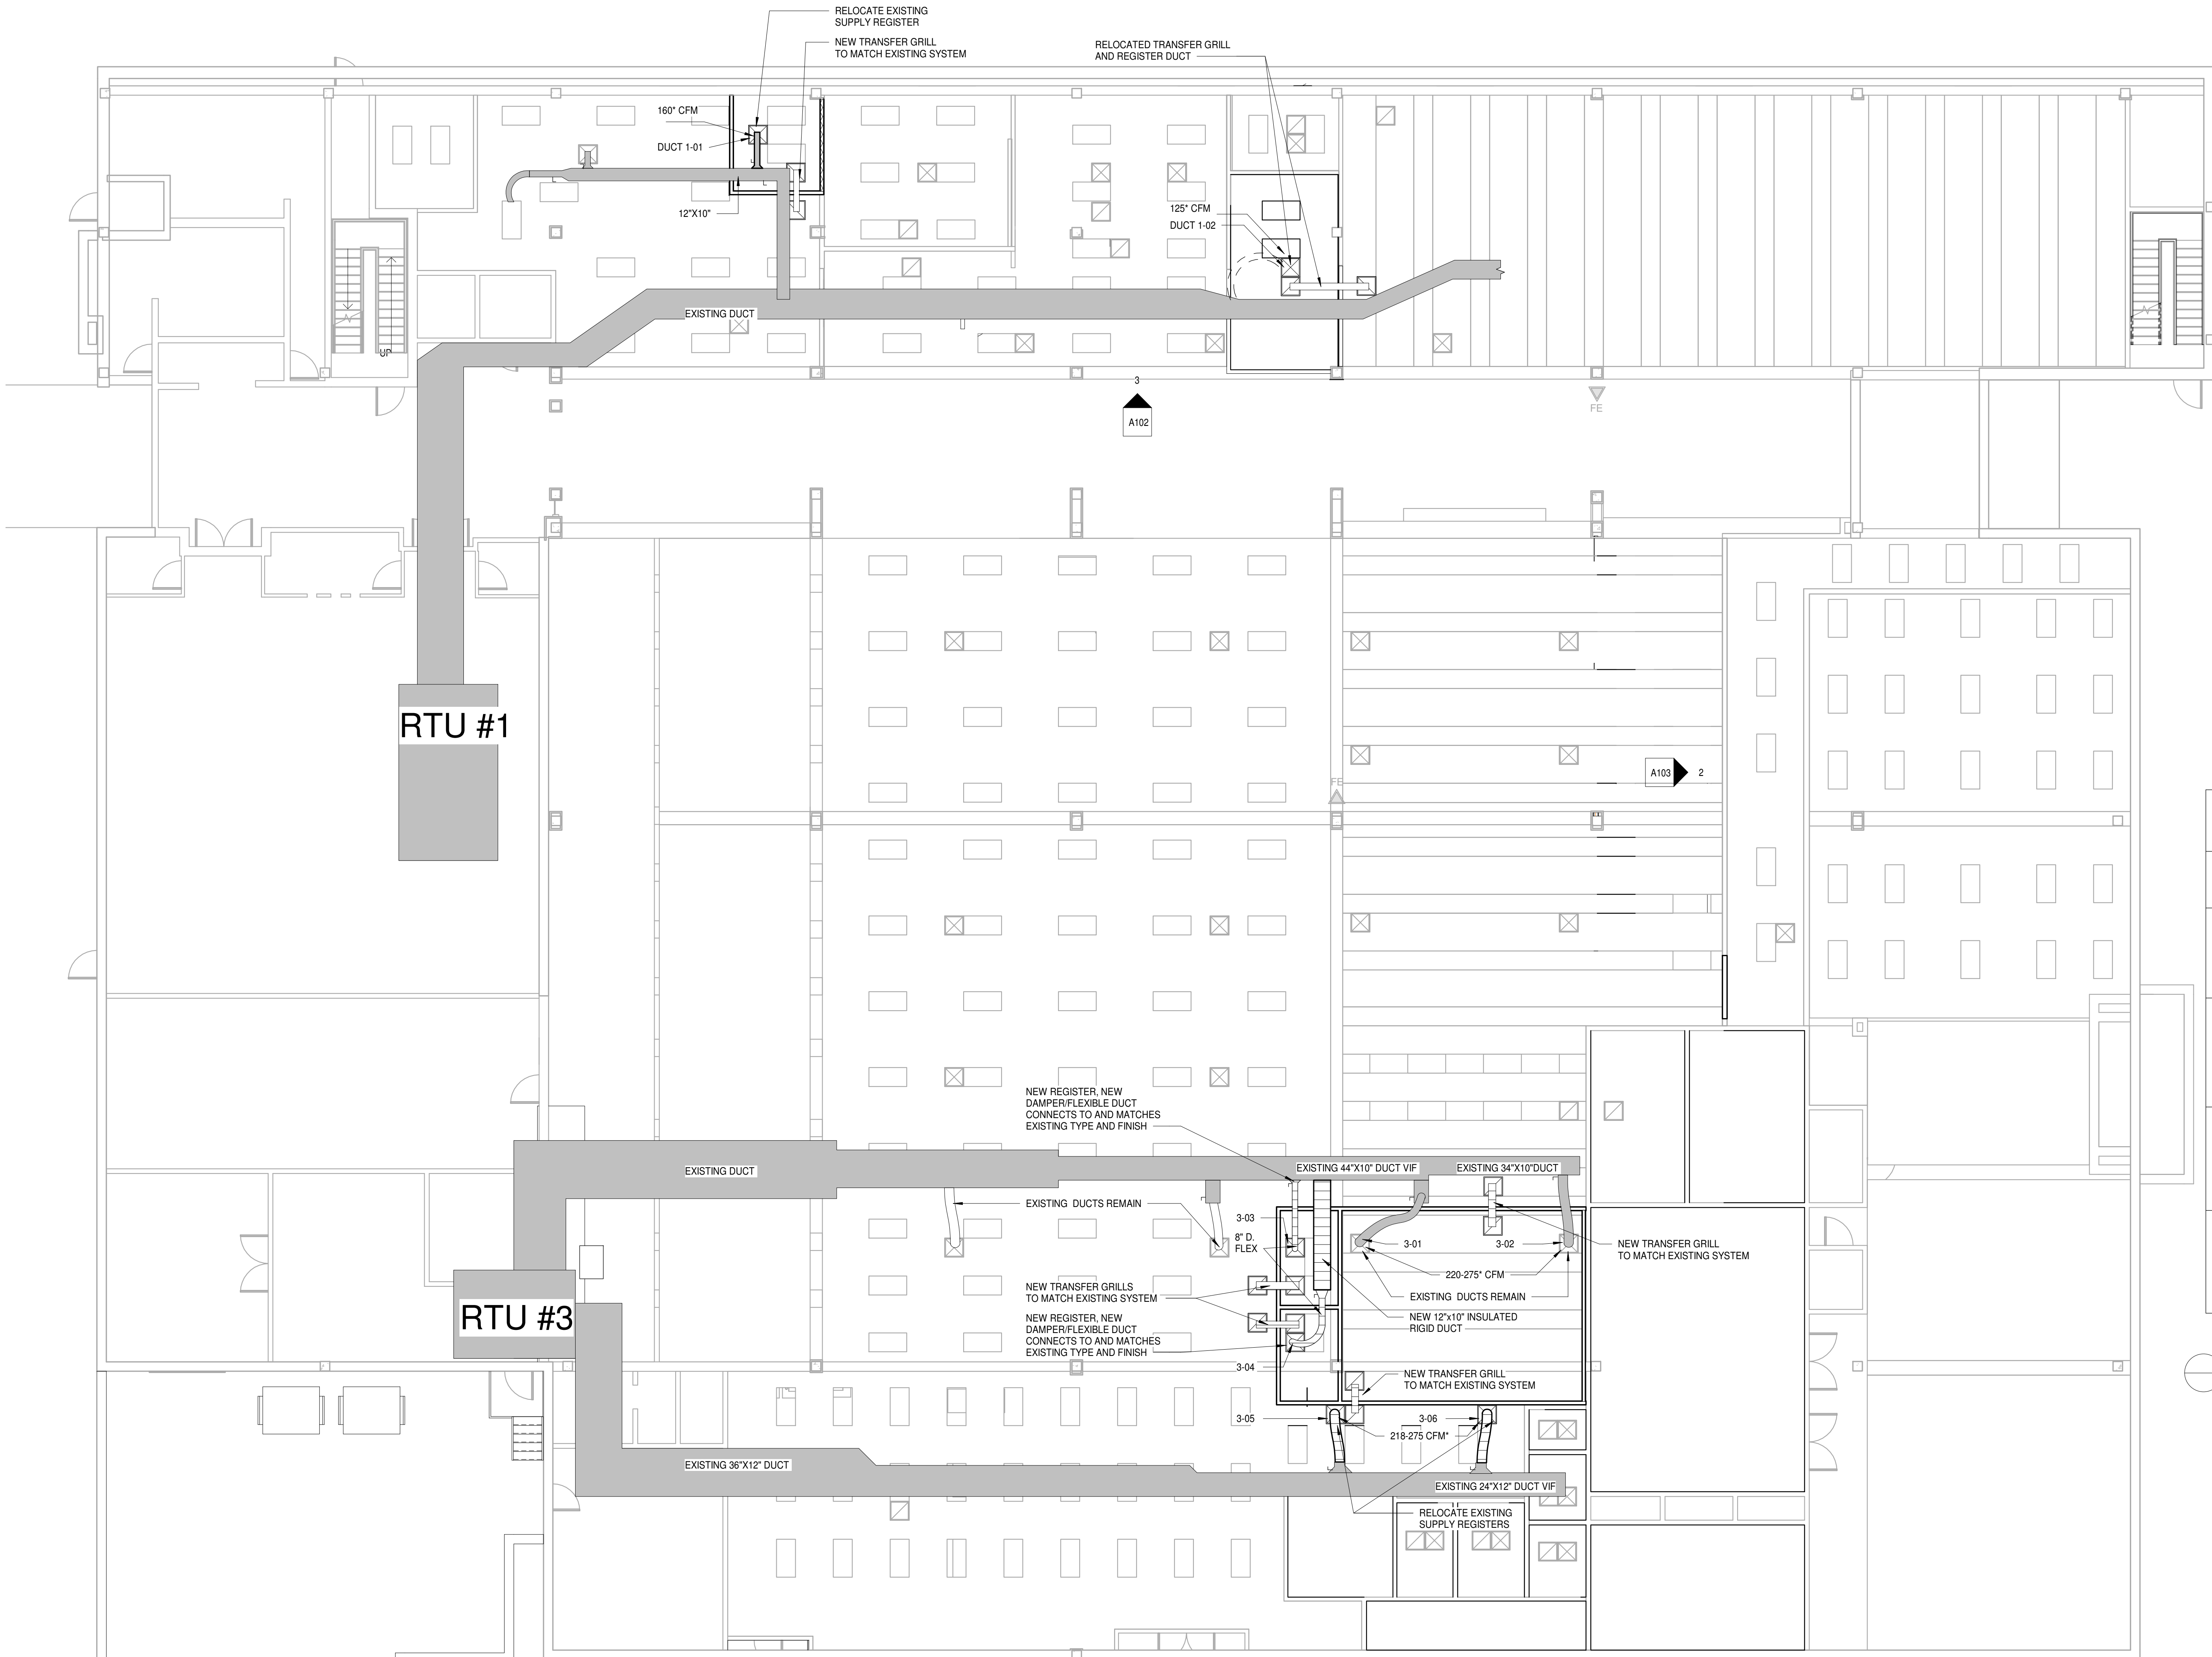

| | |
|--|-----------------------|
| | TRANSFER GRILL |
| | SUPPLY REGISTER |
| | NEW FLEXI DUCT |
| | EXISTING DUCTS REMAIN |
| | NEW RIGID INS. DUCT |
| | NEW DAMPER HANDLE |

HVAC DUCT LEGEND

MECHANICAL WORK AREAS
 1/8" = 1'-0" *NOTE: CFM DATA FOUND DURING 6/14/2018 INVESTIGATION. ACTUAL CFM AMOUNTS MAY VARY, FINAL CFM FLOW TO BE SET BY OWNER.

TAMARA PEACOCK, R.A.
 LICENSE NO. 12126

PROJ. DESIGNER
 CAPT. APPROVER

DRAWN BY: AUTHOR
 REVISED BY: CHECKER

| REVISION | REVISION DATE | ISSUED FOR |
|----------|---------------|------------|
| | | |

THE TAMARA PEACOCK COMPANY
Architects

104 1st Ave E, Hendersonville, NC 28792
 Phone: 828.696.4000 Fax: 954.728.9225

PROJECT NAME:
Henderson Co. Public Library
 301 N. WASHINGTON ST.
 HENDERSONVILLE, NC 28792

SHEET NAME:
HVAC UPFIT

PROJ. No. 1804 DATE: 8/3/2018
 2:46:44 PM


SHEET No. 1

AM001



BID SET
 7-2018

MECHANICAL NOTES

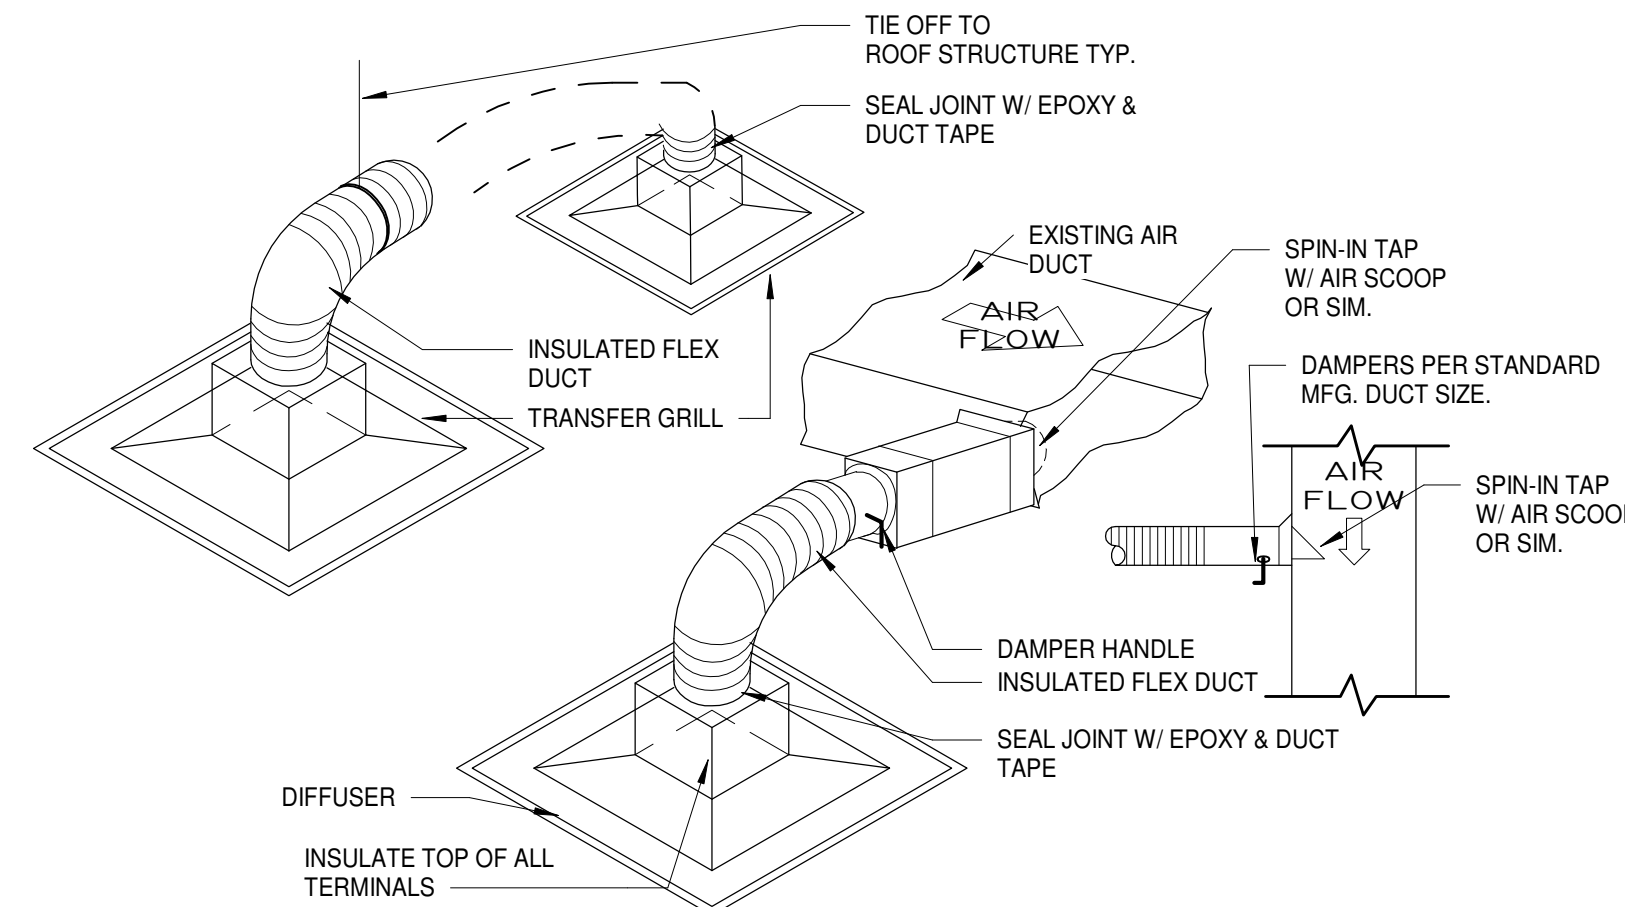

HVAC DUCT MODIFICATION

3/16" = 1'-0"

- ALL MATERIALS AND EQUIPMENT SHALL BE INSTALLED AND COMPLETED IN FIRST CLASS WORKMANLIKE MANNER. ANY MATERIALS INSTALLED, WHICH SHALL NOT PRESENT AN ORDERLY AND REASONABLY NEAT OR WORKMANLIKE APPEARANCE, SHALL BE REMOVED AND REPLACED WHEN SO DIRECTED BY THE ARCHITECT/ENGINEER AT THE CONTRACTOR'S EXPENSE.
- NEW DUCTWORK SHOWN IS SCHEMATIC. PLAN ROUTING OF DUCTWORK AND COORDINATE LOCATION OF DUCTS AFTER INSPECTION OF EXISTING CONDITIONS AND BEFORE FABRICATION. SLIGHT VARIATION OF ROUTING AND/OR CONSTRUCTION SHOULD BE ANTICIPATED AND IS EXPRESSLY INCLUDED AS PART OF THE WORK WHENEVER REQUIRED, AT NO ADDITIONAL COST TO OWNER. IGNORANCE ON THE PART OF THE CONTRACTOR WILL IN NO WAY EXCUSE HIM OR SHE FROM THE OBLIGATIONS AND RESPONSIBILITIES OF THIS CONTRACT.
- ANY CONFLICTS OR DISCREPANCIES ON THESE DRAWINGS SHALL BE CALLED TO THE ATTENTION OF THE ARCHITECT/ENGINEER DURING THE BIDDING PERIOD FOR RESOLUTION. OTHERWISE, ALL SUCH CONFLICTS OR DISCREPANCIES SHALL BE RESOLVED AT THE CONTRACTOR'S EXPENSE.
- ALL CONTROL WIRING SHALL BE PROVIDED BY THE CONTRACTOR.
- THE CONTRACTOR SHALL BE RESPONSIBLE FOR THE COORDINATION WITH ALL OTHER TRADES FOR CLEARANCES AND USE OF AVAILABLE SPACE.
- THE CONTRACTOR SHALL BE RESPONSIBLE FOR OBTAINING AND PAYING FOR ALL PERMITS, FEES, INSPECTIONS AND TESTS.
- THE CONTRACTOR SHALL FURNISH ALL LABOR, MATERIALS, EQUIPMENT AND SERVICES NECESSARY FOR THE INSTALLATION OF A COMPLETE MECHANICAL SYSTEM, READY FOR CONTINUOUS AND SATISFACTORY OPERATION BY THE OWNER.
- THE ENTIRE INSTALLATION SHALL COMPLY WITH ALL APPLICABLE NATIONAL, STATE AND LOCAL CODES, INCLUDING ALL LOCAL RULES AND ORDINANCES.
- PROVIDE MANUAL DAMPERS WHERE SHOWN ON THE DRAWINGS. DAMPERS SHALL BE MANUFACTURED ACCORDING TO SMACNA "HVAC DUCT CONSTRUCTION STANDARDS METAL AND FLEXIBLE" FIRST EDITION AND SHALL HAVE LOCKING QUADRANT WITH WING NUT.
- ALL SUPPLY DUCTWORK SHALL BE CONSTRUCTED OF FIBERGLASS, INSTALLED IN ACCORDANCE WITH SMACNA "HVAC DUCT CONSTRUCTION STANDARDS".
- PROVIDE INSULATION ON ALL S/A AND R/A DUCT. FIBERGLASS FLEXIBLE BLANKET WRAP, COMPOSED OF FLEXIBLE BLANKET OF GLASS FIBER FACTORY LAMINATED TO A REINFORCED FOIL KRAFT (FRK) VAPOR BARRIER WITH A MINIMUM 2-INCH TAPING AND STAPLING FLANGE ON ONE EDGE, SUITABLE FOR OPERATION AT TEMPERATURES FROM 40F TO 250F. THERMAL CONDUCTIVITY OF 0.31 AT 75F. MINIMUM DENSITY OF THREE-QUARTER (3/4) POUND PER CUBIC FOOT. PROVIDE IN THICKNESS OF TWO (2) INCHES. OWENS-CORNING ALL SERVICE FACED DUCT WRAP; MANVILLE R-SERIES MICROLITE; CERTAINTED STANDARD DUCT WRAP; OR EQUIVALENT.
- ALTERNATE DUCTWORK MATERIAL SUPPLY AIR DUCTWORK SHALL BE CONSTRUCTED OF FIVE POUNDS DENSITY 1-1/2" THICK GLASSFIBER DESIGNED, CONSTRUCTED AND INSTALLED IN ACCORDANCE WITH SMACNA'S LOW PRESSURE DUCT MANUAL. ALL DUCT JOINTS SHALL BE SEALED AND TAPED.
- ALL EXHAUST DUCTWORK SHALL BE CONSTRUCTED OF FIBERGLASS, INSTALLED IN ACCORDANCE WITH SMACNA "HVAC DUCT CONSTRUCTION STANDARDS".
- FLEXIBLE DUCTS SHALL BE UL LISTED CLASS I AIR DUCT. THERMAFLEX TYPE MAKE OR EQUAL. DUCTS SHALL BE INSTALLED IN ACCORDANCE WITH SMACNA "HVAC DUCT CONSTRUCTION STANDARDS METAL AND FLEXIBLE" FIRST EDITION.
- DUCTWORK DIMENSIONS INDICATED, ARE INSIDE CLEAR AIR PASSAGE. ALL EQUIPMENT AND MATERIAL SHALL BE WARRANTIED FOR ONE YEAR AFTER DATE OF ACCEPTANCE BY THE OWNER.
- AIR DISTRIBUTION DEVICES SHALL BE OF ALL ALUMINUM CONSTRUCTION WITH TYPE #25 FINISH. ALL DIFFUSERS, REGISTERS AND GRILLS SHALL HAVE OPPOSED BLADE DAMPERS IN THROAT OR NECK. MANUFACTURER SHALL BE PRICE OR PRE-APPROVED EQUAL.
- THE INSIDE OF ALL VISIBLE DIFFUSERS SHALL BE PAINTED BLACK.
- ALL FRESH AIR DUCTWORK SHALL BE CONSTRUCTED OF GALVANIZED SHEETMETAL, INSTALLED IN ACCORDANCE WITH SMACNA "HVAC DUCT CONSTRUCTION STANDARDS METAL AND FLEXIBLE, FIRST EDITION".

EXISTING MECHANICAL EQUIPMENT

| RTU | MODEL/SN | MANUFACTURER | DESCRIPTION | CFM | RPM | HEAT PUMP | VOLTAGE | TERMINAL MARK | ROOM @ DUCT | EXISTING CFM @ DUCT | NEW CFM @ DUCT | SIZE OF TRUNK @ DUCT SPLICE | SIZE OF FLEX @ REG. | NOTES: |
|-------|---------------------------------------|--------------|-----------------------------|------|------|-----------|----------|---------------|-------------------------|---------------------|----------------|-----------------------------|---------------------|--------|
| RTU-1 | MN-SC130483CD SN: 1506013255 | DAIKIN | EXISTING ROOFTOP UNIT (VIF) | 8000 | 1020 | 7 1/2 | 208/60/3 | 1-01 | CIRCULATION OFFICE | 190-125 CFM | TBD | 12"X10" | 9" DIAM. | 1 |
| RTU-1 | -- | DAIKIN | -- | -- | -- | -- | -- | 1-02 | CIRCULATION RECEIVABLES | 125 CFM | TBD | 8"X 8" | 6" DIAM. | 1,2 |
| RTU-3 | MN-1510111814 SN: DCG1592103BXXXXA | DAIKIN | -- | 6000 | 760 | 5 | 208/60/3 | 3-01 | CLASSROOM | 220-275 CFM | NO CHANGE VIF | 44"X10" | TBD | 3 |
| RTU-3 | -- | DAIKIN | -- | -- | -- | -- | -- | 3-02 | CLASSROOM | 220-275 CFM | NO CHANGE VIF | -- | TBD | 3 |
| RTU-3 | -- | DAIKIN | -- | -- | -- | -- | -- | 3-03 | STUDY RM 01 | 220-275 CFM | TBD | -- | -- | 4 |
| RTU-3 | -- | DAIKIN | -- | -- | -- | -- | -- | 3-04 | STUDY RM 02 | 220-275 CFM | TBD | -- | -- | 4 |
| RTU-3 | -- | DAIKIN | -- | -- | -- | -- | -- | 3-05 | STUDY ROOMS HALL | 220-275 CFM | NO CHANGE VIF | 24"X12" | 10" DIAM. | 1,2 |
| RTU-3 | -- | DAIKIN | -- | -- | -- | -- | -- | 3-06 | STUDY ROOMS HALL | 220-275 CFM | NO CHANGE VIF | 24"X12" | 10" DIAM. | 1,2 |

- NOTES:
- RELOCATION OF EXISTING REGISTER TO NEW LOCATION.
 - CFM DATA GATHERED FIELD VERIFICATION AT DUCTS ON DATE: 6-14-2018, FINAL CFM AMOUNTS MAY VARY, ADJUST DAMPERS PER DESIRED AMOUNT.
 - EXISTING DWG SET PROVIDES NO DATA AT THIS LOCATION. FIELD VERIFY WHERE REQUIRED.
 - NEW DUCT, SPLICING INTO TRUNK. VERIFY CFM AND BALANCE AFTER COMPLETION.

TAMARA PEACOCK, R.A.
LICENSE NO. 12126

PROJ. DESIGNER
CAPT. APPROVER

DRAWN BY
REVIEWED BY
CHECKER

| ISSUED FOR | REVISION DATE | REVISION |
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| | | |
| | | |

THE TAMARA PEACOCK COMPANY
Architects

104 1st Ave E, Hendersonville, NC 28792
Phone: 828.696.4000 Fax: 954.728.9225

PROJECT NAME:
Henderson Co. Public Library
301 N. WASHINGTON ST.
HENDERSONVILLE, NC 28792

SHEET NAME:
MECHANICAL SCHEDULES AND NOTES

PROJ. NO. 1804
DATE: 8/3/2018
SHEET NO.: 246445
PM

AM002

**BID SET
7-2018**